SHEET INDEX	CONSULTANTS	PROJECT SUMMARY			
ARCHITECTURAL: A-1.1		PROJECT DESCRIPTION: NEW PROPOSED SINGLE STORY HOUSE W/ 3-CAR ATTACHED PARKING GARAGE AND DETACHED BBQ CANOPY LEGAL DESCRIPTION: TRACT # 18923 LOT COM E ON S LINES OF LOT 24, 5.09 FT FROM SW COR OF SD LOT TH N 40 15' 46" W 43.68 FT TH N 70 53' 12" W 80.21 FT TH E ON S LINE OF LAMER ST SEE MAPBOOK FOR MISSING PORTION LOT 25 APN = 2471 - 034 - 007 ZONE = R1 OCCUPANCY = R-3 / U TYPE OF CONSTRUCTION = V-B (FULLY SPRINKLERED) NUMBER OF STORIES = 1 CA CLIMATE ZONE = 9 HIGH FIRE ZONE = YES FIRE SPRINKLER = YES EXISTING LOT AREA = 11,430 s.f. FLOOR AREA: ALLOWABLE FLOOR AREA = (40%) 7,500 s.f. + (30%)3,930 = 4,179 s.f. EXISTING FLOOR AREA (TO BE REMOVED) = 2,068 s.f. PROPOSED GROSS FLOOR AREA = 3,920 s.f. PROPOSED REAR LOGGIA CANOPY AREA = 55 s.f. PROPOSED REAR LOGGIA CANOPY AREA = 1444 s.f. LESS 400 s.f. GARAGE = -400 s.f. PROPOSED NET FLOOR AREA = 4,022 s.f.	LOT COVERAGE: ALLOWABLE LOT COVERAGE = (50%) 11,430 s.f. = 5,715 s.f. PROPOSED GROSS FLOOR AREA = 3,920 s.f. PROPOSED ENTRY CANOPY AREA = 55 s.f. PROPOSED REAR LOGGIA CANOPY AREA = 303 s.f. PROPOSED REAR BBQ CANOPY AREA = 144 s.f. PROPOSED NET FLOOR AREA = 4,422 s.f. = 38.68% BUILDING SET BACKS: REQUIRED FRONT SET BACK = 22'-11" (Block Average) EXISTING FRONT SET BACK = 25'-0" PROPOSED FRONT SET BACK = 25'-0" REQUIRED REAR SET BACK = 15'-0" EXISTING REAR SET BACK = 15'-0" EXISTING REAR SET BACK = 28'-0" REQUIRED INTERIOR SIDE SET BACK = 9'-10" BUILDING HEIGHT: ALLOWABLE MAX. BUILDING HEIGHT = 23'-0" (to Top of Flat Roof Parapet) PROPOSED MAX. BUILDING HEIGHT = 20'-0" (to Top of Plate) PROPOSED MAX. BUILDING HEIGHT = 13'-0" (to Top of Plate)	NOTE: FINISH GRADE AROUND THE STRUCTURE/ADDITION SEROM THE FOUNDATION A MINIMUM OF 5% FOR A MI OF 10 FEET ZONING NOTES: 1- NO NEW ROOFTOP EQUIPMENT IS ALLOWED 2- THE FOLLOWING ITEMS SHALL BE ON A SEPARATE RETAINING WALLS / BOUNDARY WALLS POOLS / SPAS / JACUZZIS FENCES / TRELLIS / PATIO COVERS GRADING / DRAINAGE / EROSION FIRE SPRINKLERS	NIMUM DISTANCE
	<u></u>	PROPOSED THREE-CAR GARAGE = 554 s.f.	PLOT	PLAN (3/32"= 1'-0")	VICINITY MAP
SHALL BE PLACED IN A POSITION THAT IS PLAINLY LE ALLEY, AND WALKWAYS GIVING ACCESS TO AND WITH CONTRAST WITH THEIR BACKGROUND. ADDRESS NUT ALPHABET LETTERS. NUMBERS SHALL BE A MINIMUM A MINIMUM STROKE WIDTH OF 0.5 INCH (12.7 MM) AND MANNER (IF NUMBERS ARE ON THE EXTERIOR). NUMBERS ARE ON THE EXTERIOR. NUMBERS AS NEEDED FOR LEGIBILITY BASED ON V. 2. FIRE SPRINKLERS: PROVIDE A COMPLETE AUTOMATIC FIRE SPRINKLER SINSTALLED IN ACCORDANCE WITH THE RECOMMENDATE OF THE BURBANK FIRE DEPARTMENT. FIRE SPRINKLES OF THE BURBANK OF THE BUILDING PERMIT. 3. SMOKE DETECTORS:	THIN THE PROPERTY. THESE NUMBERS SHALL JMBERS SHALL BE ARABIC NUMERALS OR M OF FOUR (4) INCHES (102 MM) HIGH WITH D SHALL BE ILLUMINATED IN AN APPROVED IBER HEIGHT AND STROKE WIDTH SHALL BE JISIBILITY DISTANCE. SYSTEM THROUGHOUT THE STRUCTURE DATIONS OF NFPA 13D AND THE REQUIREMENTS LER PLANS SHALL BE SUBMITTED WITHIN				Highland View Dr. S. Highland
SMOKE DETECTORS SHALL BE WIRED TO THE BUILDING BATTERY BACKUP AND EMIT A SIGNAL WHEN BATTER INTERCONNECTED SO THAT THE ACTIVATION OF ONE CARBON MONOXIDE DETECTORS: SHALL BE INSTALLED OUTSIDE OF EACH SEPARATE DIVICINITY OF THE BEDROOM(S) AND ON EVERY LEVEL ALARMS SHALL BE HARDWIRED FROM THE BUILDING BACKUP. DETECTORS SHALL MEET U.L. 2034 AND/OR RESIDENTIAL CODE CHAPTER 3 SEC R315 FUEL MODIFICATION / LANDSCAPING FOR HIGH FIRE IN MAINTAIN EXISTING / PROVIDE FUEL MODIFICATION OF PERMITTING OF LANDSCAPE PLANS	RIES ARE LOW. SMOKE ALARMS SHALL BE E ALARM WILL ACTIVATE ALL OTHER ALARMS. DWELLING UNIT SLEEPING AREA IN THE IMMEDIATE OF A DWELLING UNIT INCLUDING BASEMENTS. POWER SUPPLY AND EQUIPPED WITH BATTERY NFPA 720 STANDARDS. 2013 CALIFORNIA HAZARD AREAS (HFHA):				GENERAL BUILDING SECTION NUMBER/LETTER SHEET WHERE DRAWN PARTIAL SECTION OR PARTIAL DETAIL NUMBER SHEET WHERE DRAWN FLOOR LEVEL OF DOOR DOOR NUMBER FLOOR LEVEL OF WINDOW WINDOW NUMBER
FIRE PERMITS: THE FOLLOWING PERMITS ARE REQUIRED FROM THE FIRE SPRINKLER REQUIRED FIRE DEPARTMENT INSPECTIONS FOR THI FOR ALL INSPECTIONS CALL FIRE SPRINKLER OVERHEAD/UNDERGROUND ROUGH FIRE SPRINKLER FINAL FIRE PREVENTION BUREAU FINAL (ADDRESS SIGNS, E SMOKE DETECTOR, FUEL MODIFICATION, ETC)	IIS PROJECT ARE LISTED BELOW. H AND FLUSH (BEFORE COVERING ANY PIPING)				123 ROOM REFERENCE
				O THE STRUCTURE/ADDITION SHALL SLOPE AWAY FROM NIMUM OF 5% FOR A MINIMUM DISTANCE OF10 FEET	ONE LAYER OF 5/8" TYPE "X" GYP. BD. EA. SIDE OF 2X @ 16" O.C. PROVIDE 2X6 STUDS @ PLUMBING WALLS W/ R15 INSULATION 1-HR FIRE RATED WALL: ONE LAYER OF 5/8" TYPE "X" GYP. BD. EA. SIDE OF 2X @ 16" O.C. (FOR WALL SEPARATING GARAGE FROM LIVING SPACE) A.D. AREA DRAIN 4"Ø DRAIN PIPE TO STREET 2% MIN. SLOPE (TYP) DDS DOWN SPOUT



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CLIENT:

Mr. and Mrs. Ekmekchian 3130 N Lamer St. Burbank, Ca. 91504

PROJECT:

Ekmekchian Residence

3130 N Lamer St. Burbank, Ca. 91504

REVISIONS

DESCRIPTION DATE BY

COVER PAGE DATA / INDEX

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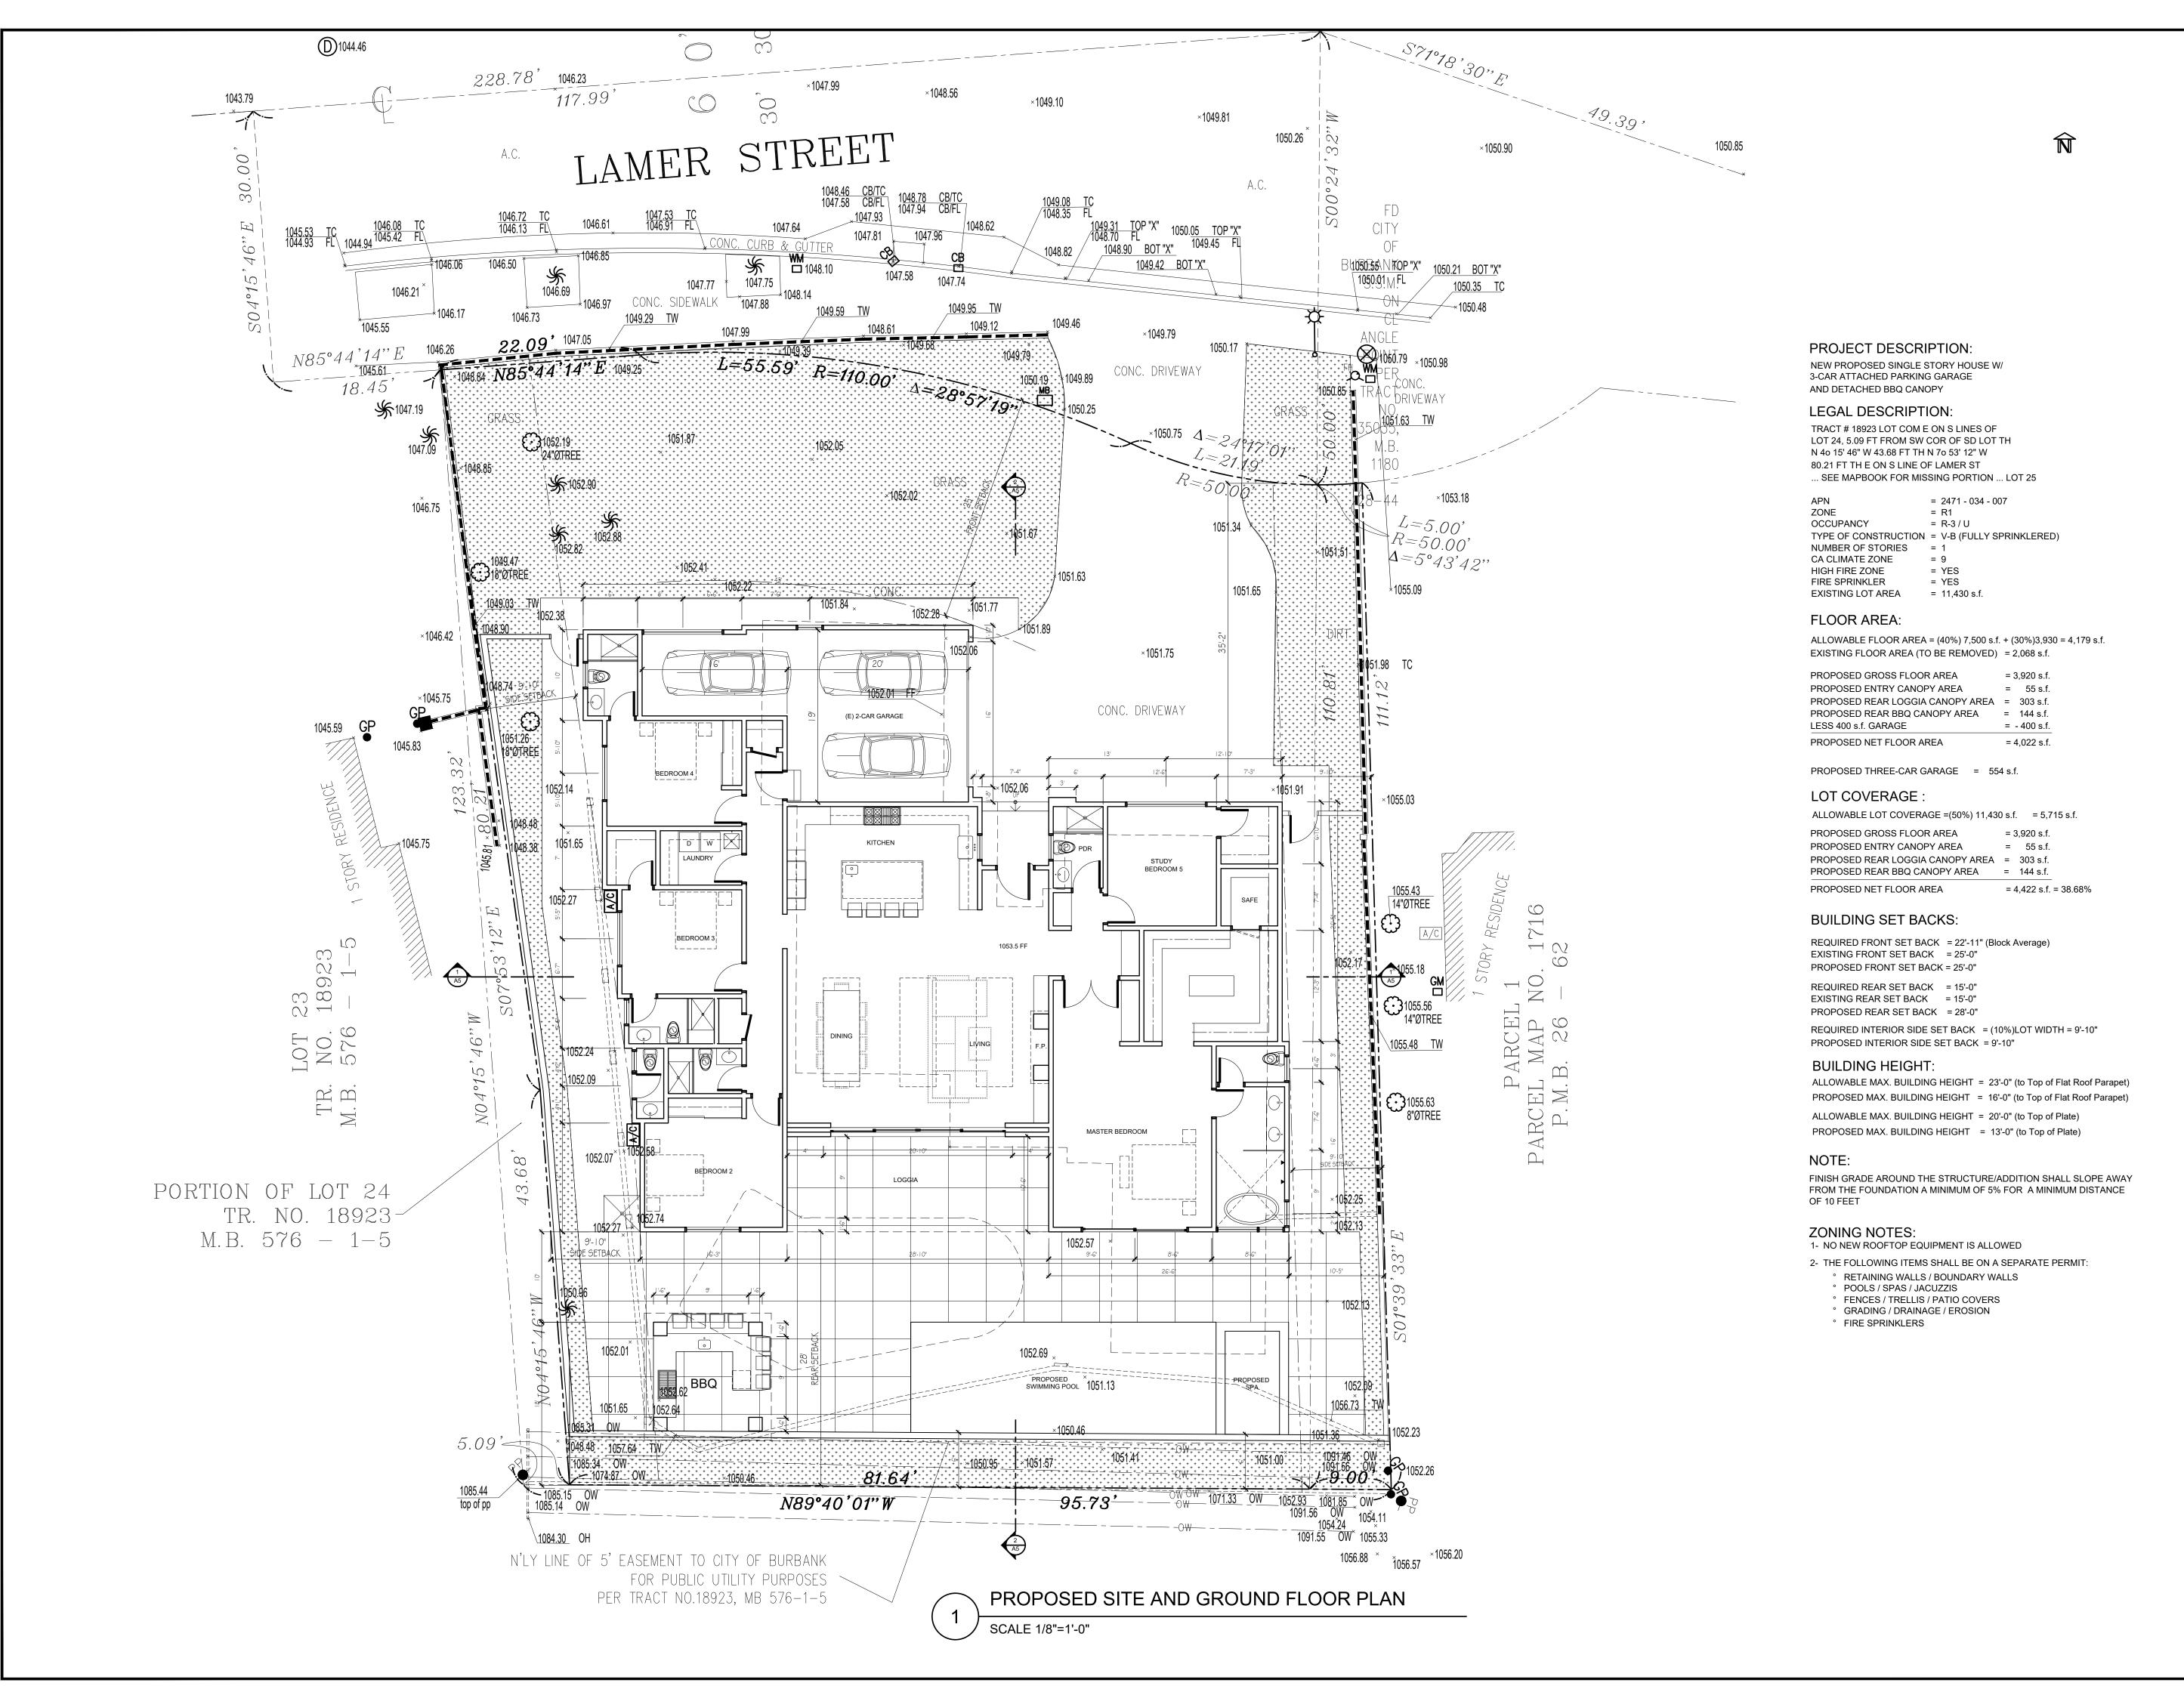
 DATE
 05.08.23

 SCALE
 N.T.S.

 DRAWN BY
 HZ

 JOB NUMBER
 011222

A1.1





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PROJECT:

Burbank, Ca. 91504

Ekmekchian Residence 3130 N Lamer St.

> REVISIONS DN DATE


DESCRIPTION DATE BY

SHEET TITLE:

SITE AND GROUND FLOOR PLAN

DATE	05.08.23
SCALE	1/8" = 1'-0"
DRAWN BY	HZ
JOB NUMBER	011222
SHEET	

A2

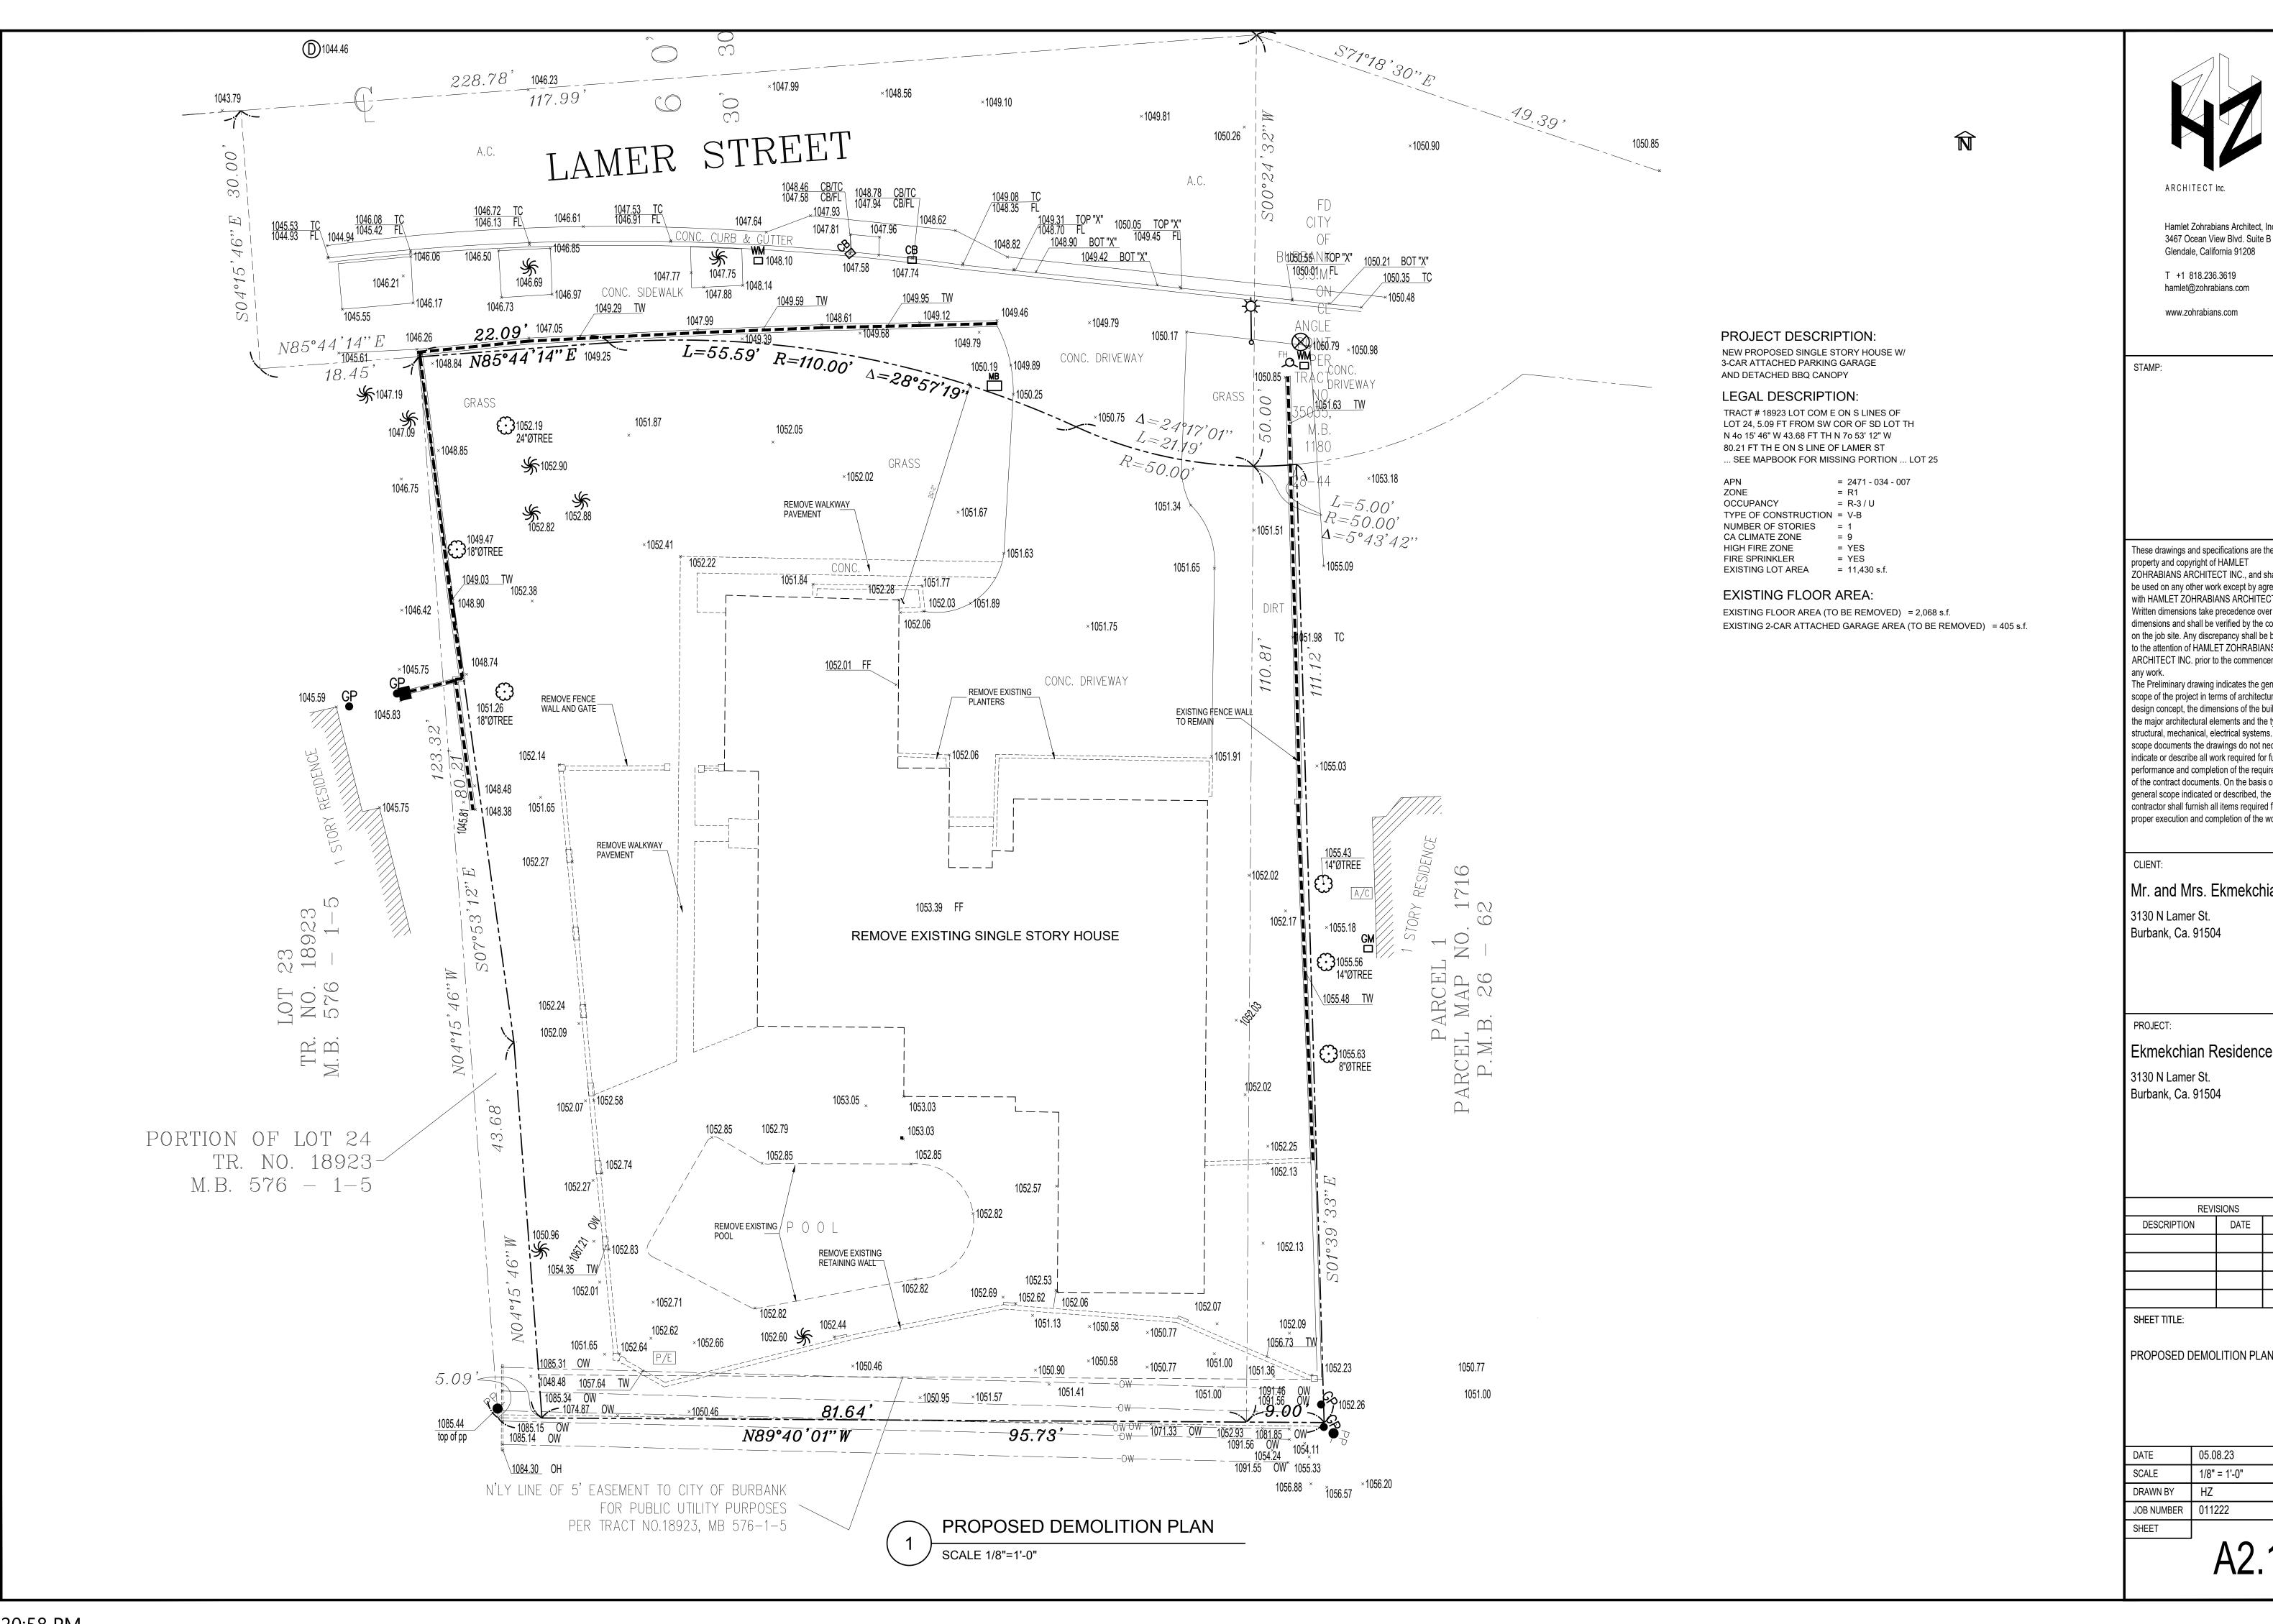



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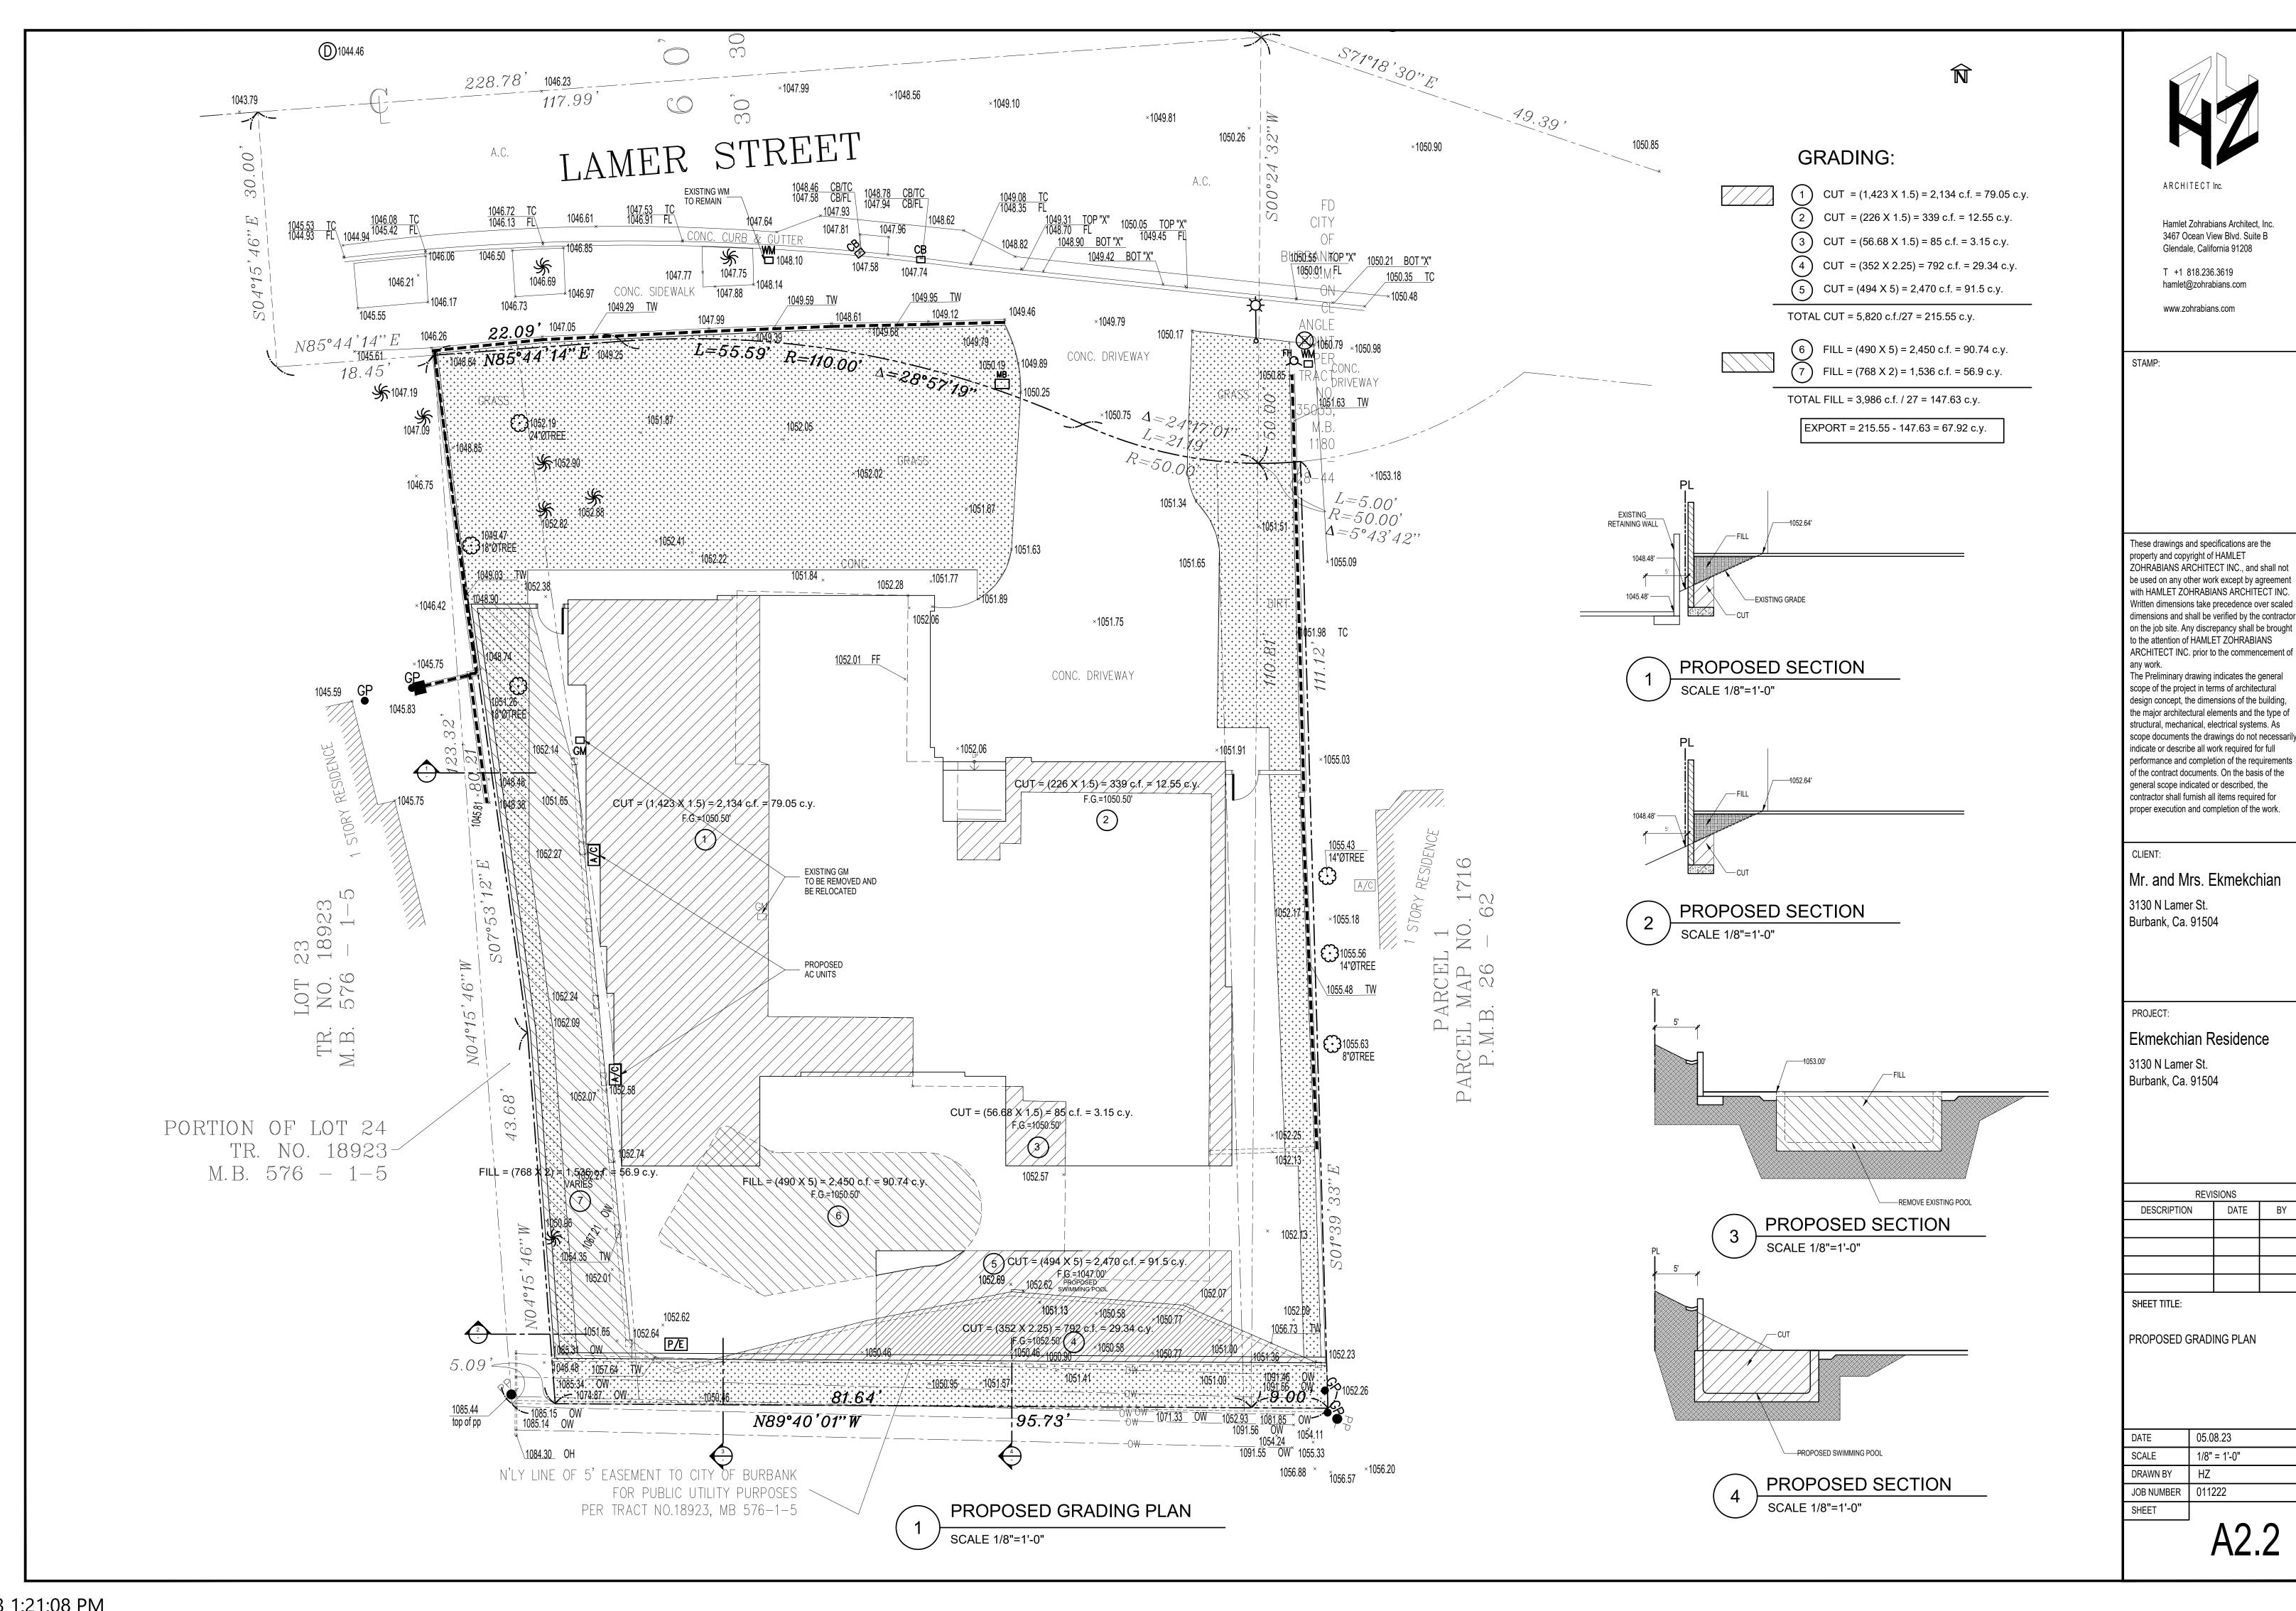
Mr. and Mrs. Ekmekchian 3130 N Lamer St. Burbank, Ca. 91504

Ekmekchian Residence


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SCALE	1/8" = 1'-0"
DRAWN BY	HZ
JOB NUMBER	011222
SHEET	


A2.1





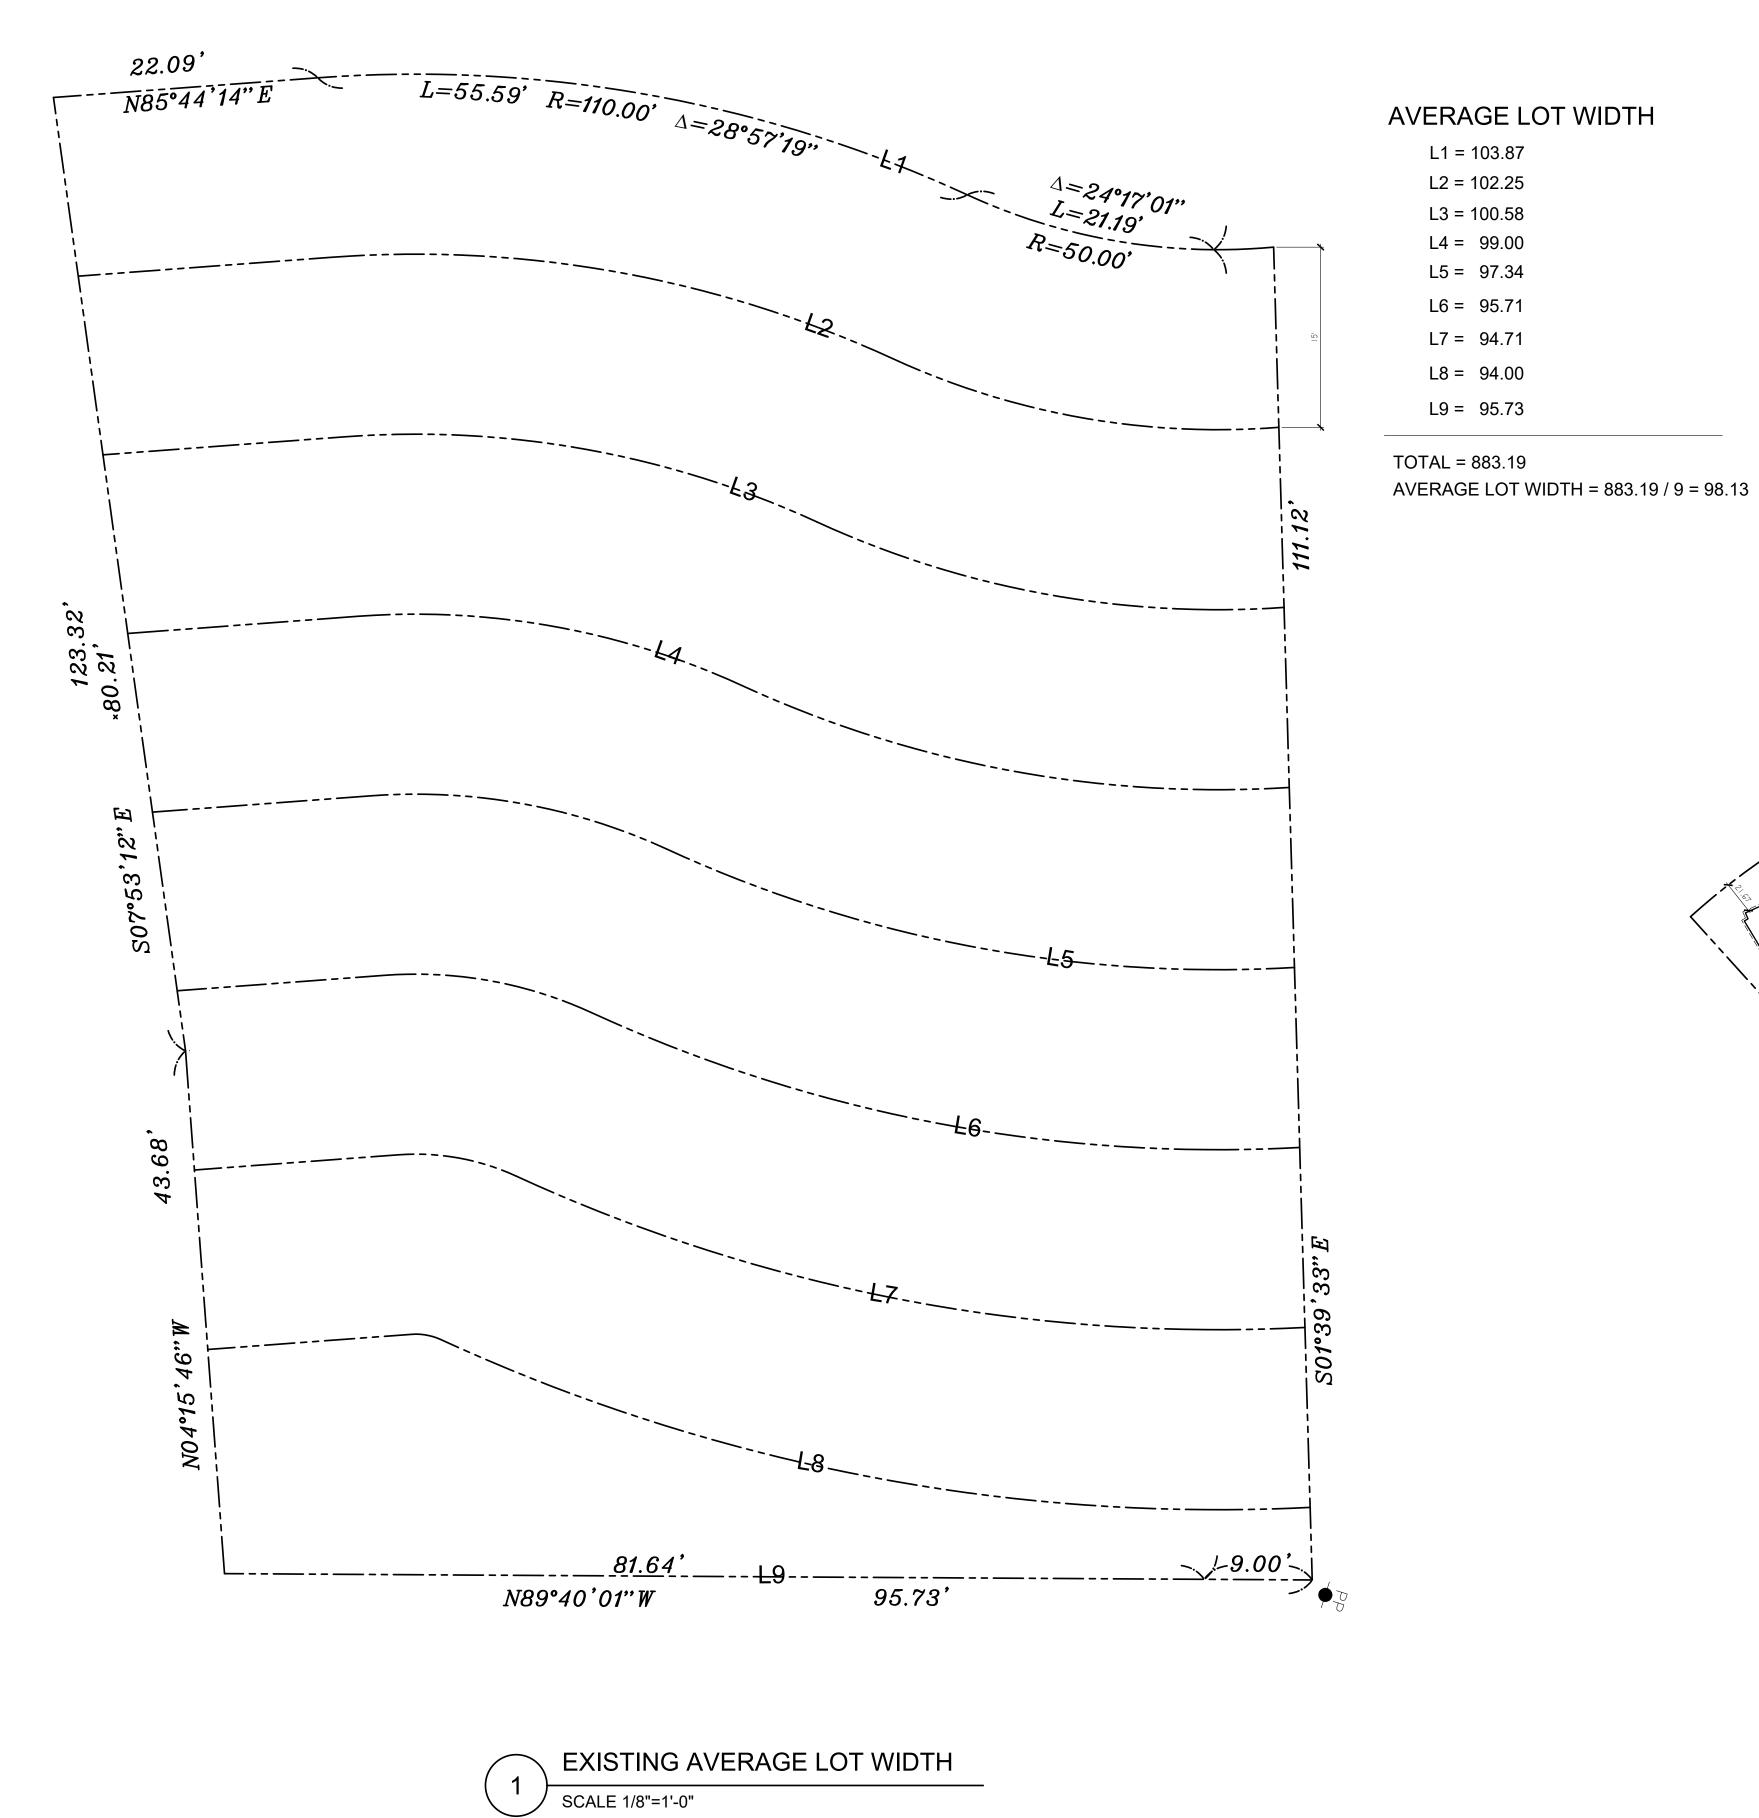

AVERAGE LOT WIDTH

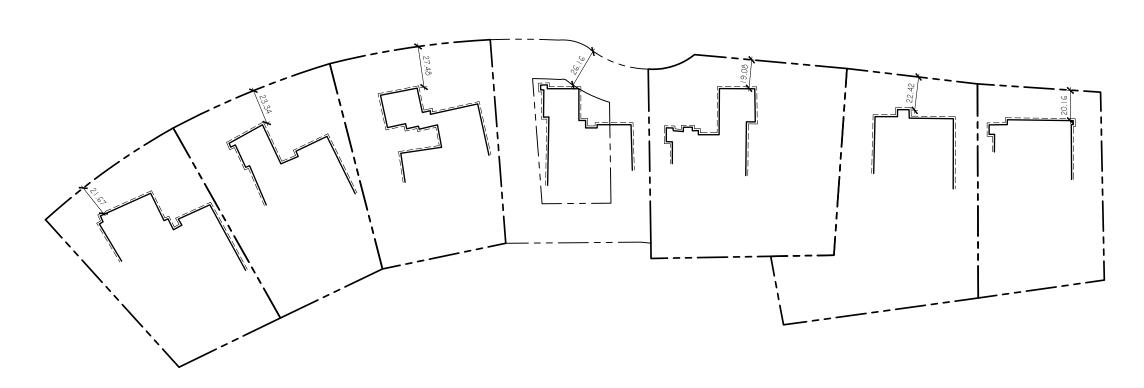

AVERAGE FRONT SETBACK

3112 N LAMER ST. = 21.67'

3118 N LAMER ST. = 23.34'

3124 N LAMER ST. = 27.42' 3130 N LAMER ST. = 26.16'

3136 N LAMER ST. = 19.08'

3142 N LAMER ST. = 22.42'

3148 N LAMER ST. = 20.16'

AVERAGE FRONT SETBACK =160.25 / 7 = 22.89'= 22'-11"

EXISTING AVERAGE FRONT SETBACK SCALE 1/8"=1'-0"



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Mr. and Mrs. Ekmekchian 3130 N Lamer St. Burbank, Ca. 91504

PROJECT:

Ekmekchian Residence


3130 N Lamer St. Burbank, Ca. 91504

REVISIONS		
DESCRIPTION	DATE	BY

SHEET TITLE:

AVERAGE LOT WIDTH AND AVERAGE FRONT SETBACK CALCULATIONS

DATE	05.08.23
SCALE	1/8" = 1'-0"
DRAWN BY	HZ
JOB NUMBER	011222
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PROJECT:

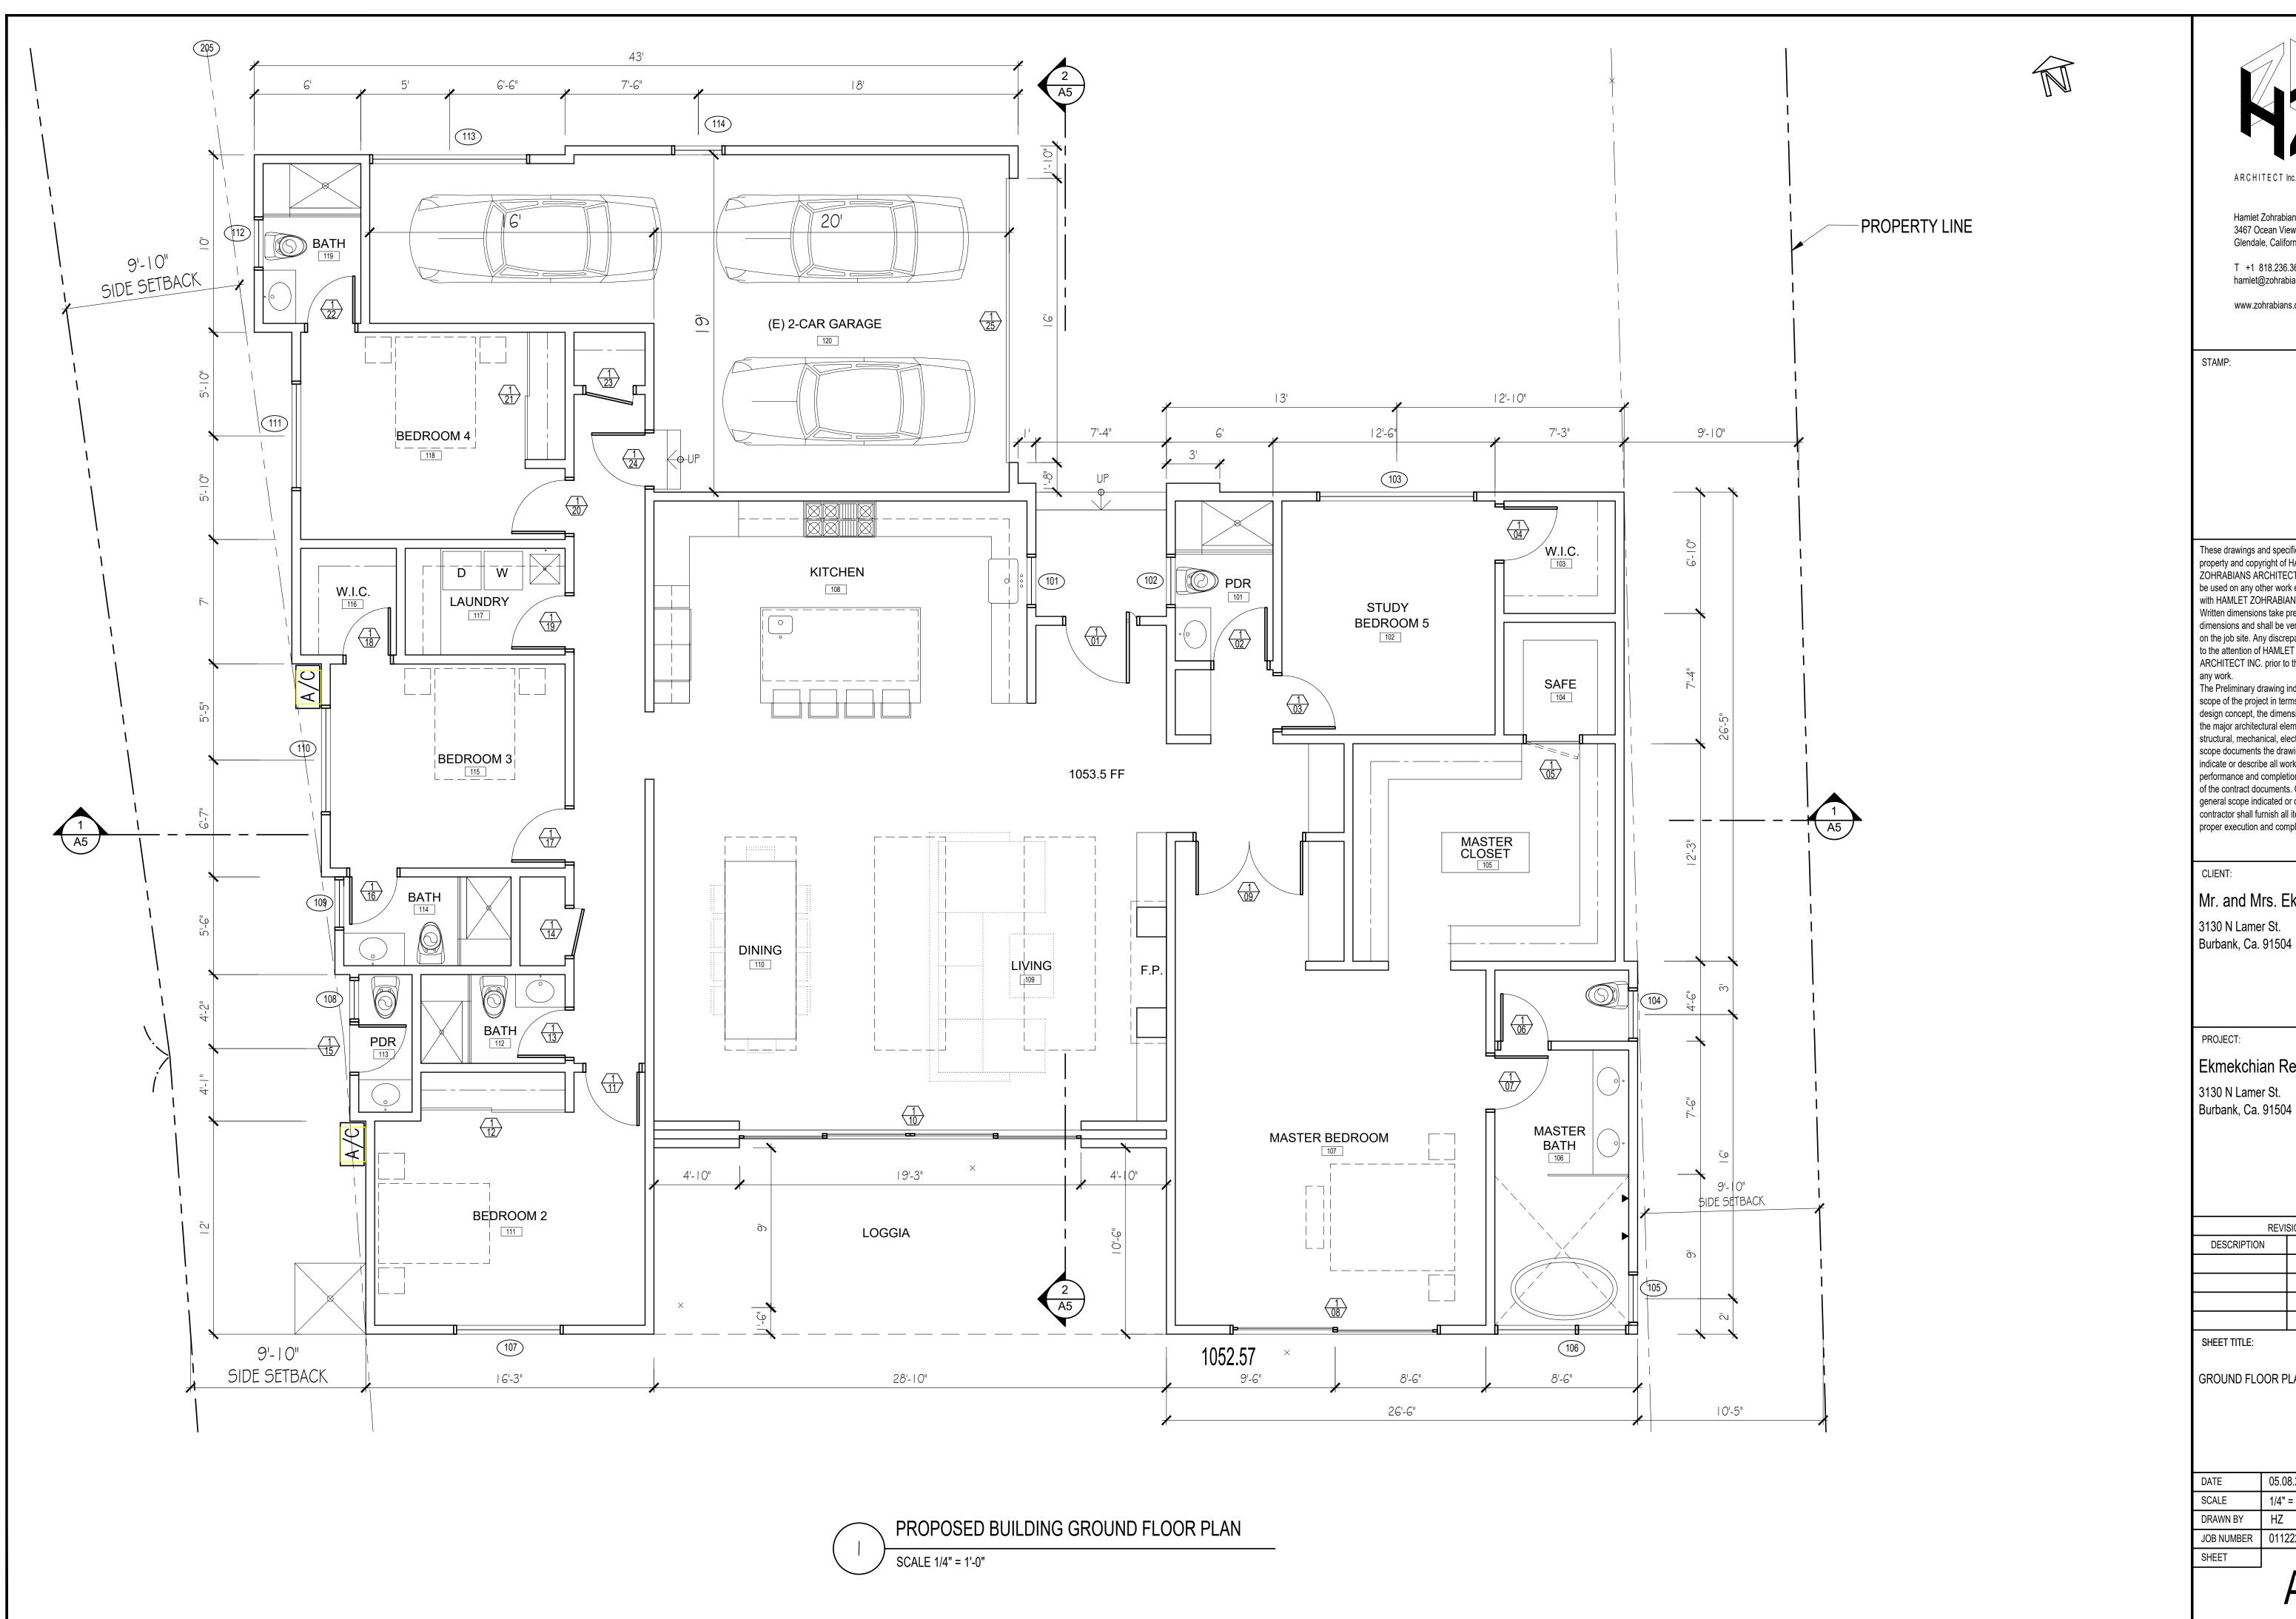Ekmekchian Residence 3130 N Lamer St.


REVISIONS DATE BY DESCRIPTION

SHEET TITLE:

GROUND FLOOR PLAN

05.08.23 SCALE 1/4" = 1'-0" DRAWN BY JOB NUMBER 011222

A3.1

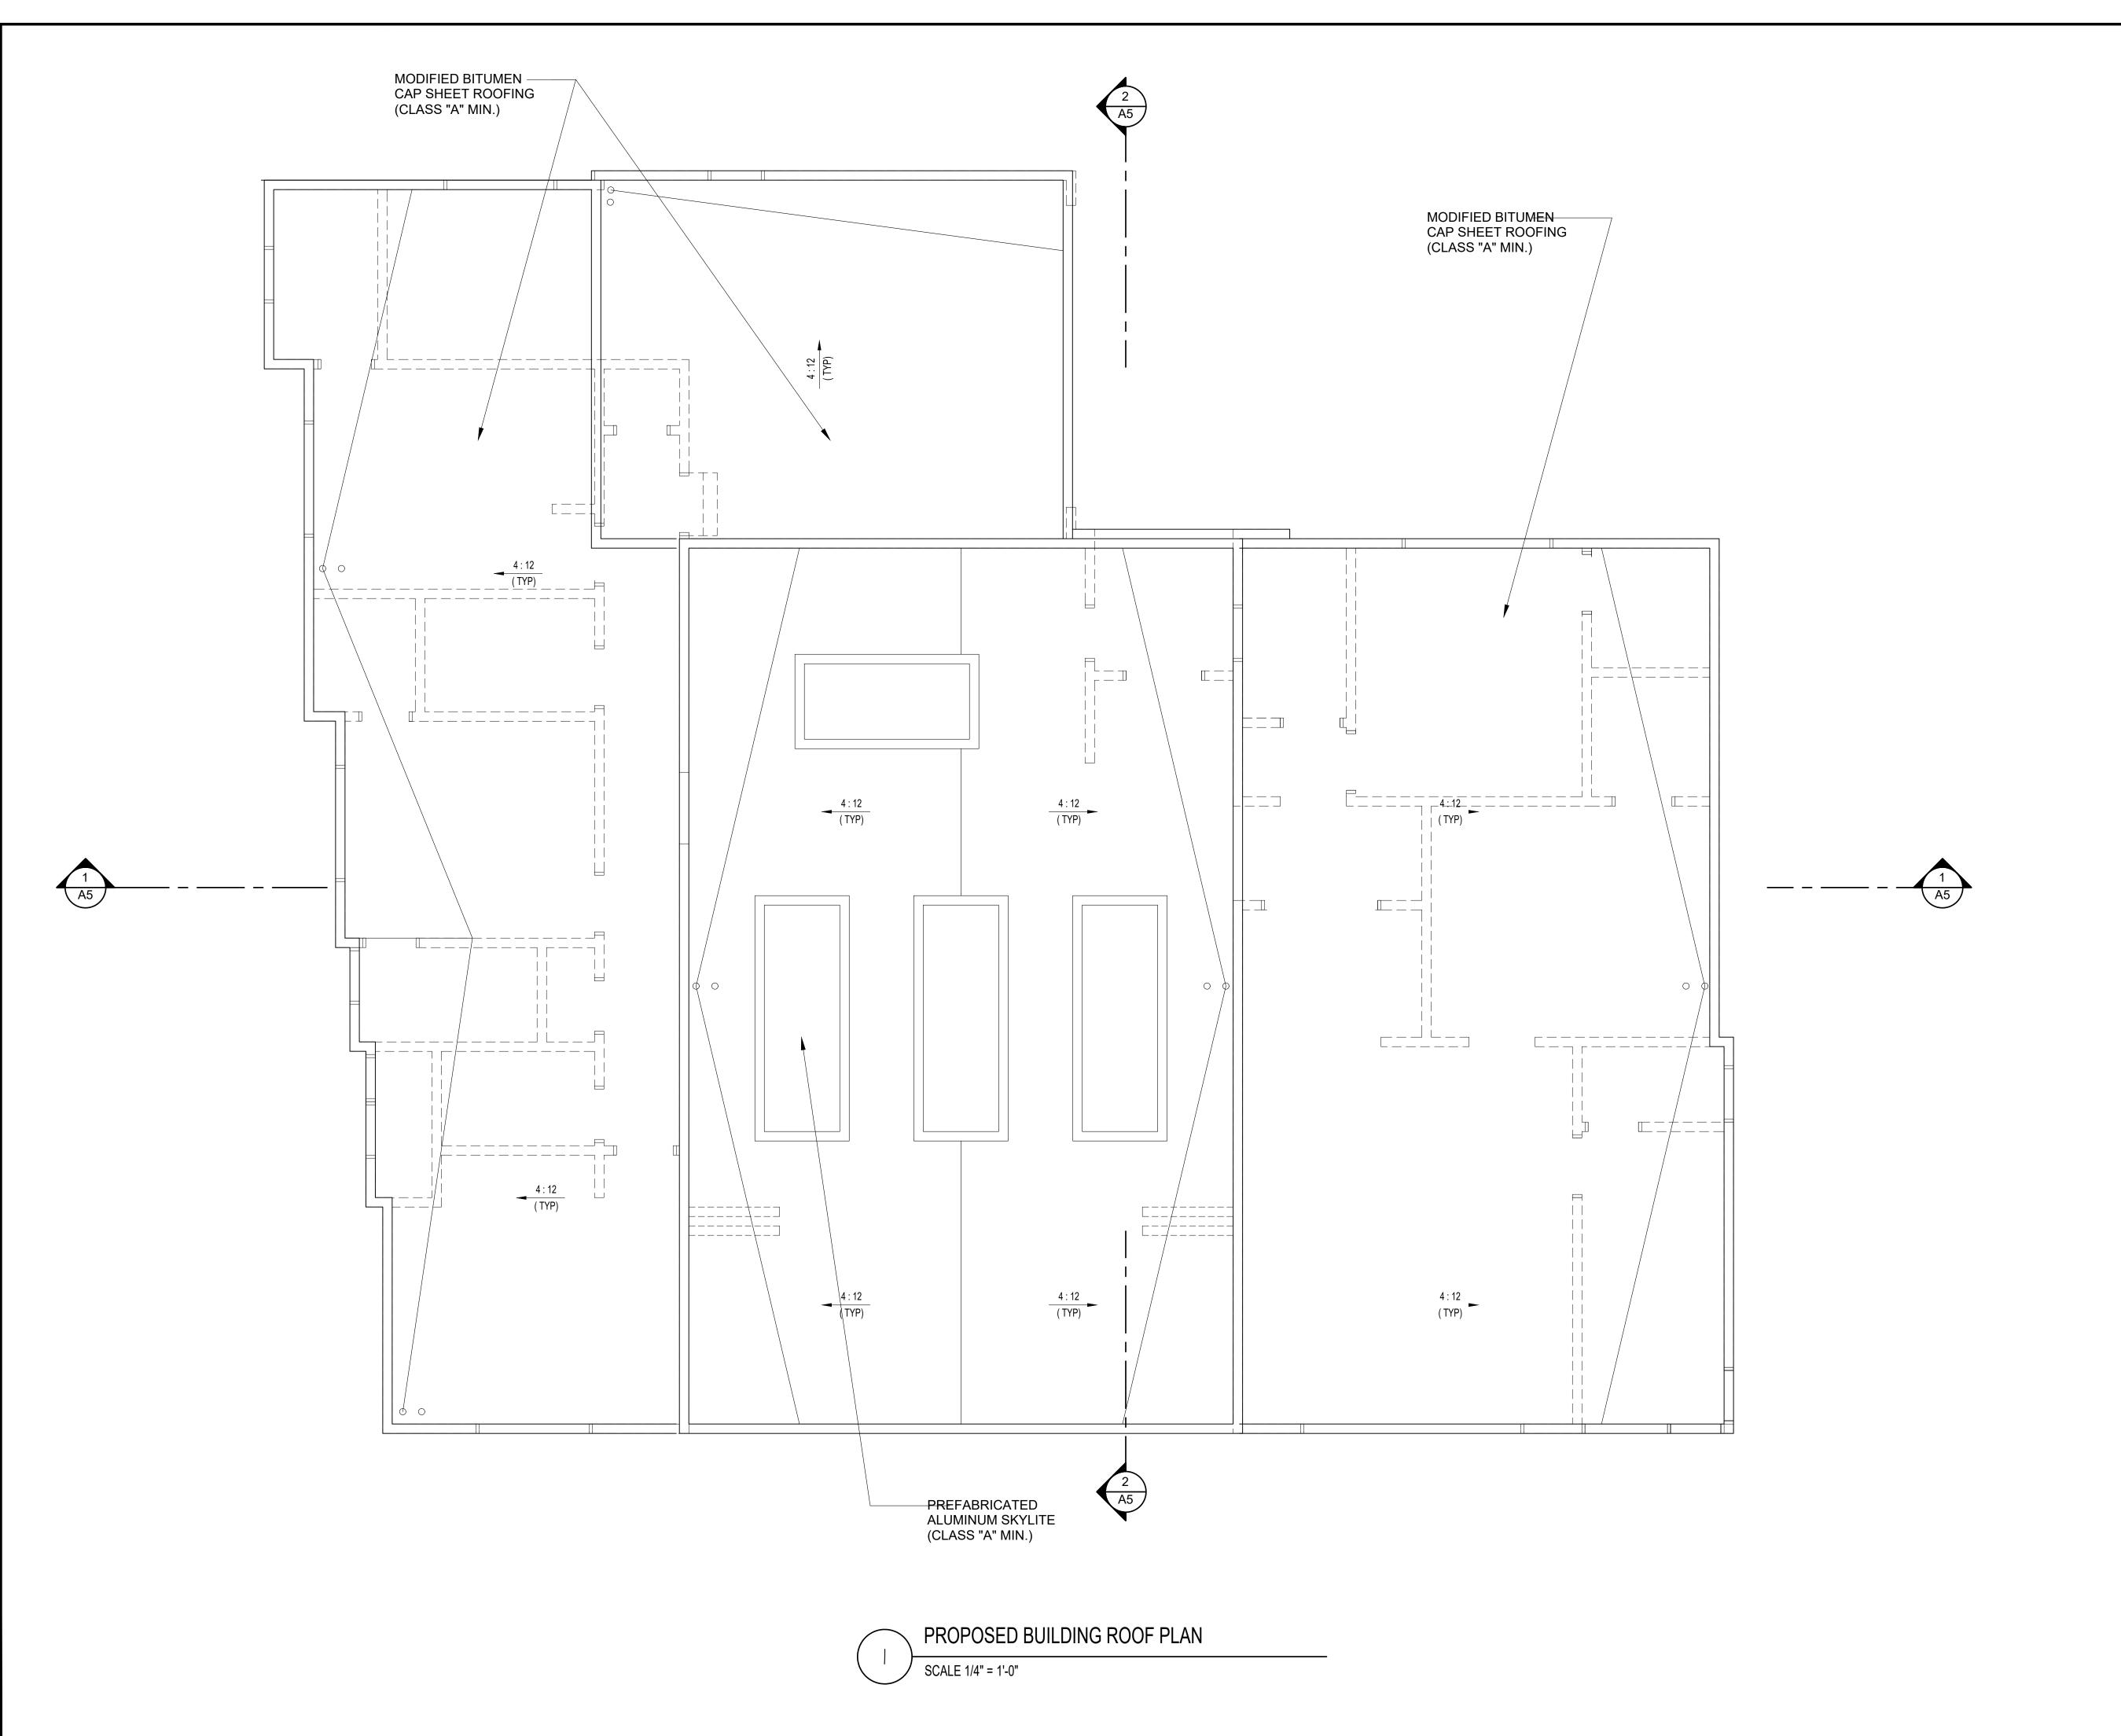



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PROJECT:

Ekmekchian Residence 3130 N Lamer St. Burbank, Ca. 91504

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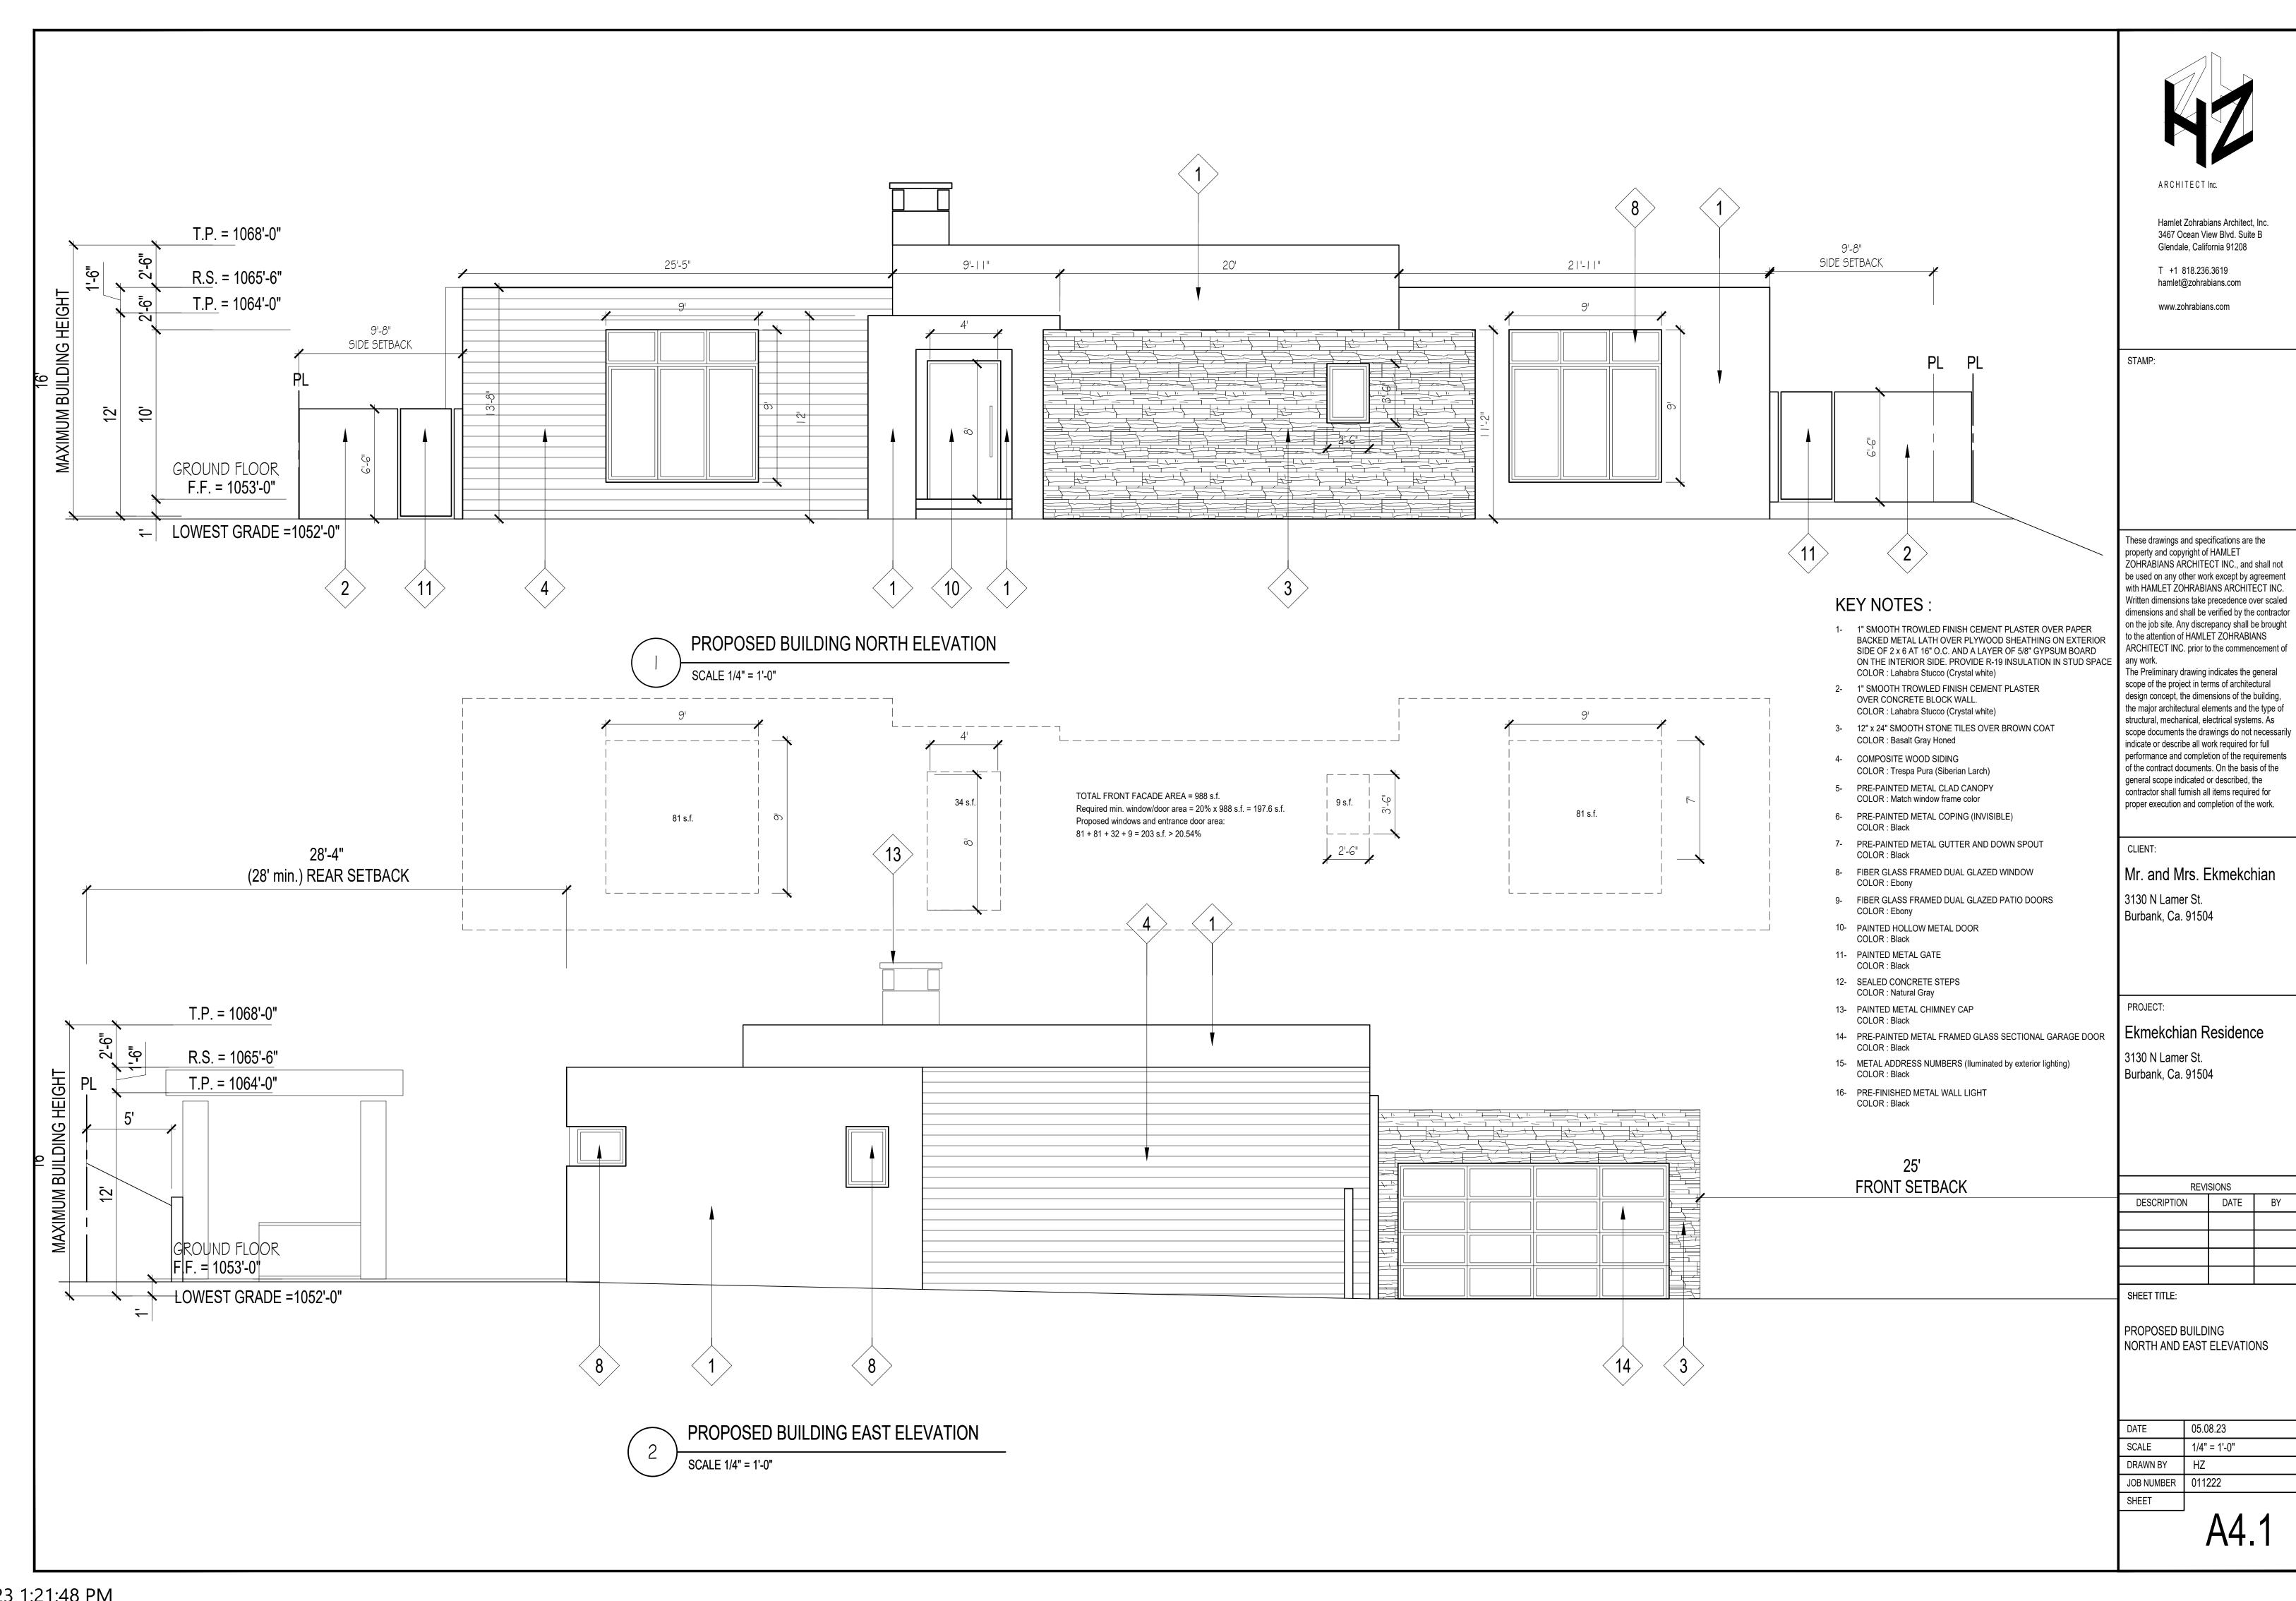
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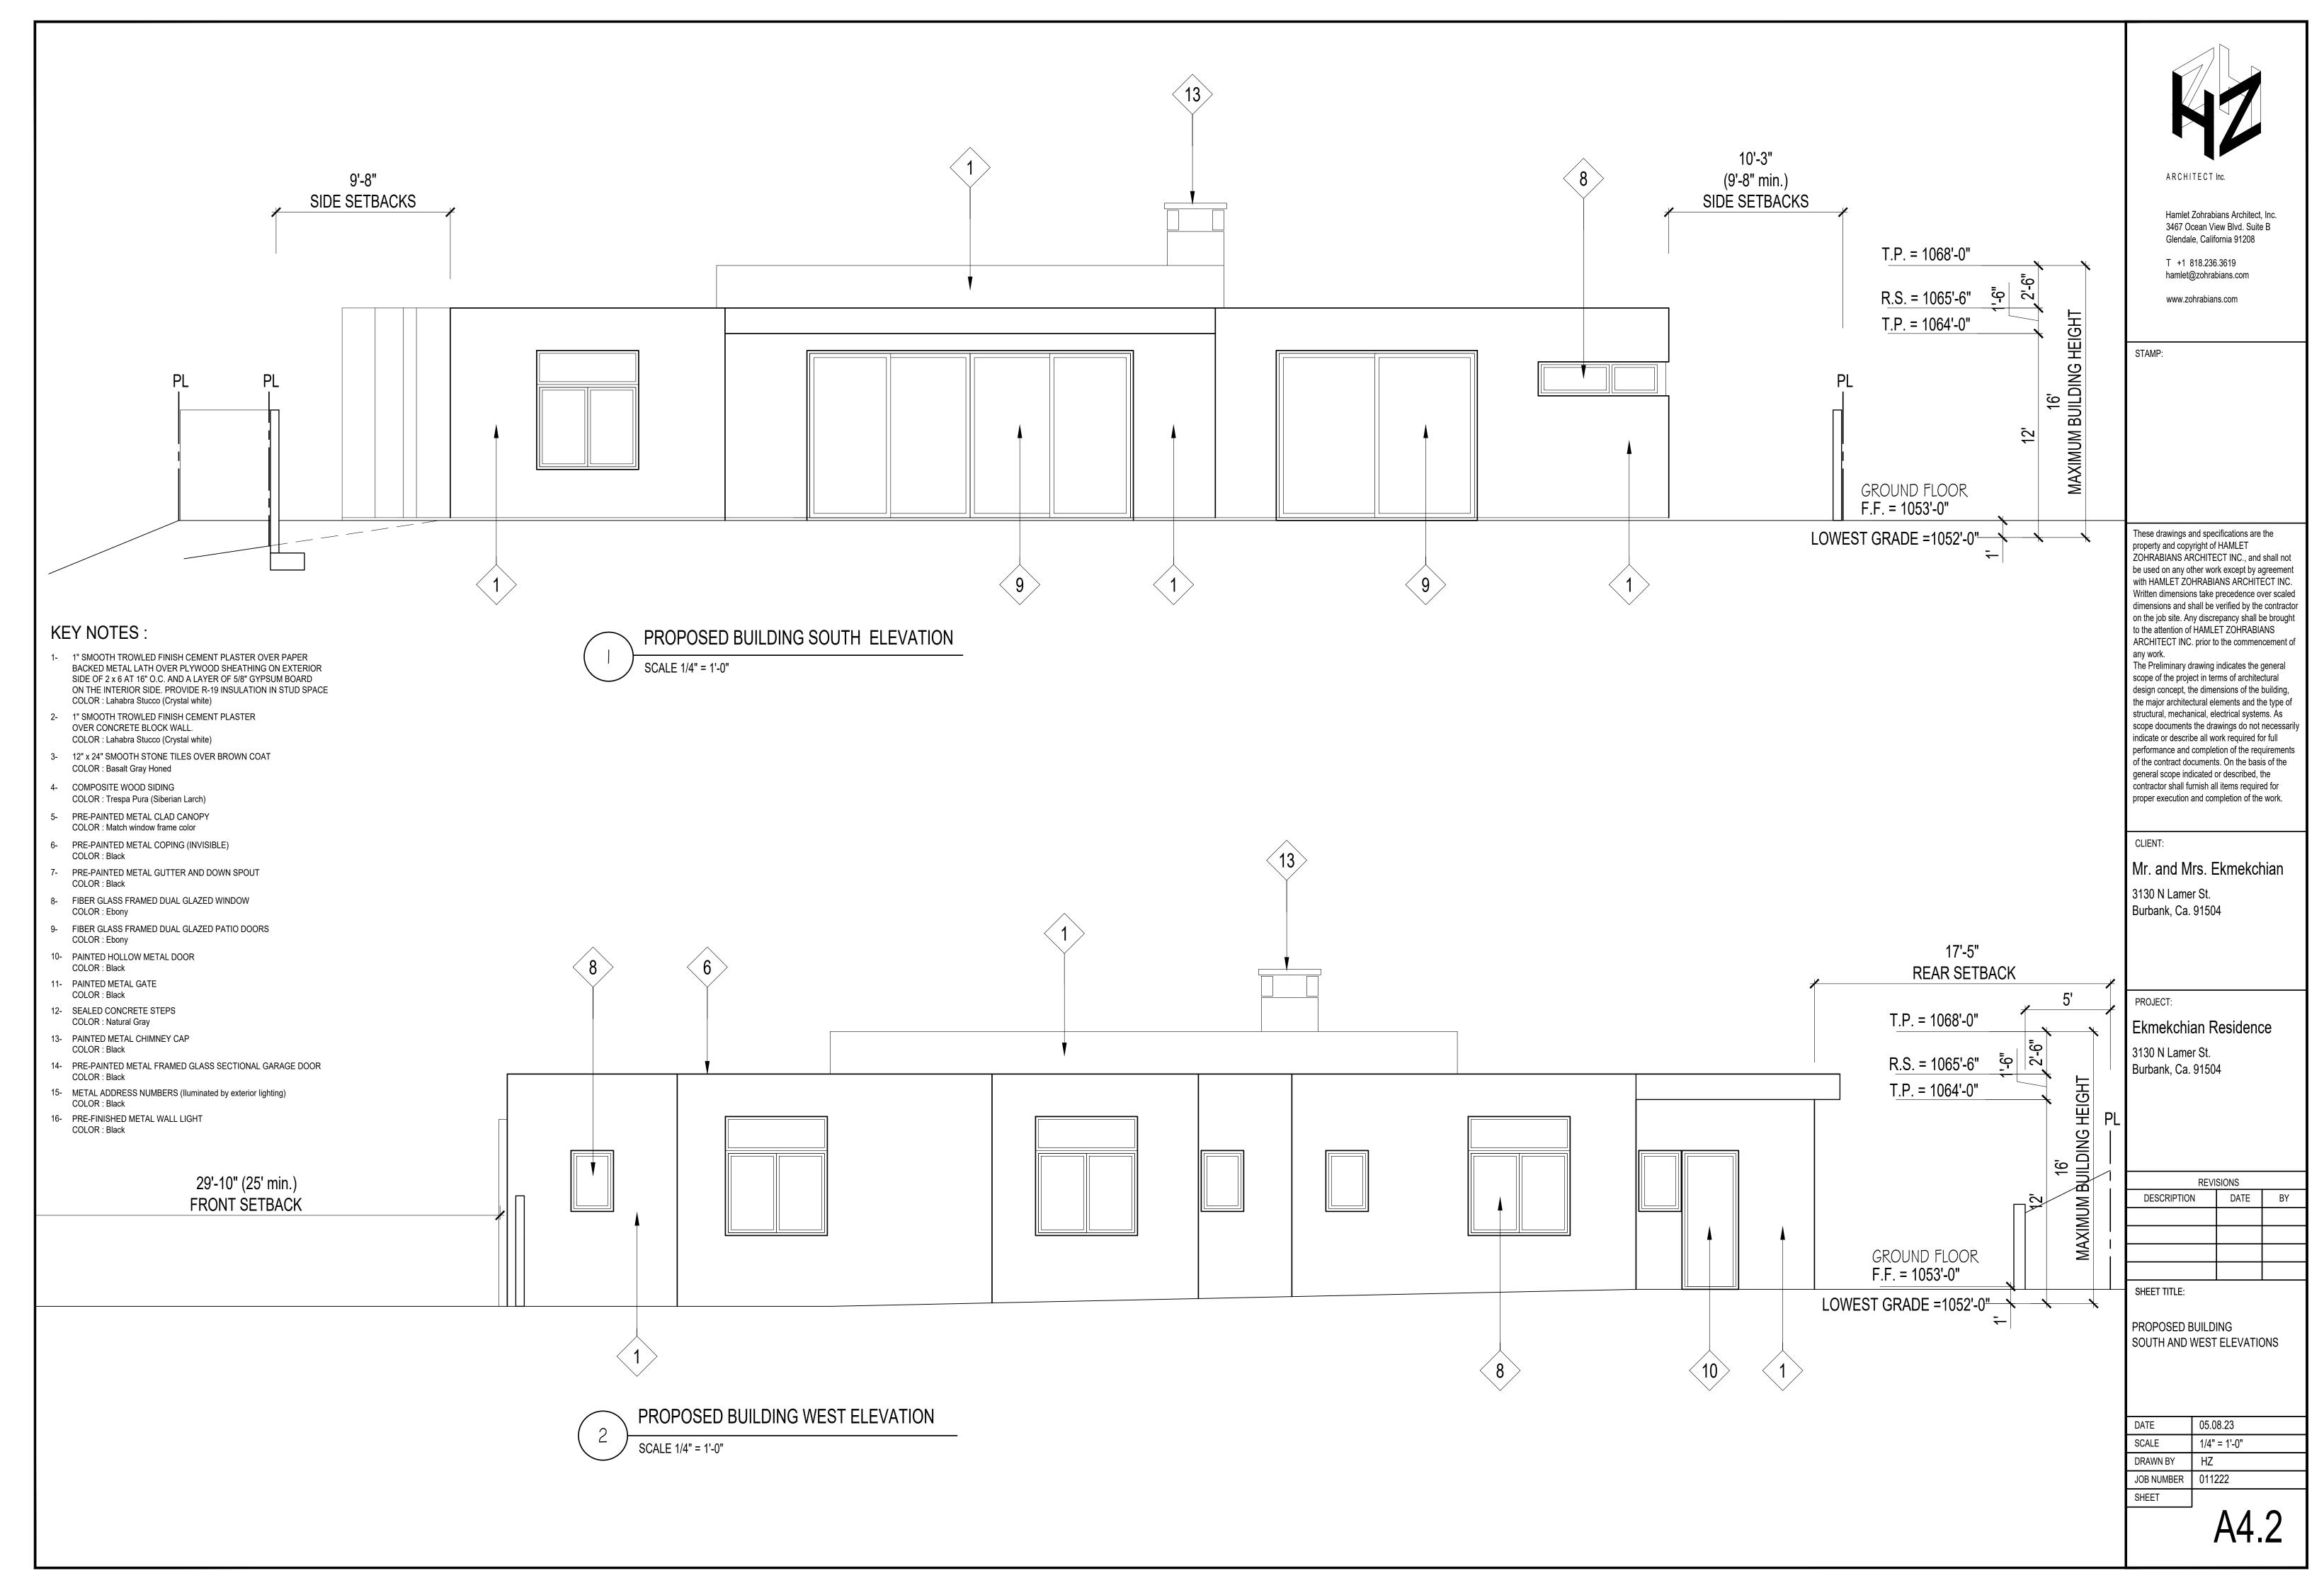
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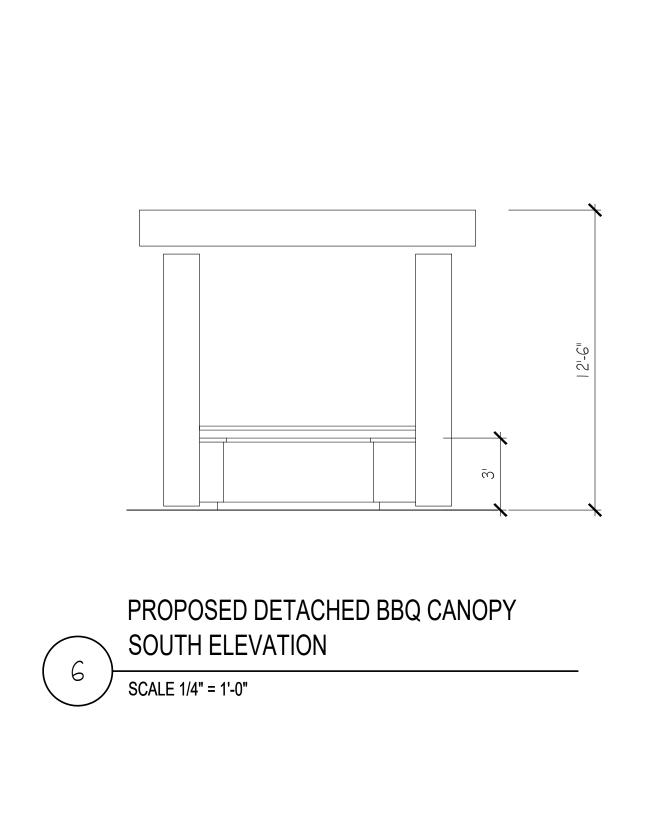
PROPOSED BUILDING ROOF PLAN


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JOB NUMBER	011222
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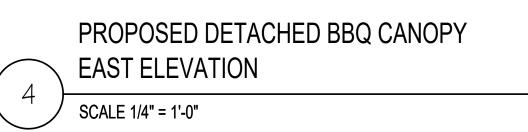
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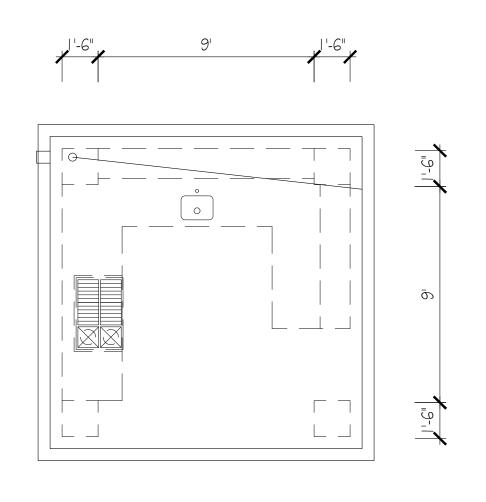












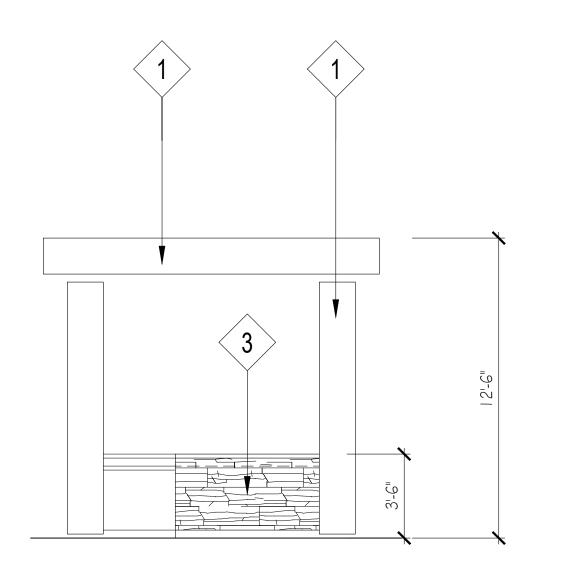





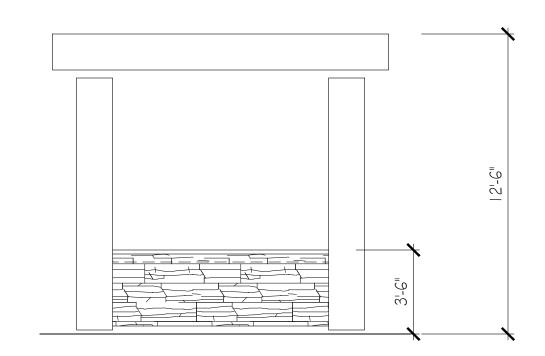



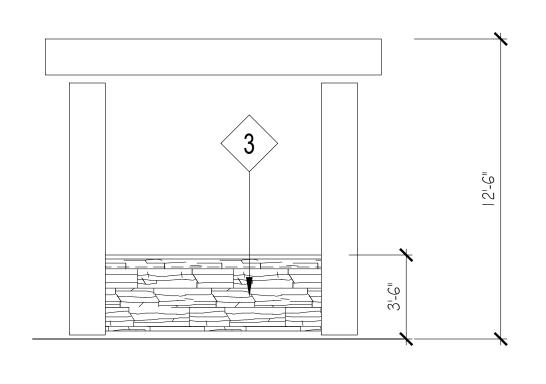

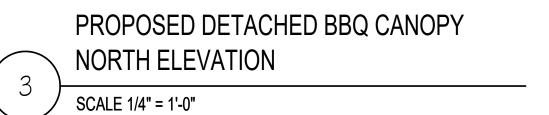


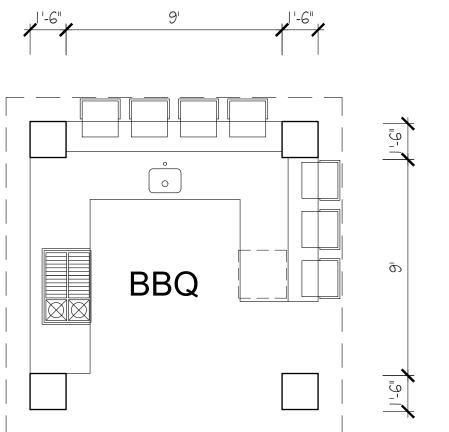



KEY NOTES:

- 1- 1" SMOOTH TROWLED FINISH CEMENT PLASTER OVER PAPER BACKED METAL LATH OVER PLYWOOD SHEATHING ON EXTERIOR SIDE OF 2 x 6 AT 16" O.C. AND A LAYER OF 5/8" GYPSUM BOARD ON THE INTERIOR SIDE. PROVIDE R-19 INSULATION IN STUD SPACE COLOR : Lahabra Stucco (Crystal white)
- 2- 1" SMOOTH TROWLED FINISH CEMENT PLASTER OVER CONCRETE BLOCK WALL. COLOR : Lahabra Stucco (Crystal white)
- 3- 12" x 24" SMOOTH STONE TILES OVER BROWN COAT COLOR: Basalt Gray Honed
- 4- GRANITE COUNTER TOP COLOR : Basalt Gray Honed
- 5- PRE-PAINTED METAL COPING (INVISIBLE) COLOR: Match Plaster finish

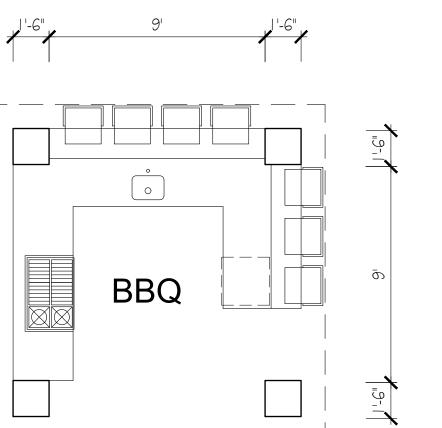

REVI	SIONS	
DESCRIPTION	DATE	BY

Ekmekchian Residence

ARCHITECT Inc.

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Mr. and Mrs. Ekmekchian

any work.

CLIENT:

3130 N Lamer St. Burbank, Ca. 91504

PROJECT:

3130 N Lamer St.

Burbank, Ca. 91504


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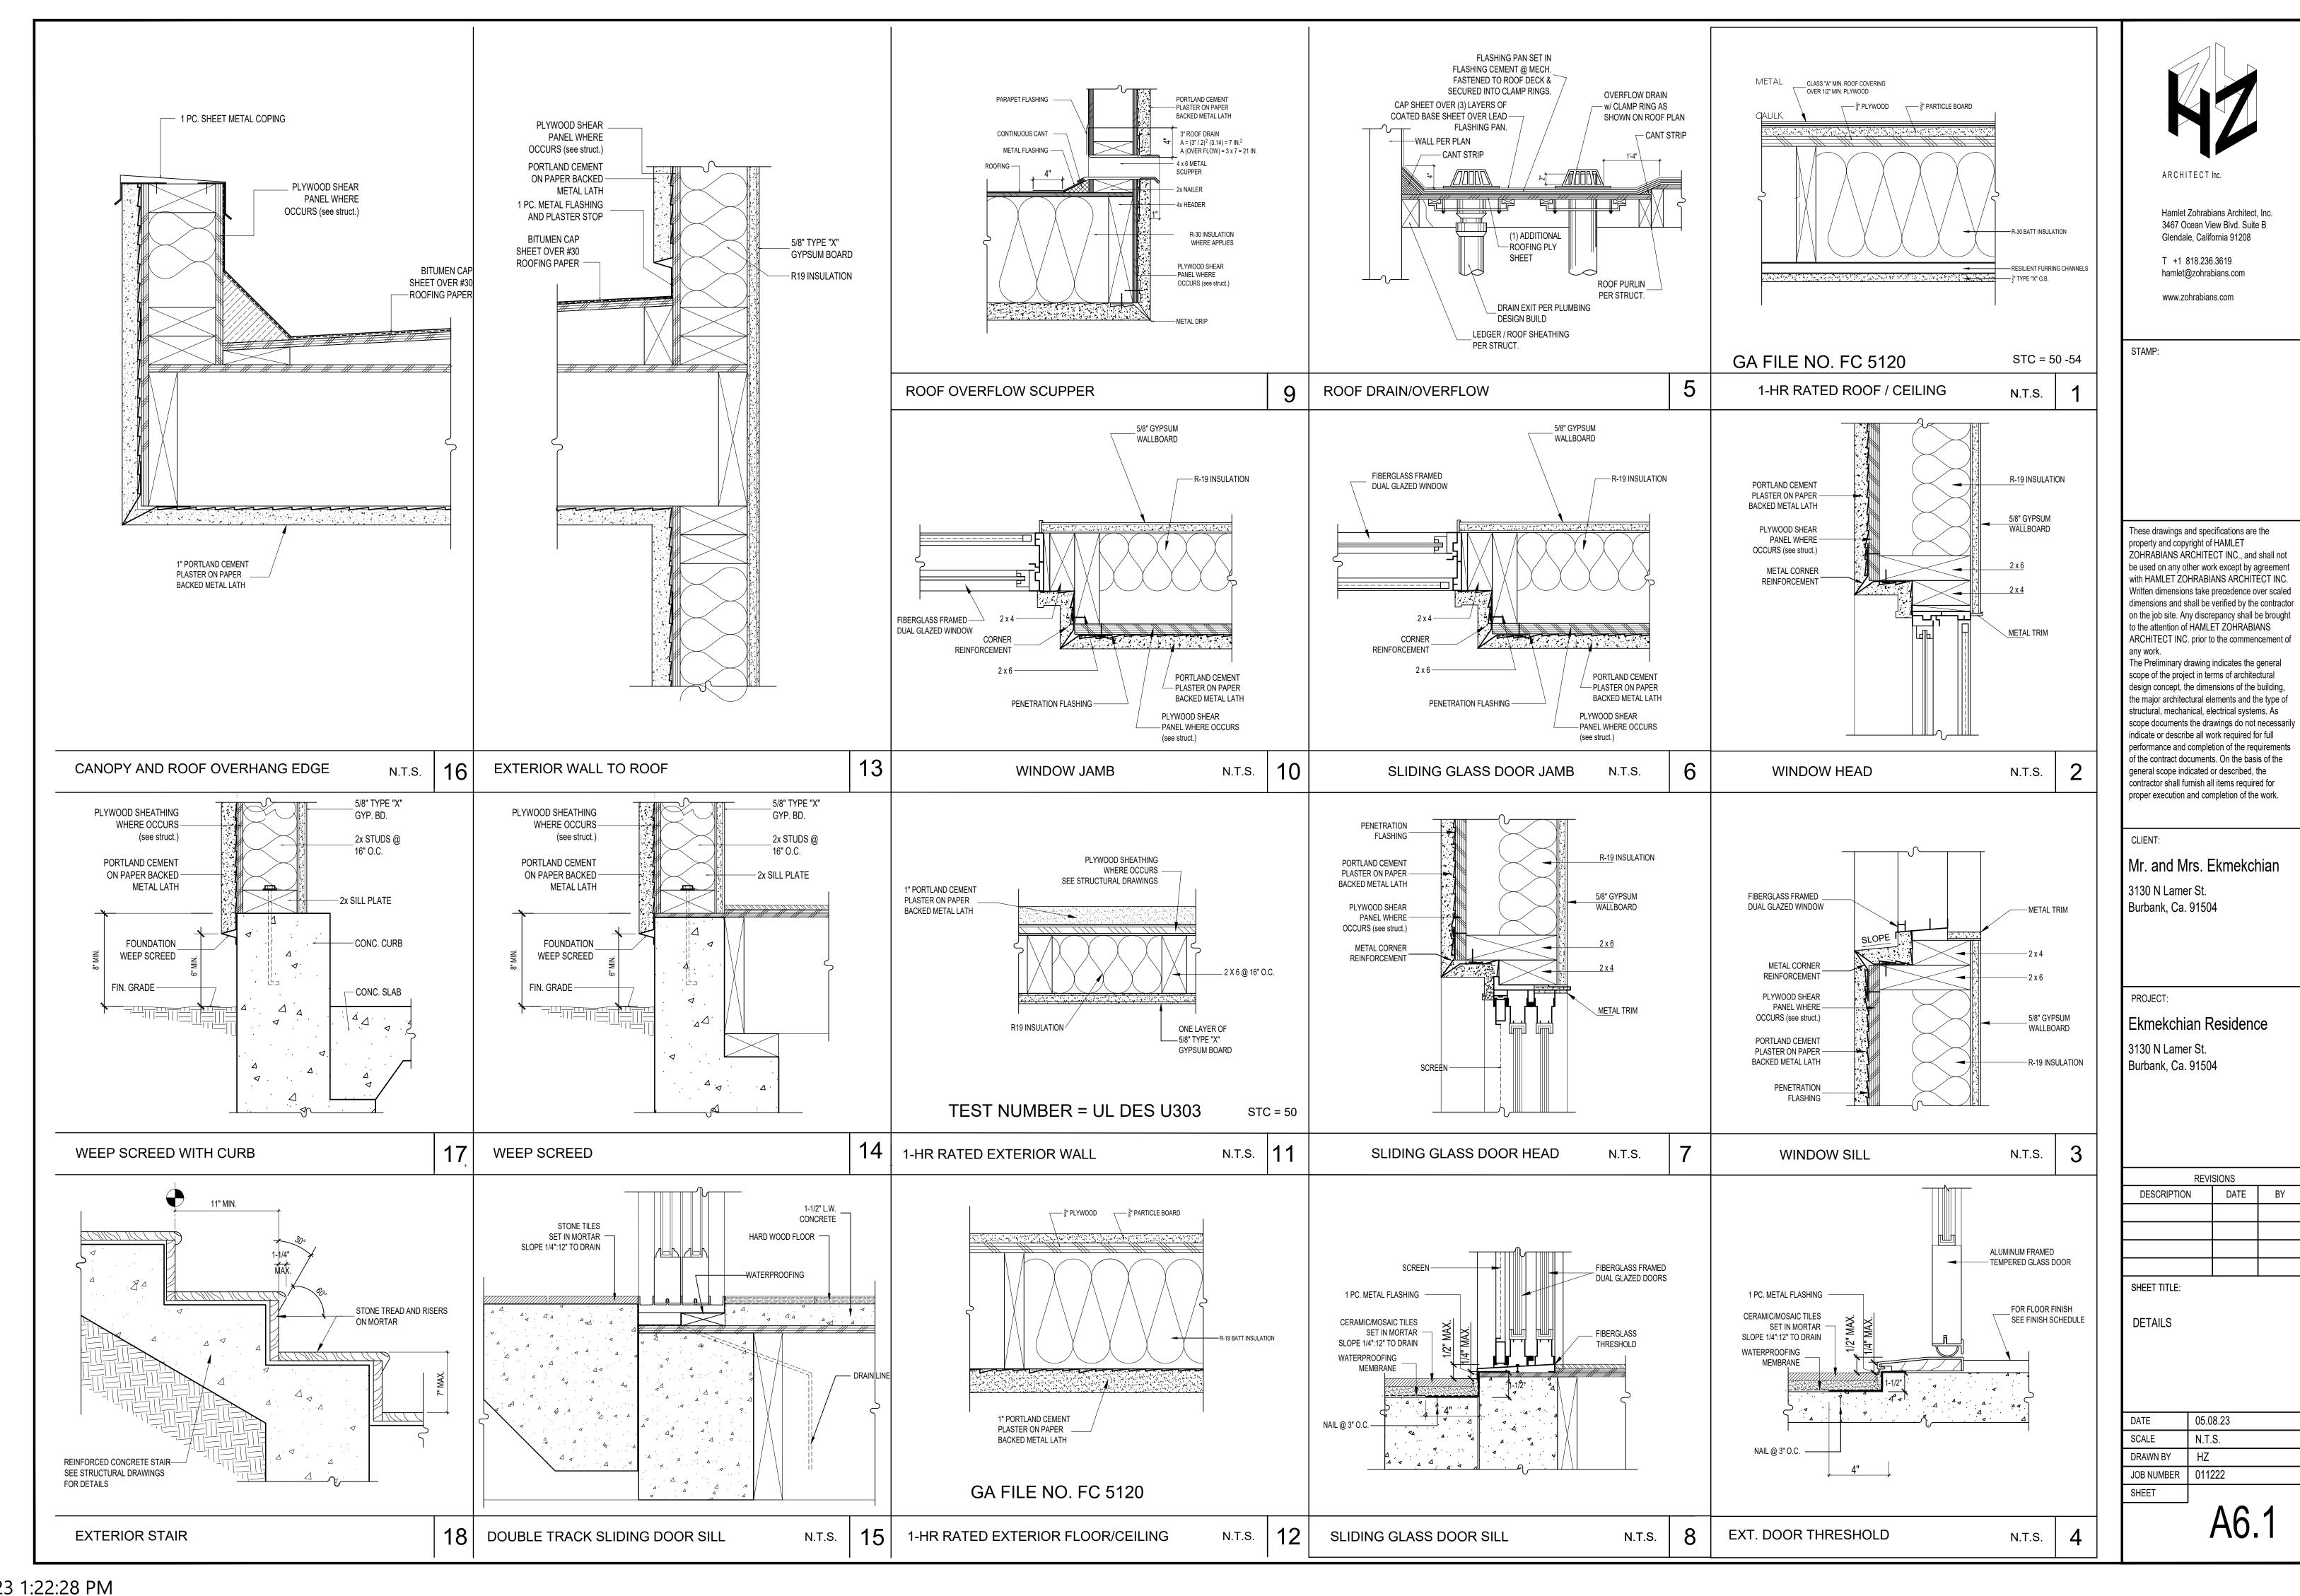
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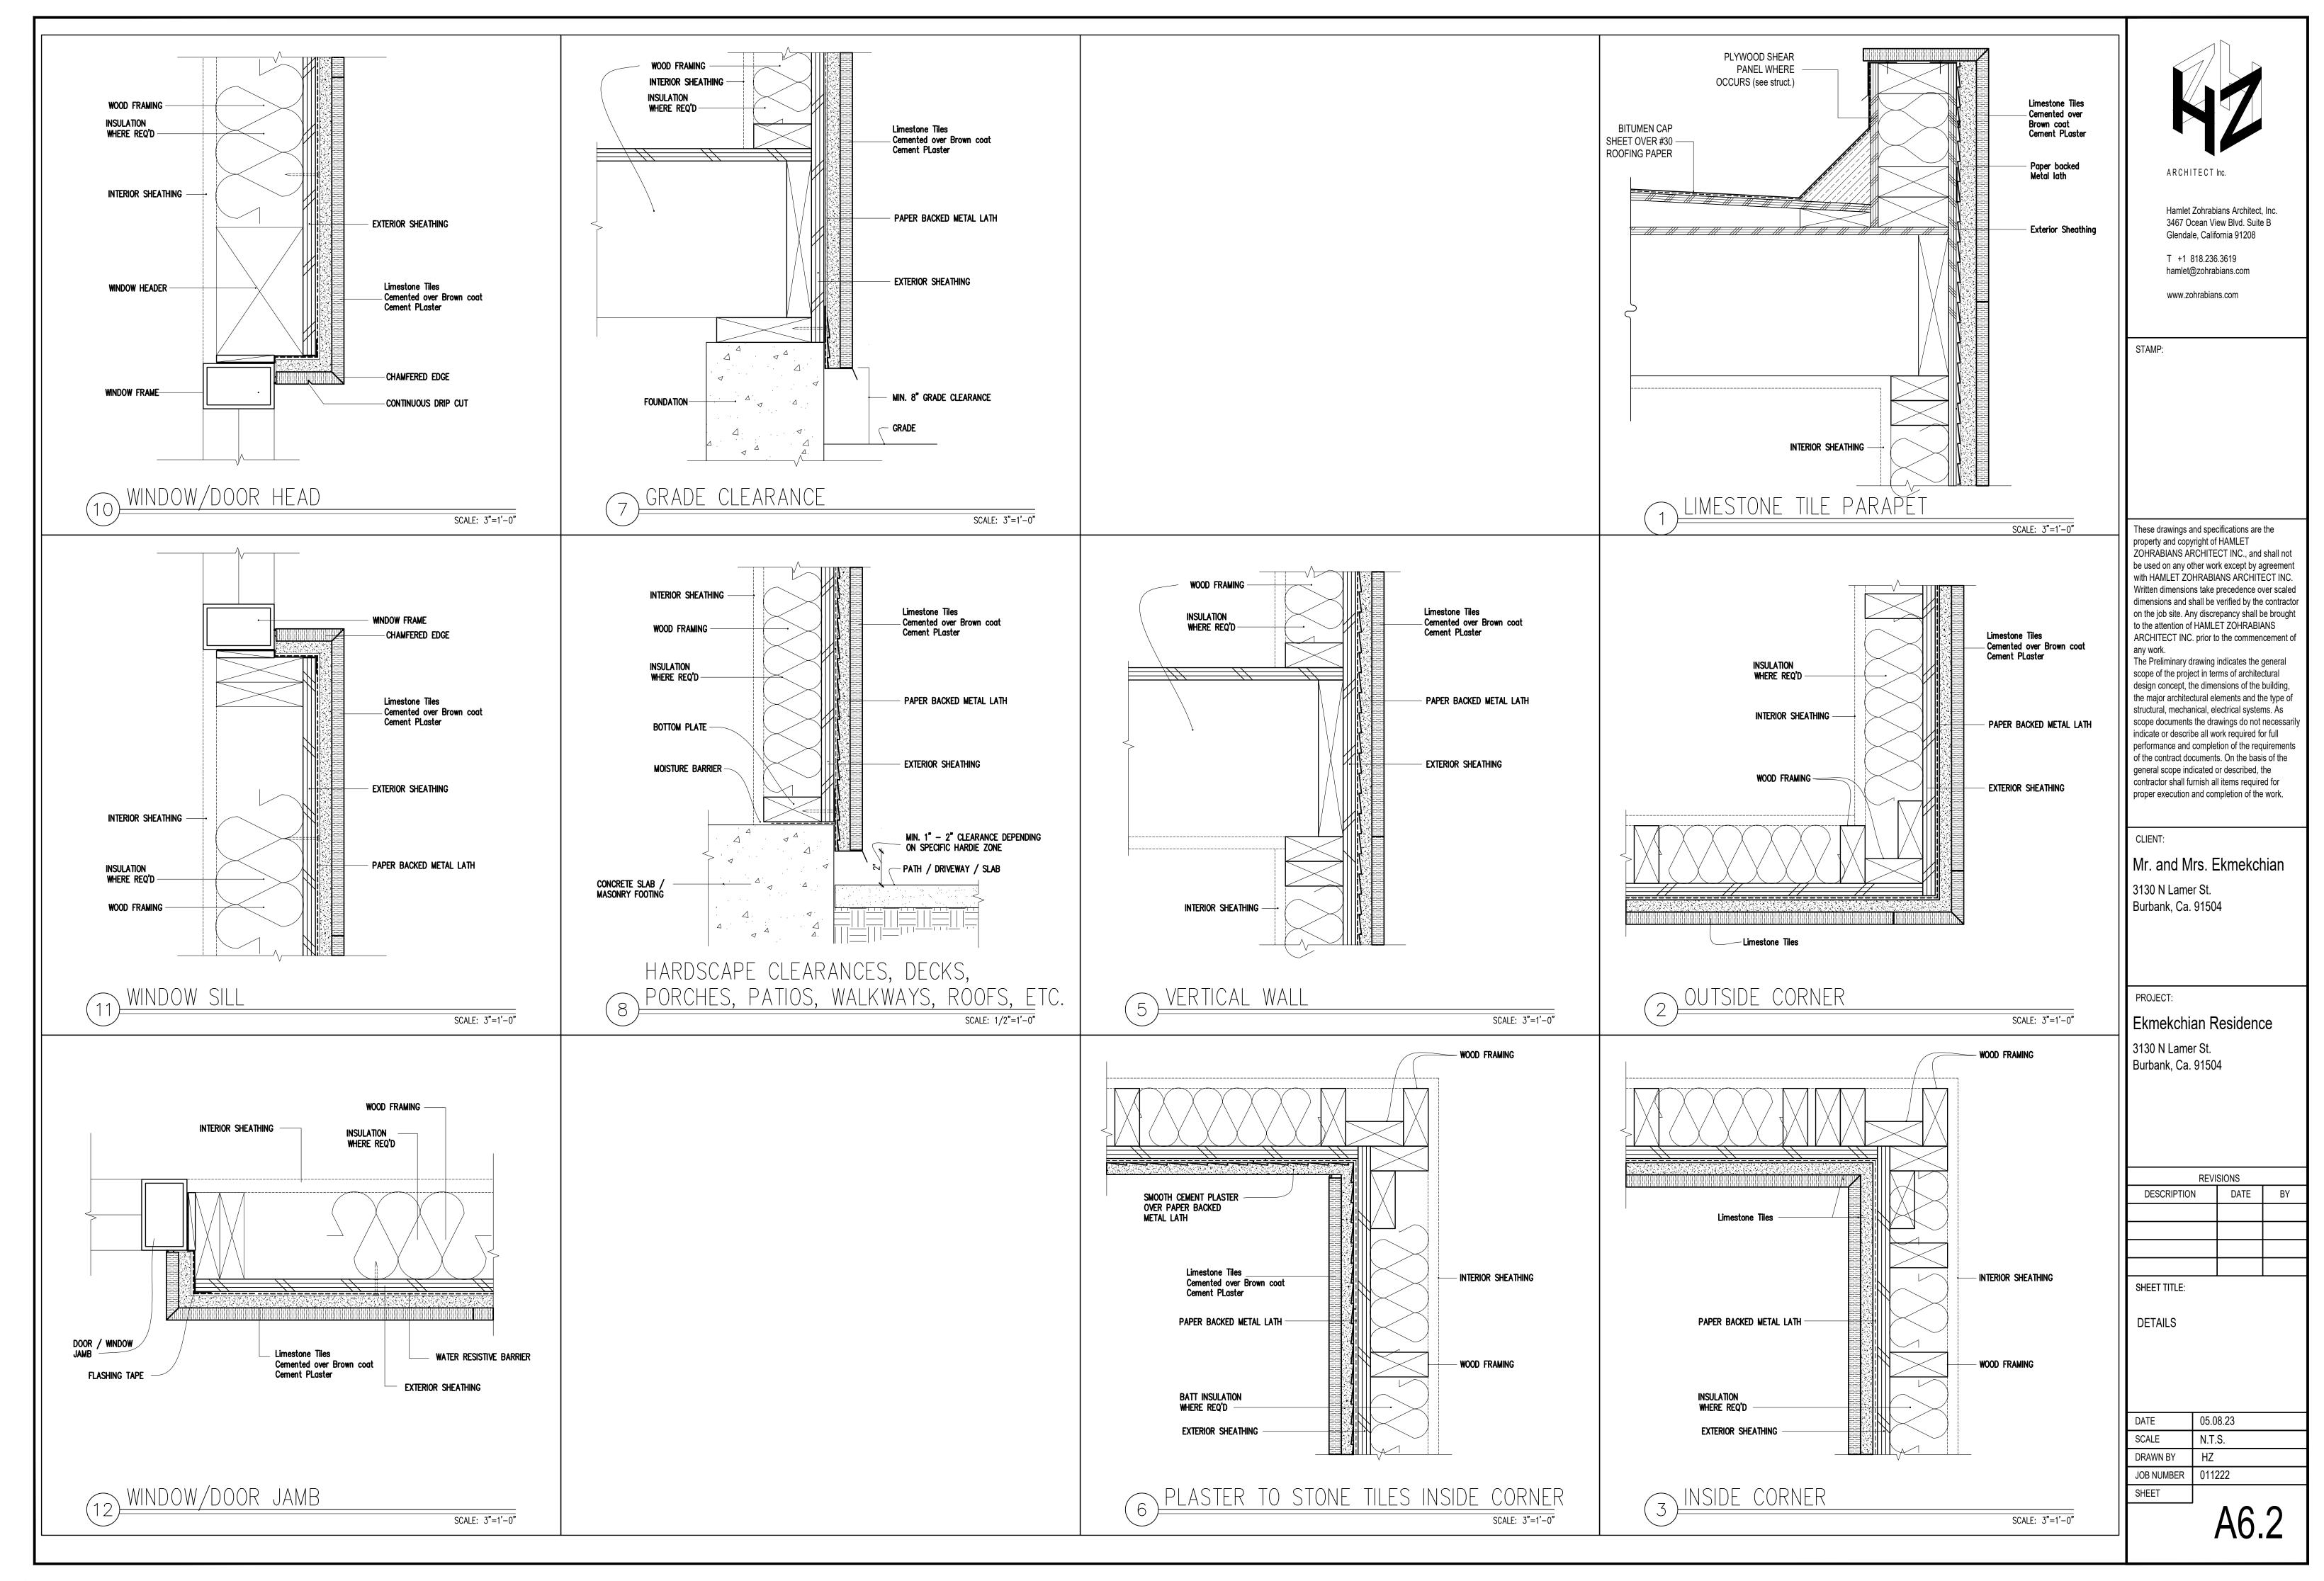
PROPOSED ACCESSORY DETACHED BBQ CANOPY


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SCALE	1/4" = 1'-0"
DRAWN BY	HZ
JOB NUMBER	011222
SHEET	


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MD.

 \rightarrow

(G)

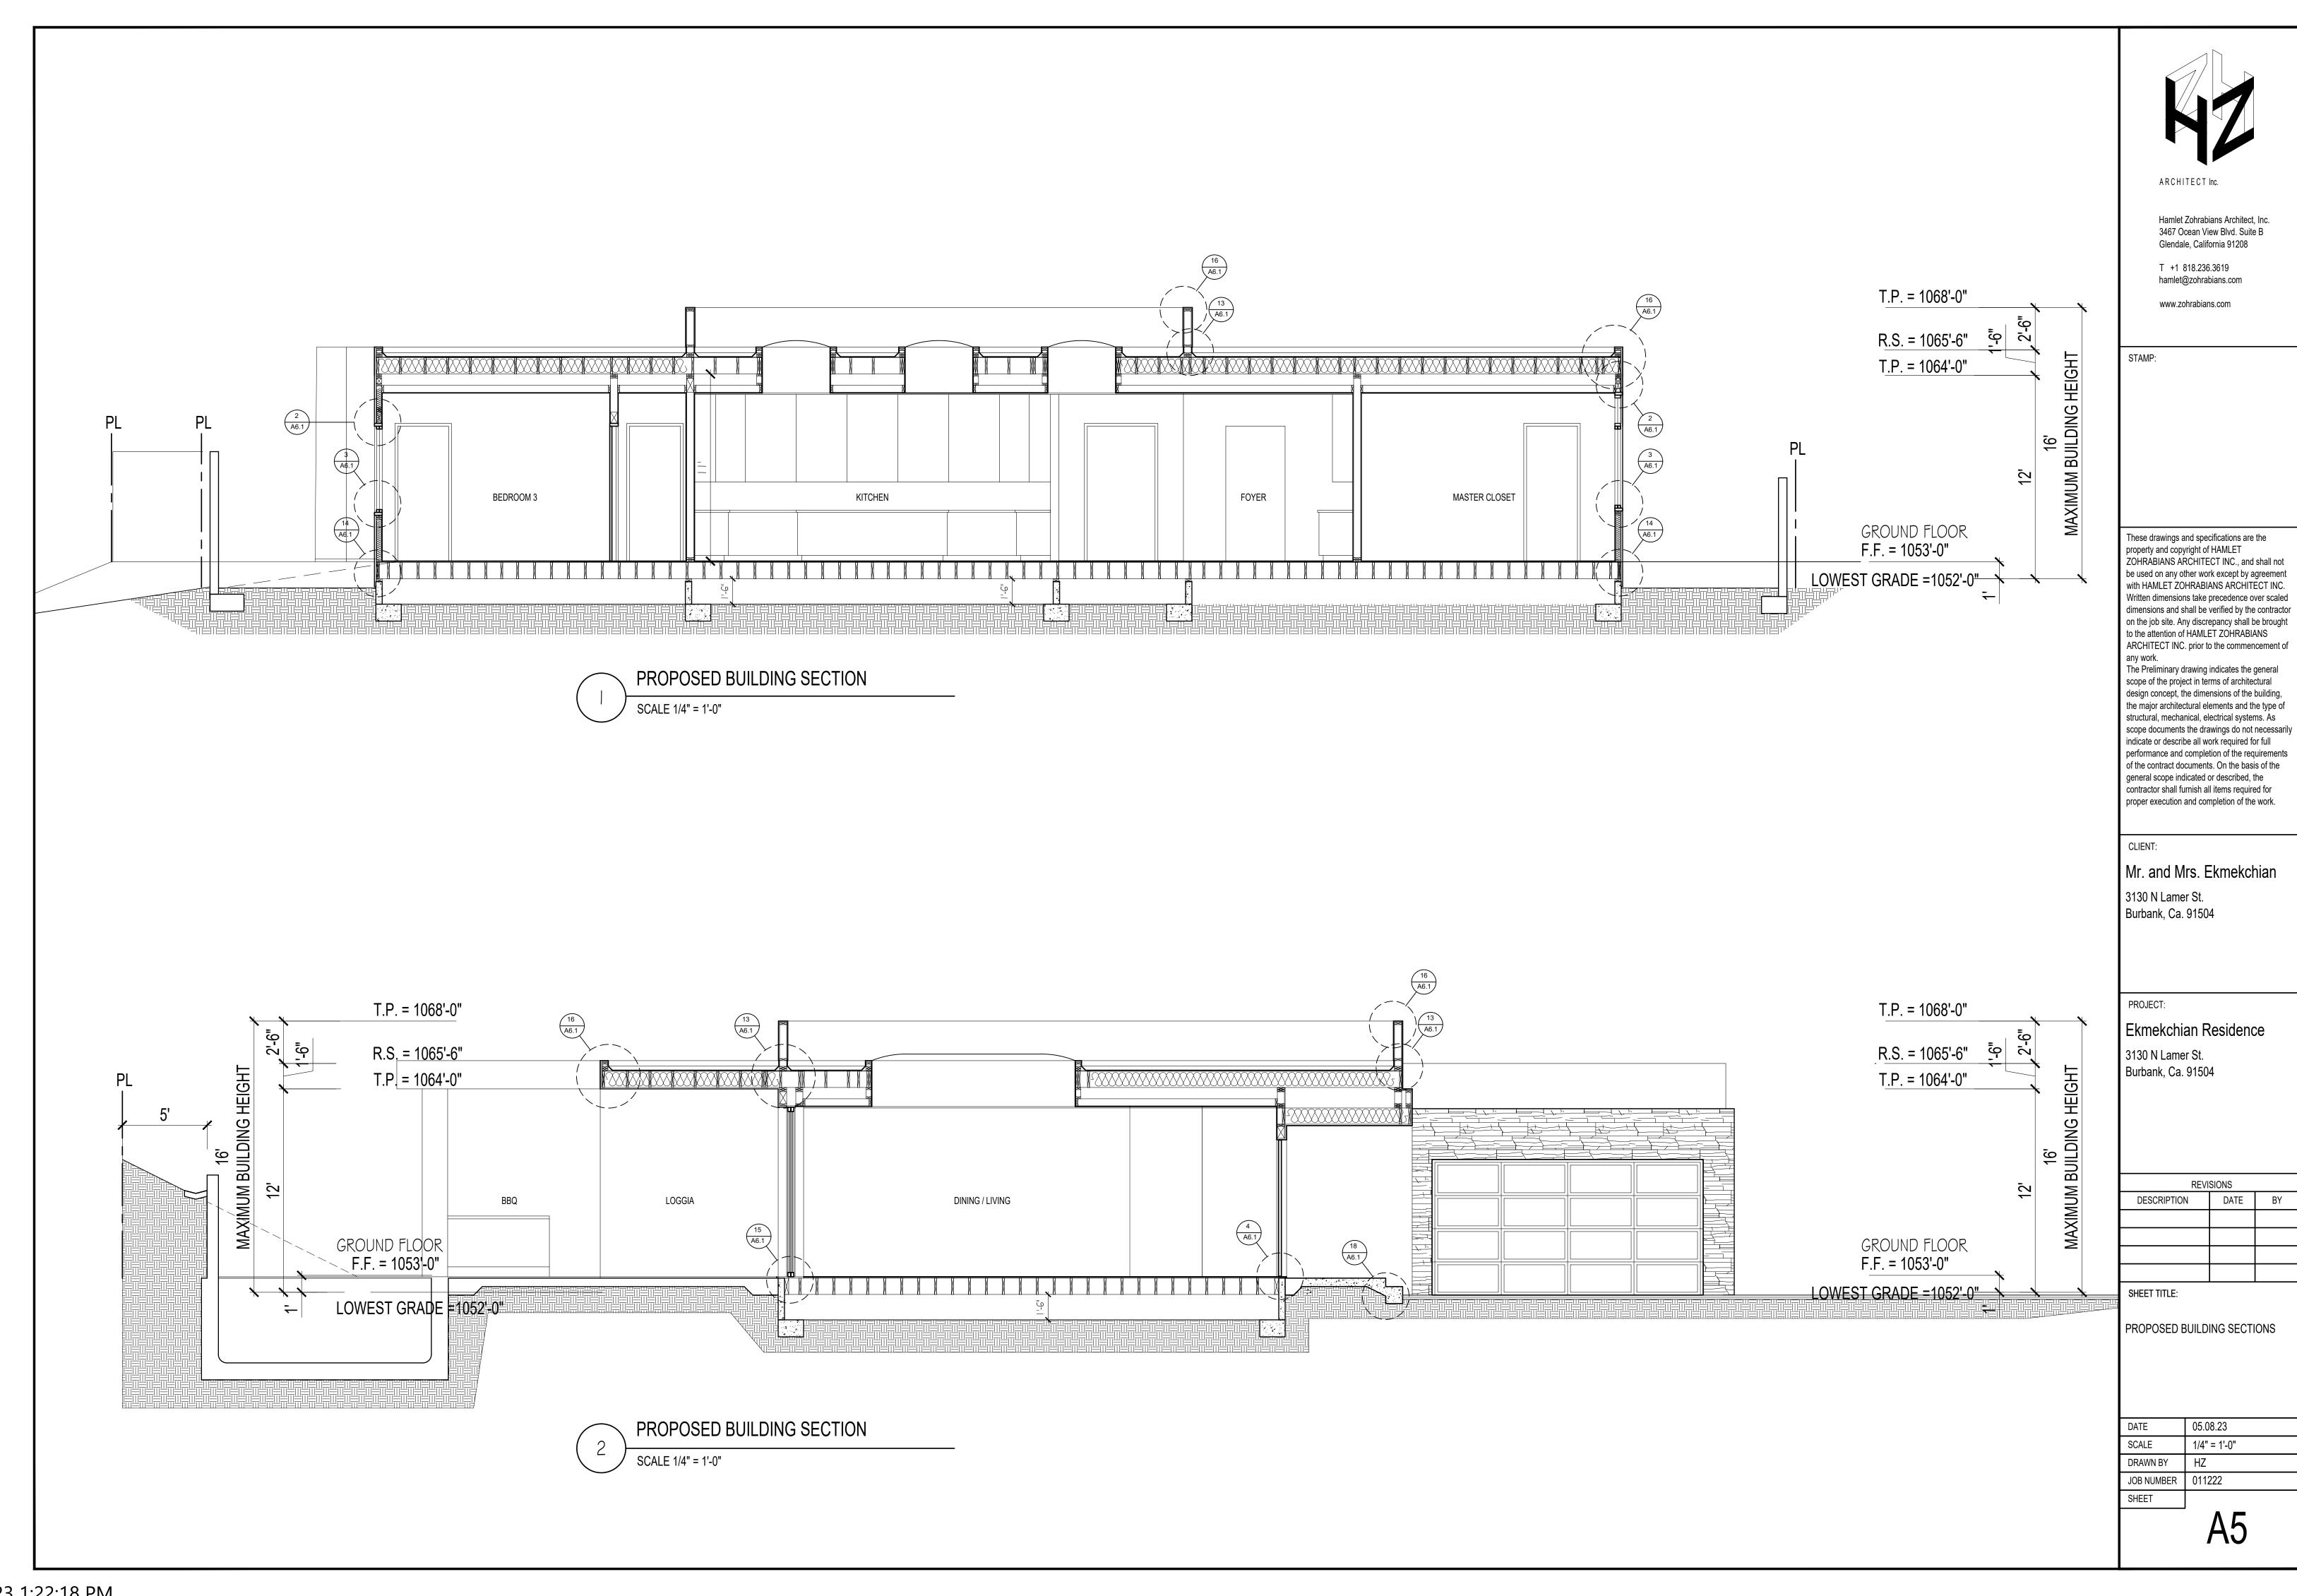U-FACTOR = 0.34

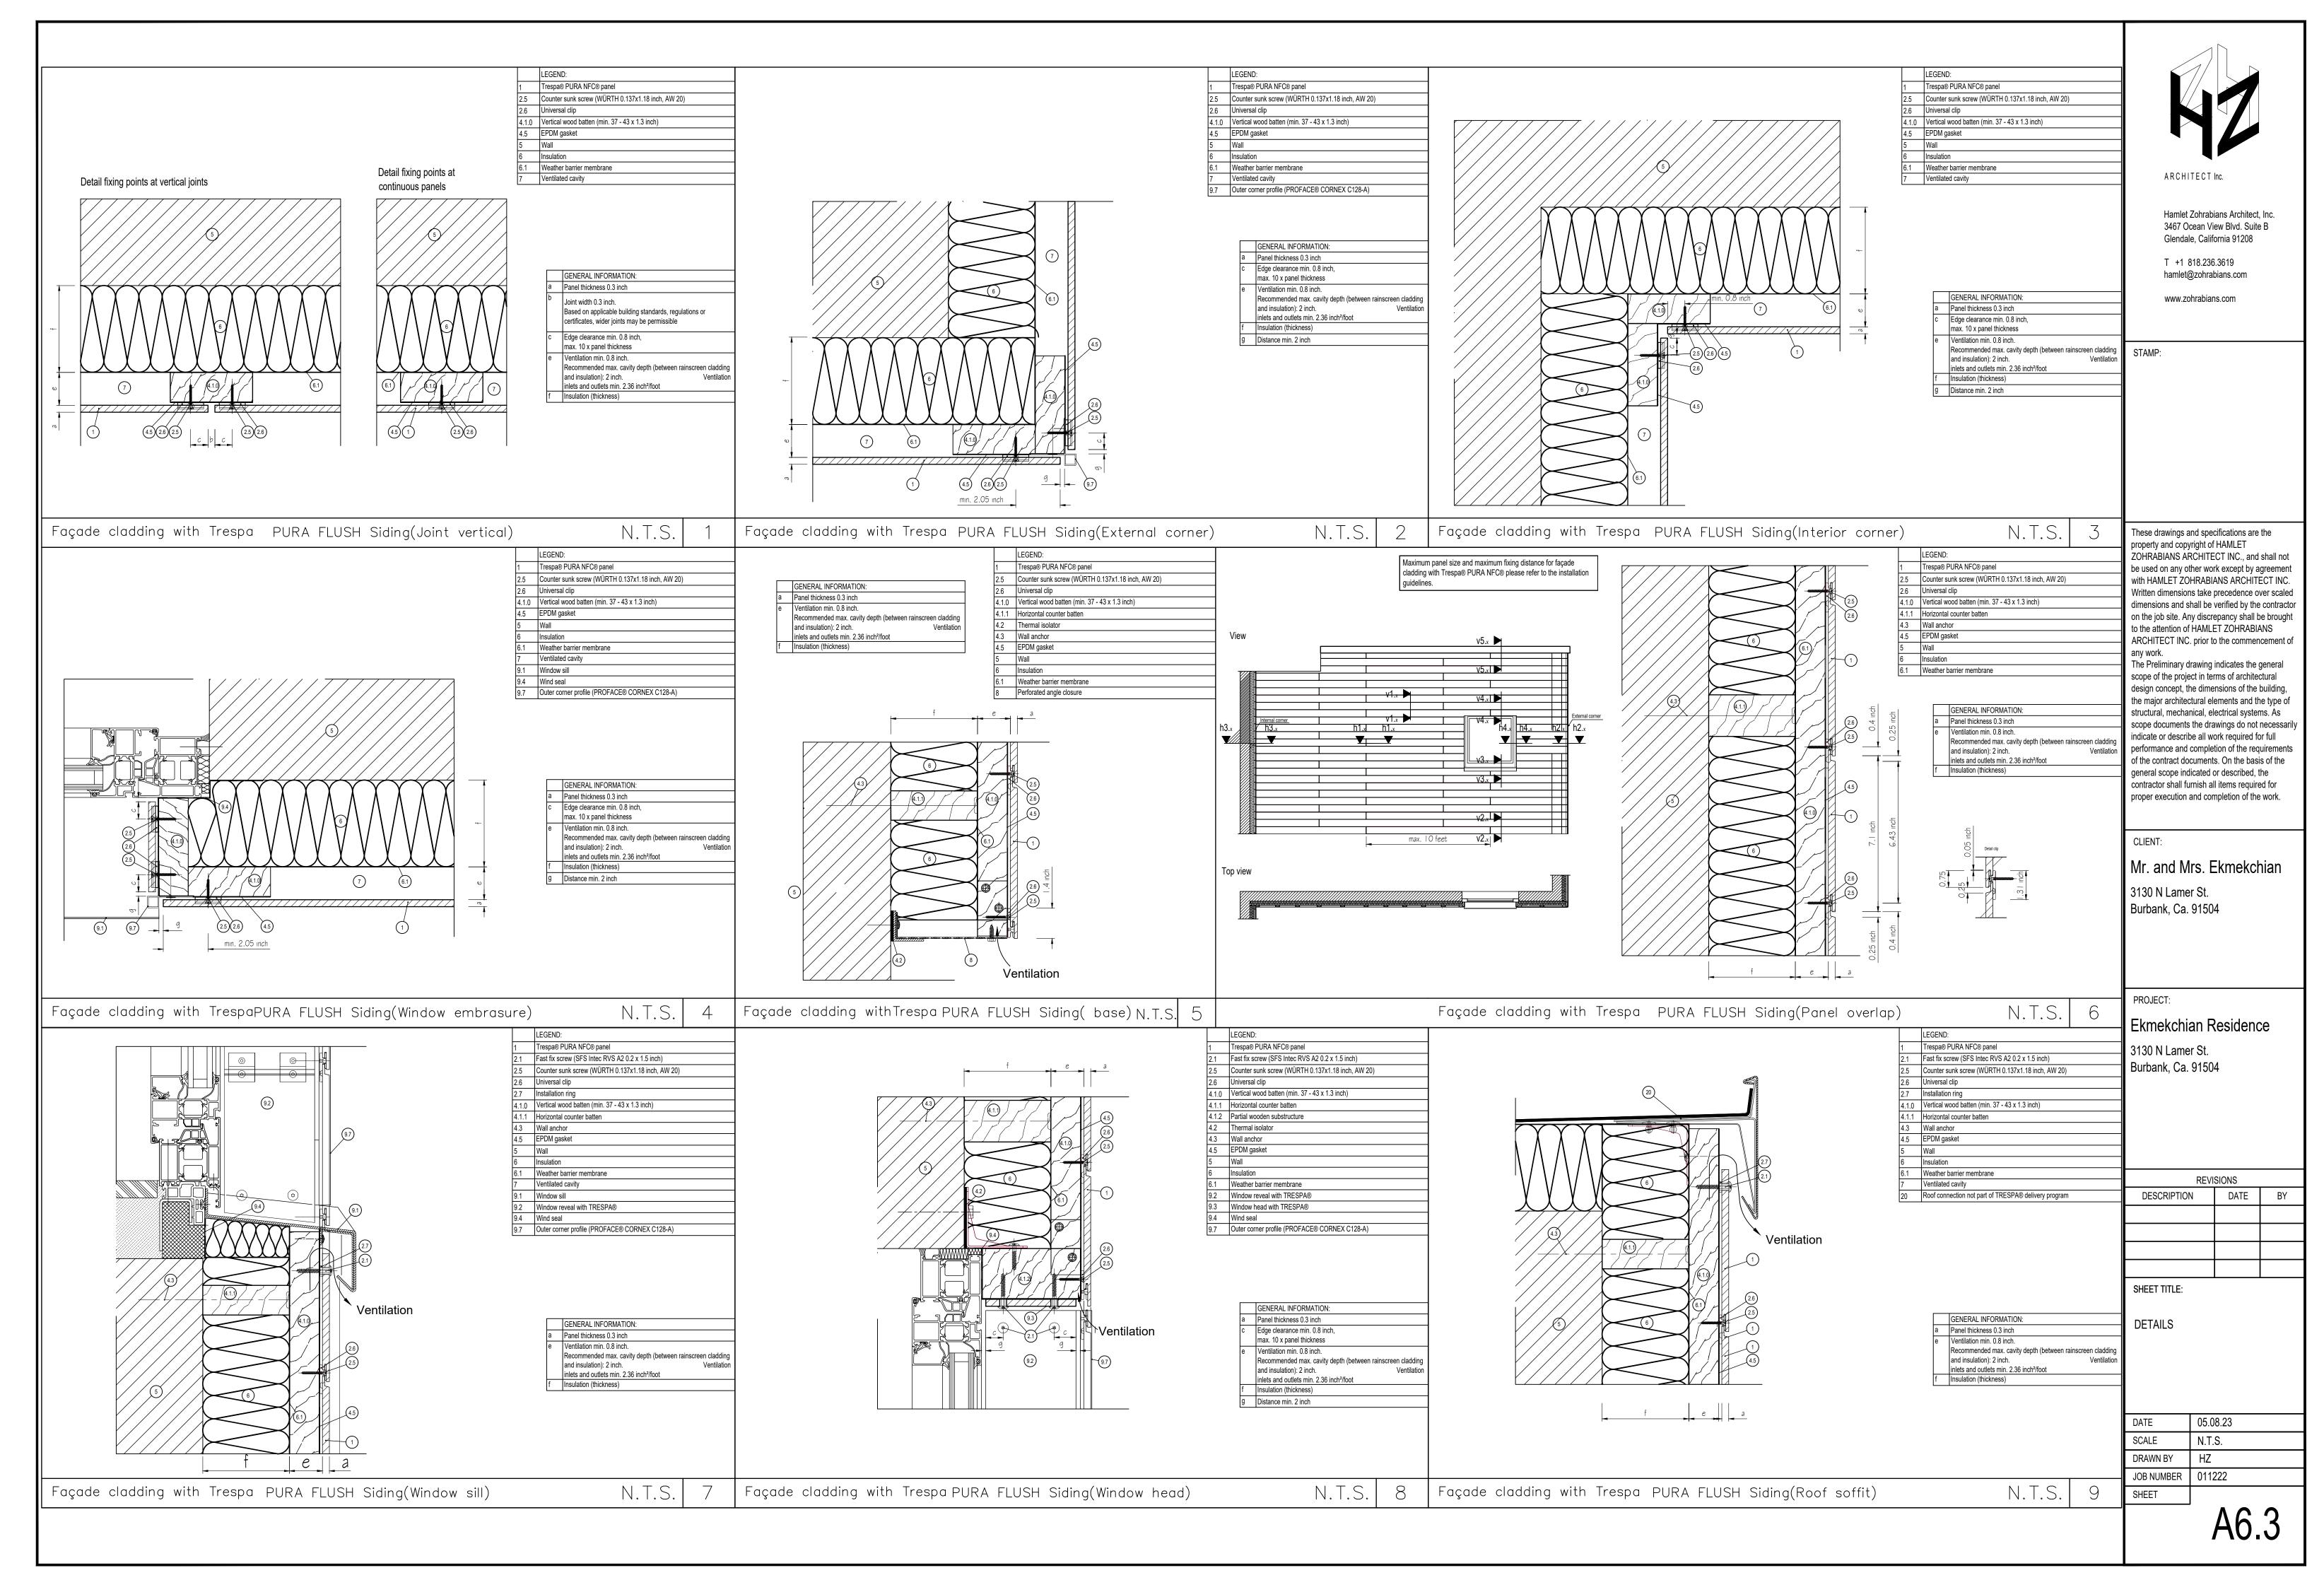SHGC = 0.33

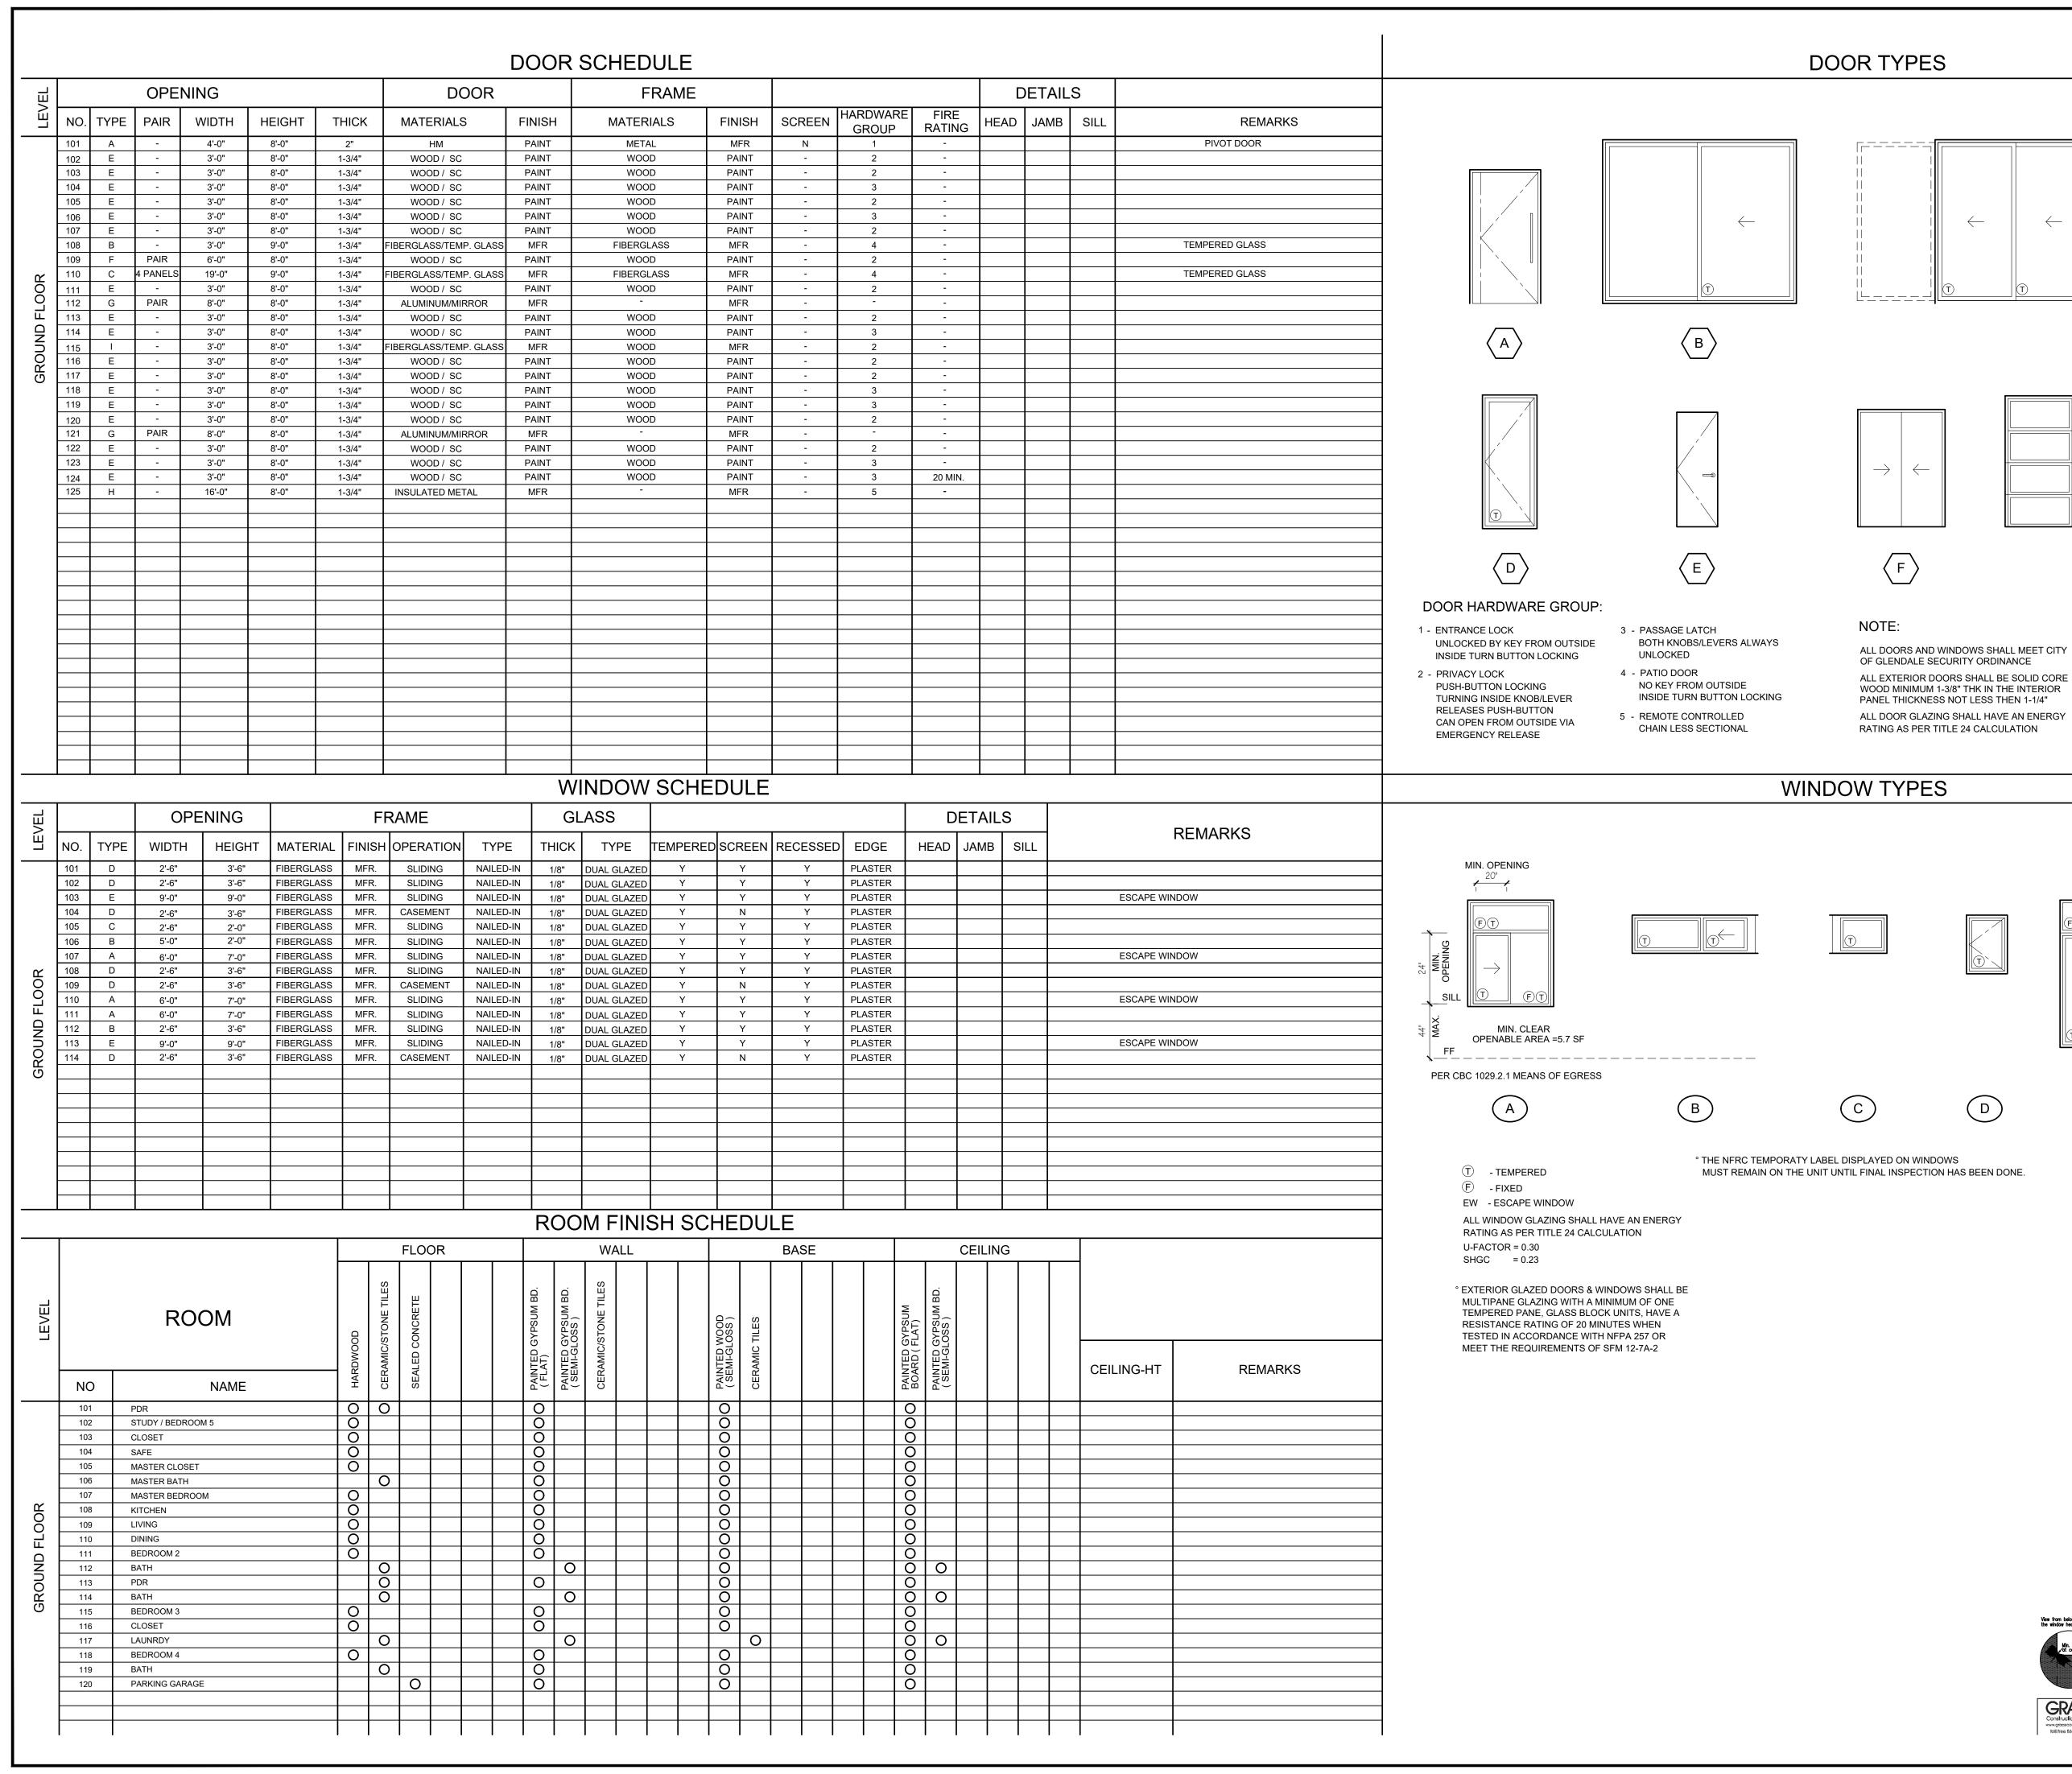WD - WOOD

GL - GLASS

 \rightarrow

E

MFR - MANUFACTURED

HC - HOLLOW CORE

SC - SOLID CORE

EXTERIOR GLAZING SHALL BE MULTI PANE UNITS

T - TEMPERED

F - FIXED

WITH A MINIMUM OF ONE TEMPERED PANE

 $\langle c \rangle$

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REVISIONS

DESCRIPTION DATE BY

SHEET TITLE:

Liquid Membrane overlapping min. 1/2 in. onto wall and flashing. Bituthene Mastic may be used with Perm-A-Barrier Wall Membrane

Step 6 - Installing a Patch at Upper Corners

Cut min. 6 in. long by 3 in. wide dog bone shaped patches of flashing (min. 1 in. wide at center) and install over both top corners of the jamb flashing. Press the patch that the corner to create a tight seal and prevent the patch from bridging at all 90 degree substrate angle changes.

This to Facilitate Installation

A. Pre-fold flashing into window opening with release liner still on.

B. Remove release liner from back side of flashing and roll firmly into place.

C. Use a V Shaped Roller at the Corners of the Window Opening.

WINDOW FLASHING DETAIL

DOOR / WINDOW AND ROOM FINISH SCHEDULES

DATE	05.08.23
SCALE	N.T.S.
DRAWN BY	HZ
JOB NUMBER	011222
SHEET	

A7

5/10/2023 1:22:58 PM