EXHIBIT D

PLAN SUBMITTAL



MARIPOSA GARDENS NEW 40-UNIT CONDOMINIUM COMPLEX

UPDATE TO REVISED SB35 FULL APPLICATION 11-07-2024

OWNER

BUTTERFLY GARDENS LLC. 1812 W. BURBANK BLVD., SUITE 7350 BURBANK, CA 91506

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DESIGN TEAM

ARCHITECT:

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PROJECT ARCHITECT: NATHAN BATTLE
PROJECT MANAGER: FARNOOSH FARMER
PROJECT TEAM: TRACY MINASIANS
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LANDSCAPE ARCHITECT:

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CIVIL ENGINEER:

KHR ASSOCIATES

17530 VON KARMAN AVE, SUITE 200

IRVINE, CA 92614

TEL: (949) 756-6440

ELECTRICAL ENGINEER:

NOVUS DESIGN STUDIO 155 S FAIROAKS AVE PASADENA, CA 91105 TEL: (818) 644-1309

GENERAL NOTES

1. THE PROJECT WILL COMPLY WITH BMC 10-1-1406 SITE PLAN AS APPLICABLE DURING THE PLAN CHECK.

2. THE PROJECT WILL COMPLY WITH BMC 10-1-1419 PARKING STRUCTURES AS APPLICABLE DURING THE PLAN CHECK.

3. THE PROJECT WILL COMPLY WITH BMC 10-1-1420 LIGHTING AS APPLICABLE DURING THE PLAN CHECK.

4. THE PROJECT WILL COMPLY WITH BMC 10-1-624 (E) YARD SETBACK ENCORACHMENTS AS APPLICABLE DURING THE PLAN CHECK.

5. THE PROJECT WILL COMPLY WITH BMC 10-1-624 (H) FENCES, WALLS, HEDGES AND OTHER YARD FEATURES AS APPLICABLE DURING THE PLAN CHECK.

6. THE PROJECT WILL COMPLY WITH BMC 10-1-624 (L) COMMON AREAS AND AMENITIES AS APPLICABLE DURING THE PLAN CHECK.

7. THE PROJECT WILL COMPLY WITH BMC 10-1-624 (N) LANDSCAPING AS APPLICABLE DURING THE PLAN CHECK.

8. THE PROJECT WILL COMPLY WITH BMC 10-1-624 (Q) WINDOWS AND AWNINGS AS APPLICABLE DURING THE PLAN CHECK.

9. THE PROJECT WILL COMPLY WITH BMC 10-1-624 (T) BALCONIES AND STAIRWAYS AS APPLICABLE DURING THE PLAN CHECK.

10. THE PROJECT WILL COMPLY WITH BMC 10-1-624 (V) LIGHTING AS APPLICABLE DURING THE PLAN CHECK.

11. THE PROJECT WILL COMPLY WITH BMC 10-1-624 (W) OTHER FEATURES AS APPLICABLE DURING THE PLAN CHECK.

12. ALL AMENITIES SHALL BE PERMENANTLY INSTALLES AS PART OF THE PROJECT UNLESS OTHERWISE APPROVED BY THE DIRECTOR PER BMC 10-1-624 (L).

13. THE CONCEPTUAL LANDSCAPE PLANS TO BE UPDATED DURING THE PLAN CHECK TO REFLECT THE PLANTING SCHEME AS PROPOSED ON THE ARCHITECTURAL SITE PLAN.

14. ALL LANSCAPE AREAS SHALL PROVIDE MINIMUM SOIL DEPTHS AS FOLLOWS:

- 12 INCHES FOR AREAS PLANTED WITH DROUGHT-TOLERANT GROUND COVER;

- 18 INCHES FOR PLANTERS AND AREAS PLANTED WITH DROUGHT-TOLERANT SHRUBS AND SIMILAR VEGETATION.
- 4 FEET FOR PLANTERS OR AREAS PLANTED WITH TREES.

15. PLANTER DRAINAGE TO BE PROVIDED AS PER BMC 10-1-624 (N)(8).

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PROJECT DIRECTORY/ SHEET INDEX

PROJECT DATA

PROJECT ADDRESS:

910 S. MARIPOSA ST., BURBANK, CA 91506

APN: 2443-004-017

ZONING: M-1 (LIMITED INDUSTRIAL)
GENERAL PLAN: RANCHO COMMERCIAL
SPECIFIC PLAN: RANCHO MASTER PLAN

GROSS LOT AREA BEFORE DEDICATION: ± 43,688.62 SQ.FT. GROSS LOT AREA AFTER DEDICATION: ± 38,361.13 SQ.FT

ALLOWABLE LOT COVERAGE: 80 % MAX. $=> 43,688.62 \times .80 => \pm 34,950.89 \text{ SQ.FT.}$

PROPOSED LOT COVERAGE: ± 14,665.3 SQ.FT. => 33.5%

PROPOSED STORIES: 5 STORIES

PROPOSED BUILDING HEIGHT: 63'-8 1/2" FROM AVERAGE GRADE TO TOP OF PLATE

68'- 5 1/2" FROM AVERAGE GRADE TO TOP OF ARCHITECTURAL FEATURE (BMC 10-1-1301)

REIDENTIAL DENSITY MAX. => 20 UNITS PER ACRE

ALLOWABLE NUMBER OF UNITS: 1 X 20 => 20 UNITS (PER GENERAL PLAN)

PROPOSED NUMBER OF UNITS: 40 UNITS

INCLUDING 3 VERY-LOW INCOME AND 3 MODERATE

INCOME AFFORDABLE UNITS

CONSTRUCTION TYPE:

PARKING GARAGE: I-A; RESIDENTIAL: III-A

OCCUPANCY TYPE:

PARKING GARAGE: S-2; RESIDENTIAL: R-2

PARKING ANALYSIS*

TOTAL PARKING REQUIRED PER BMC => 1.5 CAR PER 2-3 BED UNIT => 40 X 1.5 => 60 TOTAL PARKING REQUIRED PER SB35 => 1 PER UNIT => 40 X 1 => 40 STALLS

(CALIFORNIA GOVERNMENT CODE 65913.4)

TOTAL PARKING PROVIDED => 45 STALLS

ACCESSIBLE PARKING REQUIRED PER CBC 1109A.3: 2% OF UNITS => 1 STALL

ACCESSIBLE PARKING PROVIDED => 2 STALLS

BICYCLE PARKING SPACE REQUIRED PER BMC => 0.25 PER UNIT: 40 X 0.25 => 10 SPACES

REQUIRED LONG-TERM SPACES => 75% => 8 SPACES REQUIRED SHORT-TERM SPACES => 25% => 2 SPACES

BICYCLE SPACES PROVIDED: 10 SPACES (INCLUDING 8 LONG-TERM AND 2 SHORT-TERM)

*CALCULATED PER DENSITY BONUS ORDINANCE REDUCED PARKING RATES

RESIDENTIAL UNIT CONFIGURATION

2 BEDROOMS => 31 UNITS 3 BEDROOMS => 9 UNITS TOTAL UNITS => 40 UNITS

LEVEL		חבת			UNIT AR			DATIO	DALCONY	COMMON	COMMON
l (ii	UNIT NUMBER	BED.	ВАТН.	CONDO	TOWNHOME LEVEL 1	TOWNHOME LEVEL 2	TOWNHOME TOTAL	PATIO	BALCONY	CIRCULATION AREA	AREA
	101	2	2.5	1,259.3 SF				112 SF			
l	102	2	2.5	1,232.0 SF				87.5 SF			
l	103*	2	2	1,020.7 SF				106 SF			
~	104*	3	3.5	1,512.5 SF				90 SF			
FLOOR	105	2	2	964.2 SF				106 SF		±2,062.4	±9,844.6
FIRST I	106*	2	2	1,080.25 SF				94.5 SF		SQUARE FEET	SQUARE FEET
	107	2	2	946.2 SF				106 SF			
	108	2	2.5	1,282.0 SF				90 SF			
	109	2	2.5	1,258.0 SF				92 SF			
	110	2	2	1,048.25 SF				105 SF			
	201	2	2.5	1,259.3 SF					93.3 SF		
	202	2	2.5	1,232.0 SF					93 SF		/
	203	2	2	1,020.7 SF					106 SF		
FLOOR	204	3	3.5	1,512.5 SF					72.5 SF	±2,099.4	
	205*	2	2	964.2 SF					106 SF		
SECOND	206	2	2	1,080.25 SF					94.5 SF	SQUARE FEET	
SE	207*	2	2	946.2 SF					106 SF		
	208	2	2.5	1,282.0 SF					70 SF		
	209	2	2.5	1,258.0 SF					93 SF		
	210	2	2	1,125.7 SF					105 SF		
	301	2	2.5	1,259.3 SF					93.3 SF		
	302	2	2.5	1,232.0 SF					93 SF		
	303*	2	2	1,020.7 SF					106 SF	±2,099.4	
~	304	3	3.5	1,512.5 SF					72.5 SF		
FLOOR	305	2	2	964.2 SF					106 SF		
THIRD F	306	2	2	1,080.25 SF					94.5 SF	SQUARE FEET	
=	307	2	2	946.2 SF					106 SF		
	308	2	2.5	1,282.0 SF					70 SF		
	309	2	2.5	1,258.0 SF					93 SF		
	310	2	2	1,125.7 SF					105 SF		/
	401	2	2.5	1,259.3 SF					93.3 SF		,
	402	2	2.5	1,232.0 SF					93 SF		
	403-TH	3	3.5		949.2 SF		1,810.9 SF		162.2 SF		
ÕR	404	3	3.5	1,512.5 SF					72.5 SF		
H FLOOR	405-TH	3	3.5		883.0 SF		1,681.0 SF		168.5 SF	±2,099.4	
FOURTH	406-TH	3	3.5		986.0 SF		1,895.2 SF		169 SF	SQUARE FEET	
FO	407-TH	3	3.5		883.0 SF		1,681.0 SF		168.5 SF		
	408-TH	3	3.5		1,230.25 SF		2,122.6 SF		118 SF		
	409	2	2.5	1,258.0 SF					93 SF		
	410	2	2	1,125.7 SF					105 SF		
	403-TH	3	3.5			861.7 SF	1,810.9 SF		84 SF		
<u>ښ</u>	405-TH	3	3.5			798.0 SF	1,681.0 SF		84 SF		
FLOOR	406-TH	3	3.5			909.2 SF	1,895.2 SF		114.7 SF	±1,247.2 SQUARE	±6,514.2 SQUARE
FIFTH	407-TH	3	3.5			798.0 SF	1,681.0 SF		84 SF	FEET	FEET
	408-TH	3	3.5			892.4 SF	2,122.6 SF		221 SF		
	TOT	AL			50,543	<u> </u>	l	4,690	<u> </u>	9,607.8 SF	16,358.8 S
* /	AFFORDABLE							<u>I</u>			<u> </u>
TH	=> TOWNH	OME									

TOTAL PARKING AREA (INCLUDING COMMON AREA) => $\pm 19,970.5$ SQ.FT. TOTAL BUILDING AREA MINUS PARKING => $\pm 50,543.3$ SQ.FT.

TOTAL BUILDING AREA PLUS PARKING $=> \pm 70,513.8$ SQ.FT.

PROJECT DESCRIPTION:


- DEMOLITION OF THE EXISTING ONE-STORY STRUCTURE
- CONSTRUCTION OF A NEW 5-STORY, 40-UNITS MULTI-FAMILY

DWELLING (INCLUDING 3 VERY-LOW INCOME AND 3 MODERATE INCOME AFFORDABLE UNITS) WITH ONE LEVEL OF SEMI-SUBTERRANEAN PARKING AND ROOF TOP COMMON AREA.

APPLICABLE CODES:

- 2022 CALIFORNIA GREEN BUILDING STANDARDS
- 2022 CALIFORNIA BUILDING ENERGY EFFICIENCY STANDARDS
- 2022 CALIFORNIA BUILDING CODE (CBC)
- 2022 CALIFORNIA RESIDENTIAL CODE (CRC)
- 2022 CALIFORNIA ELECTRICAL CODE (ERC)
- 2022 CALIFORNIA PLUMBING CODE (CPC)
- 2022 CALIFORNIA MECHANICAL CODE (CMC)
- 2022 CALIFORNIA FIRE CODE (CFC)
- 2022 CALIFORNIA ENERGY CODE (CENC)
- TITLE 9, CHAPTER 1, OF THE BURBANK MUNICIPAL CODE
- ALL INTERVENING CODE CYCLES.

VICINITY MAP:

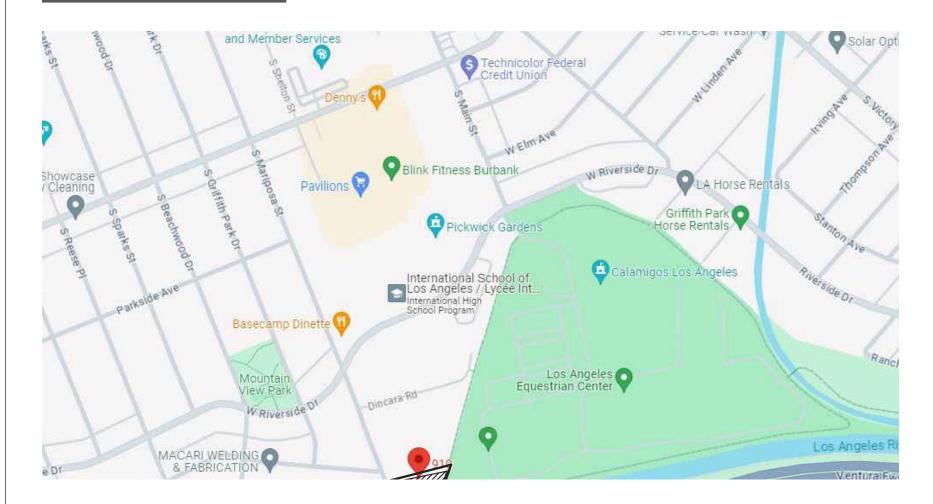

LANDSCAPE ANALYSIS

REQUIRED PRIVATE OUTDOOR SPACE: 70 SQ.FT PER UNIT = 40 X 70 = 2,800 SQ.FT. MIN.

PROVIDED PRIVATE OUTDOOR SPACE: 4,151.2 SQ.FT.

(PRIVATE OPEN SPACE WITH MIN 5' DIMENSION)

REQUIRED COMMON OPEN SPACE: 100 SQ.FT PER UNIT = 40 X 100 = 4,000 SQ.FT. MIN.

PROVIDED COMMON OPEN SPACE: 9,725.6 SQ.FT

PROVIDED ADDITIONAL OPEN SPACE: 5,966.2 SQ.FT (ON UPPER LEVELS)

LOT AREA AFTER DEDICATION+ REQ 12'-9" FRONT YARD:

36,525.5 SQ. FT.

REQUIRED LANDSCAPING ON LOT: MIN 10% OUTSIDE THE REQUIRED FRONT YARD

3,652.5 SQ. FT.


PROVIDED LANDSCAPING ON LOT: 21,525 SQ.FT

(SEE LANDSCAPE PLANS FOR DETAILED INFO)

PROJECT INFORMATION

BOLADarck

BOLADarck + N. Battle A.I.A. Architect, Inc.

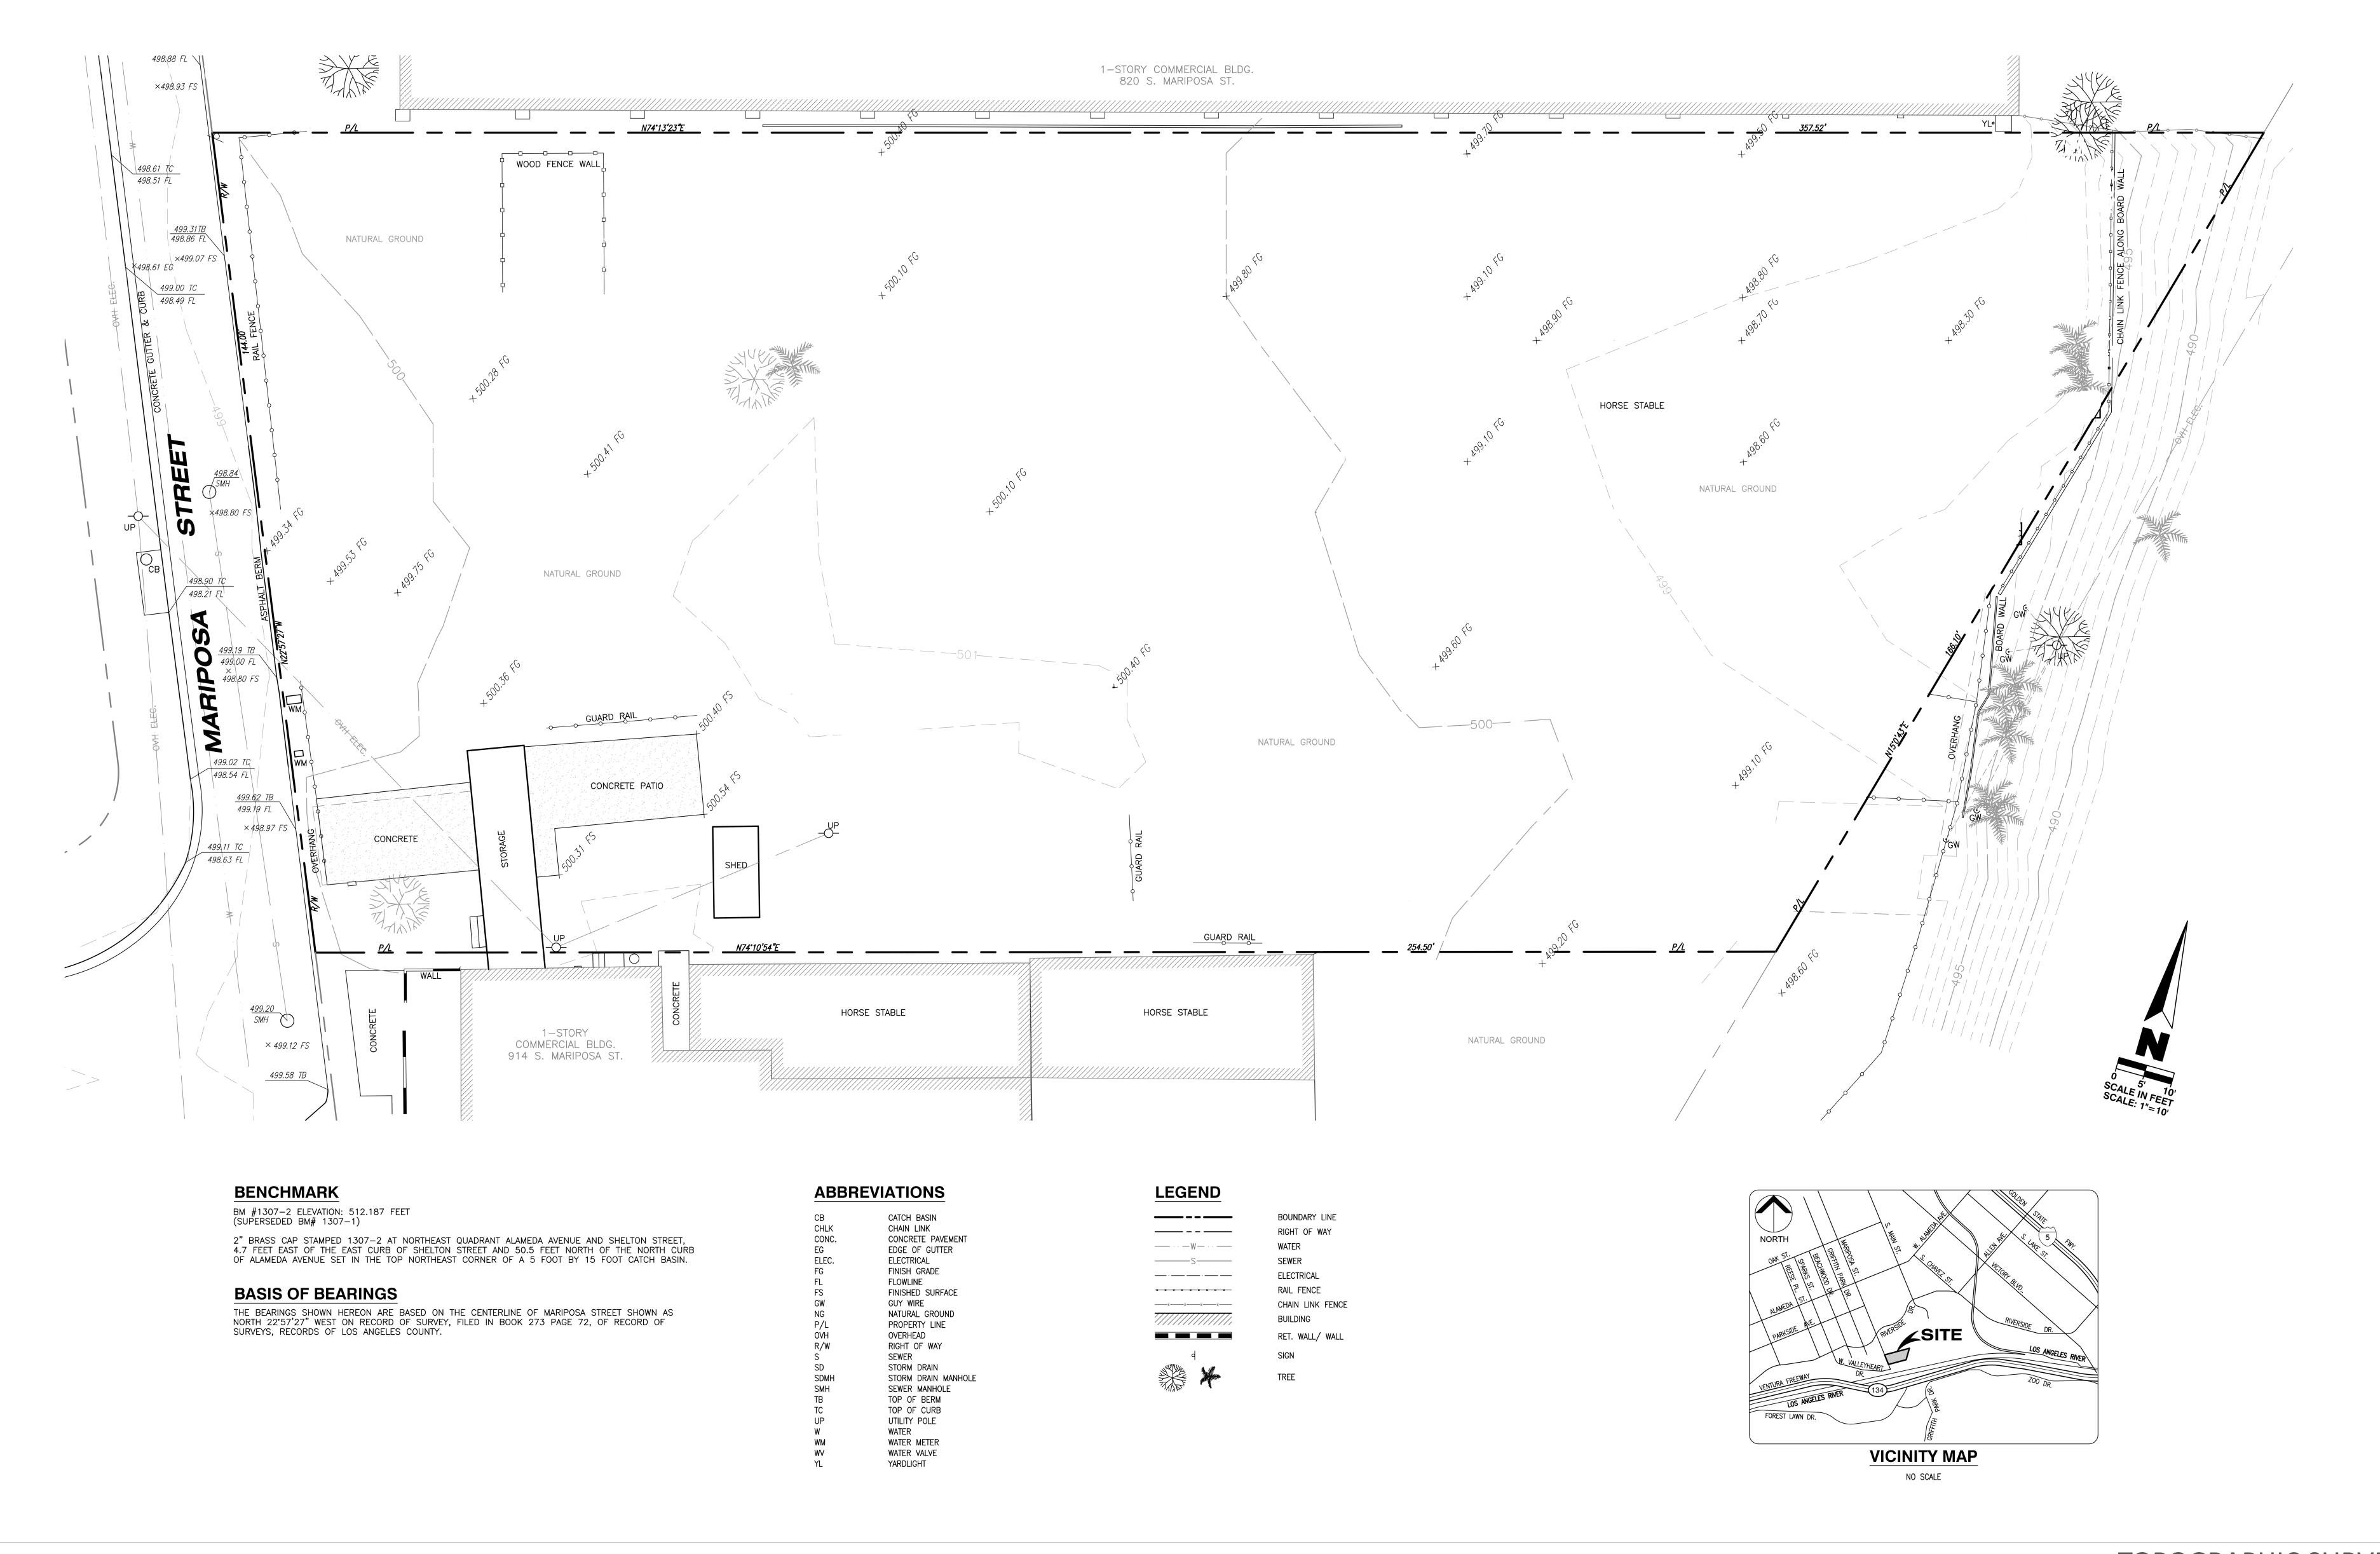


TOPOGRAPHIC SURVEY




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CURRENT SITE CONDITIONS:







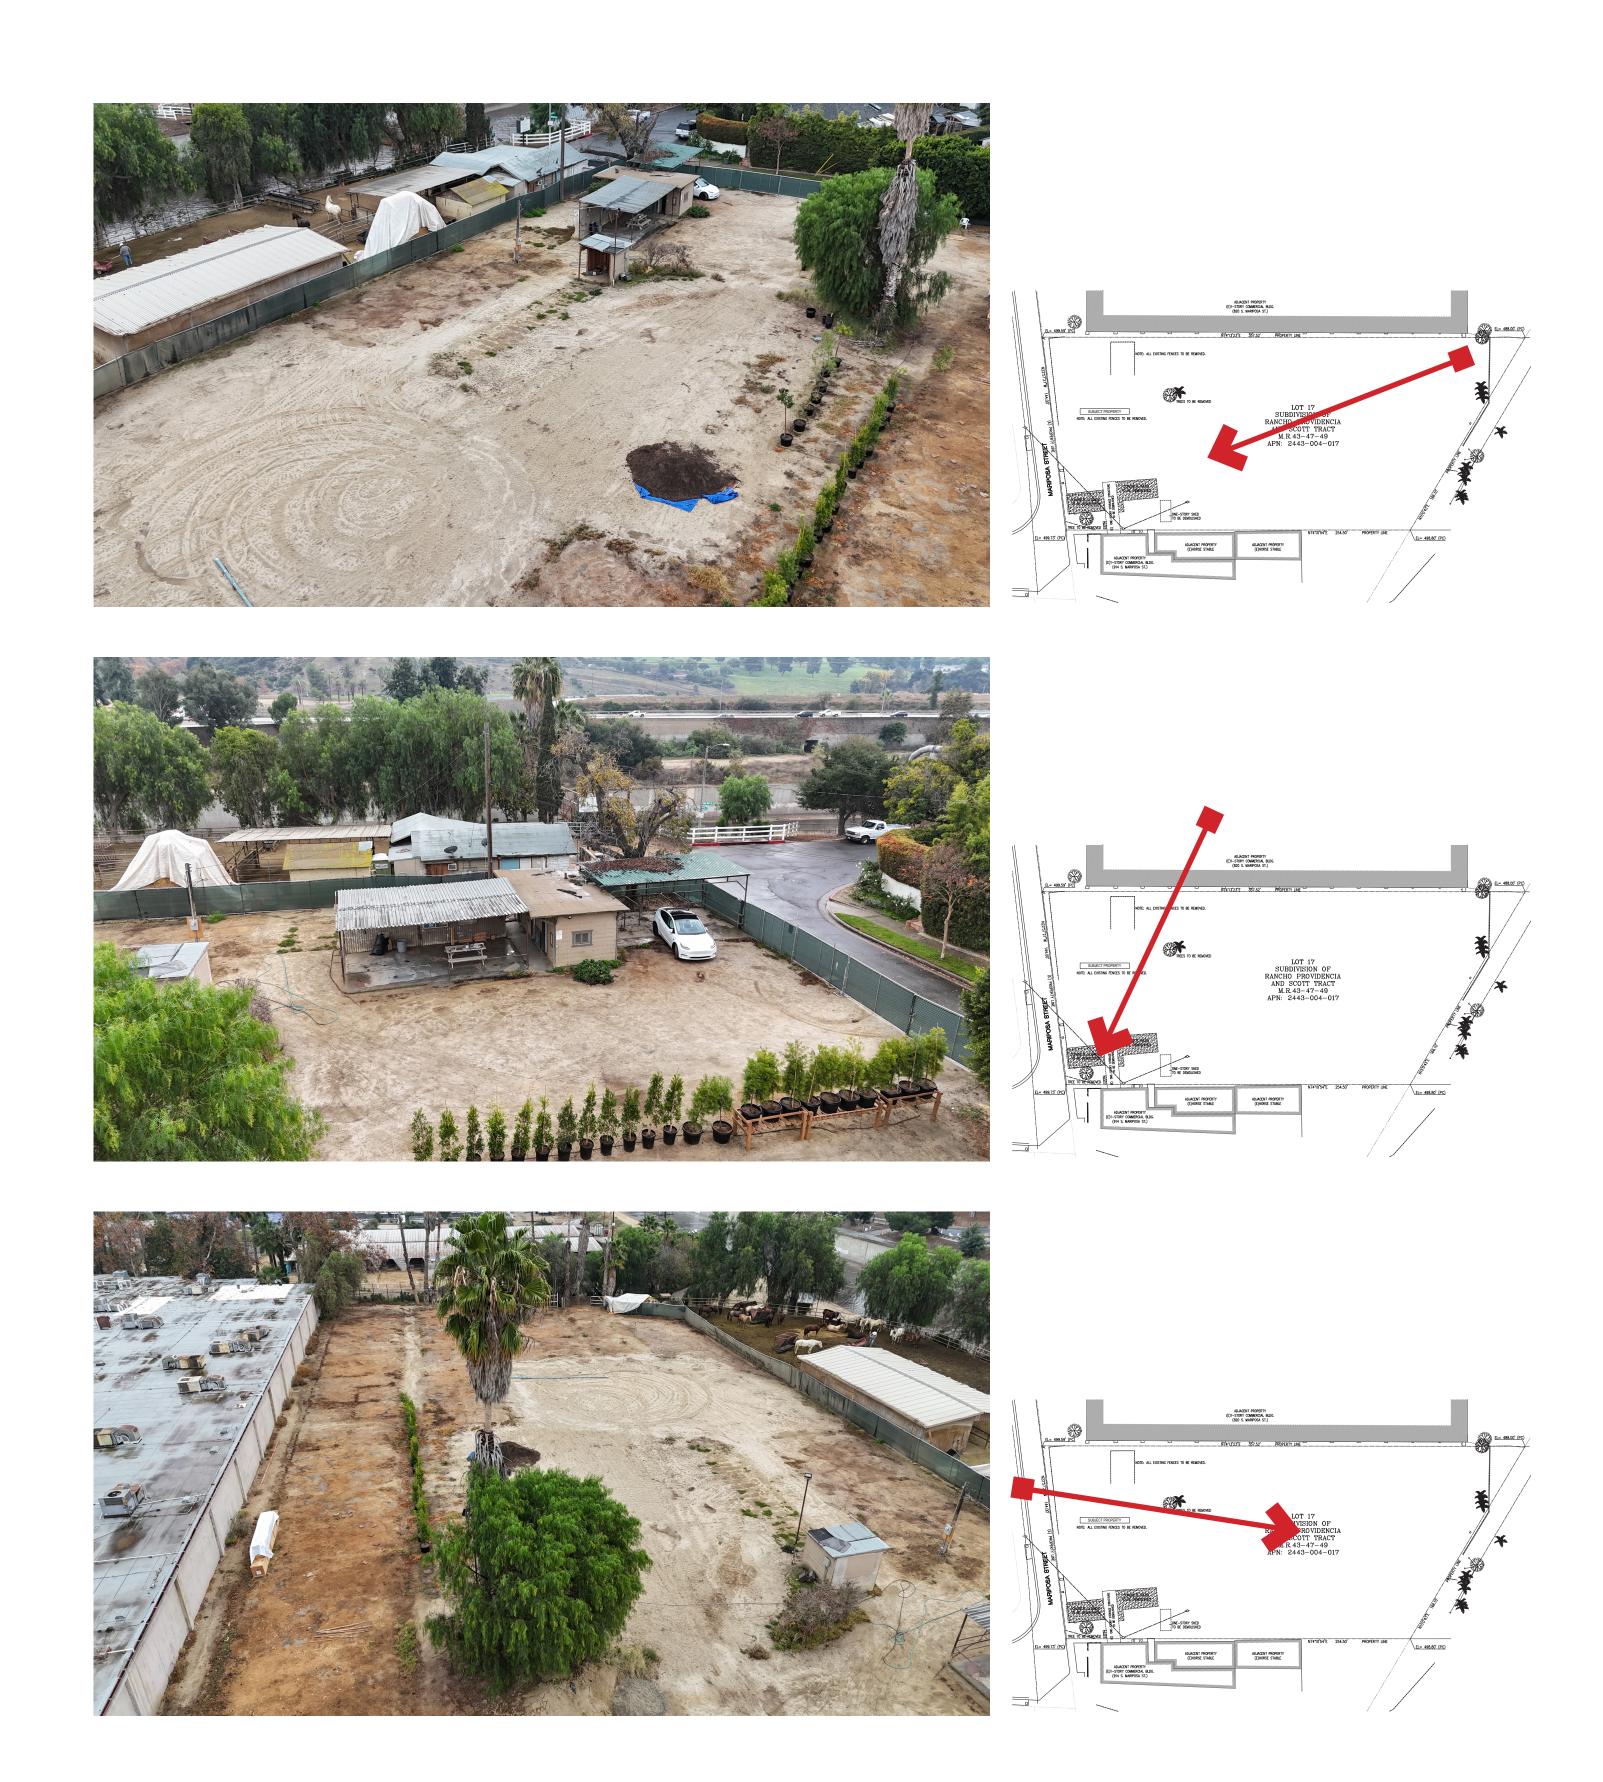


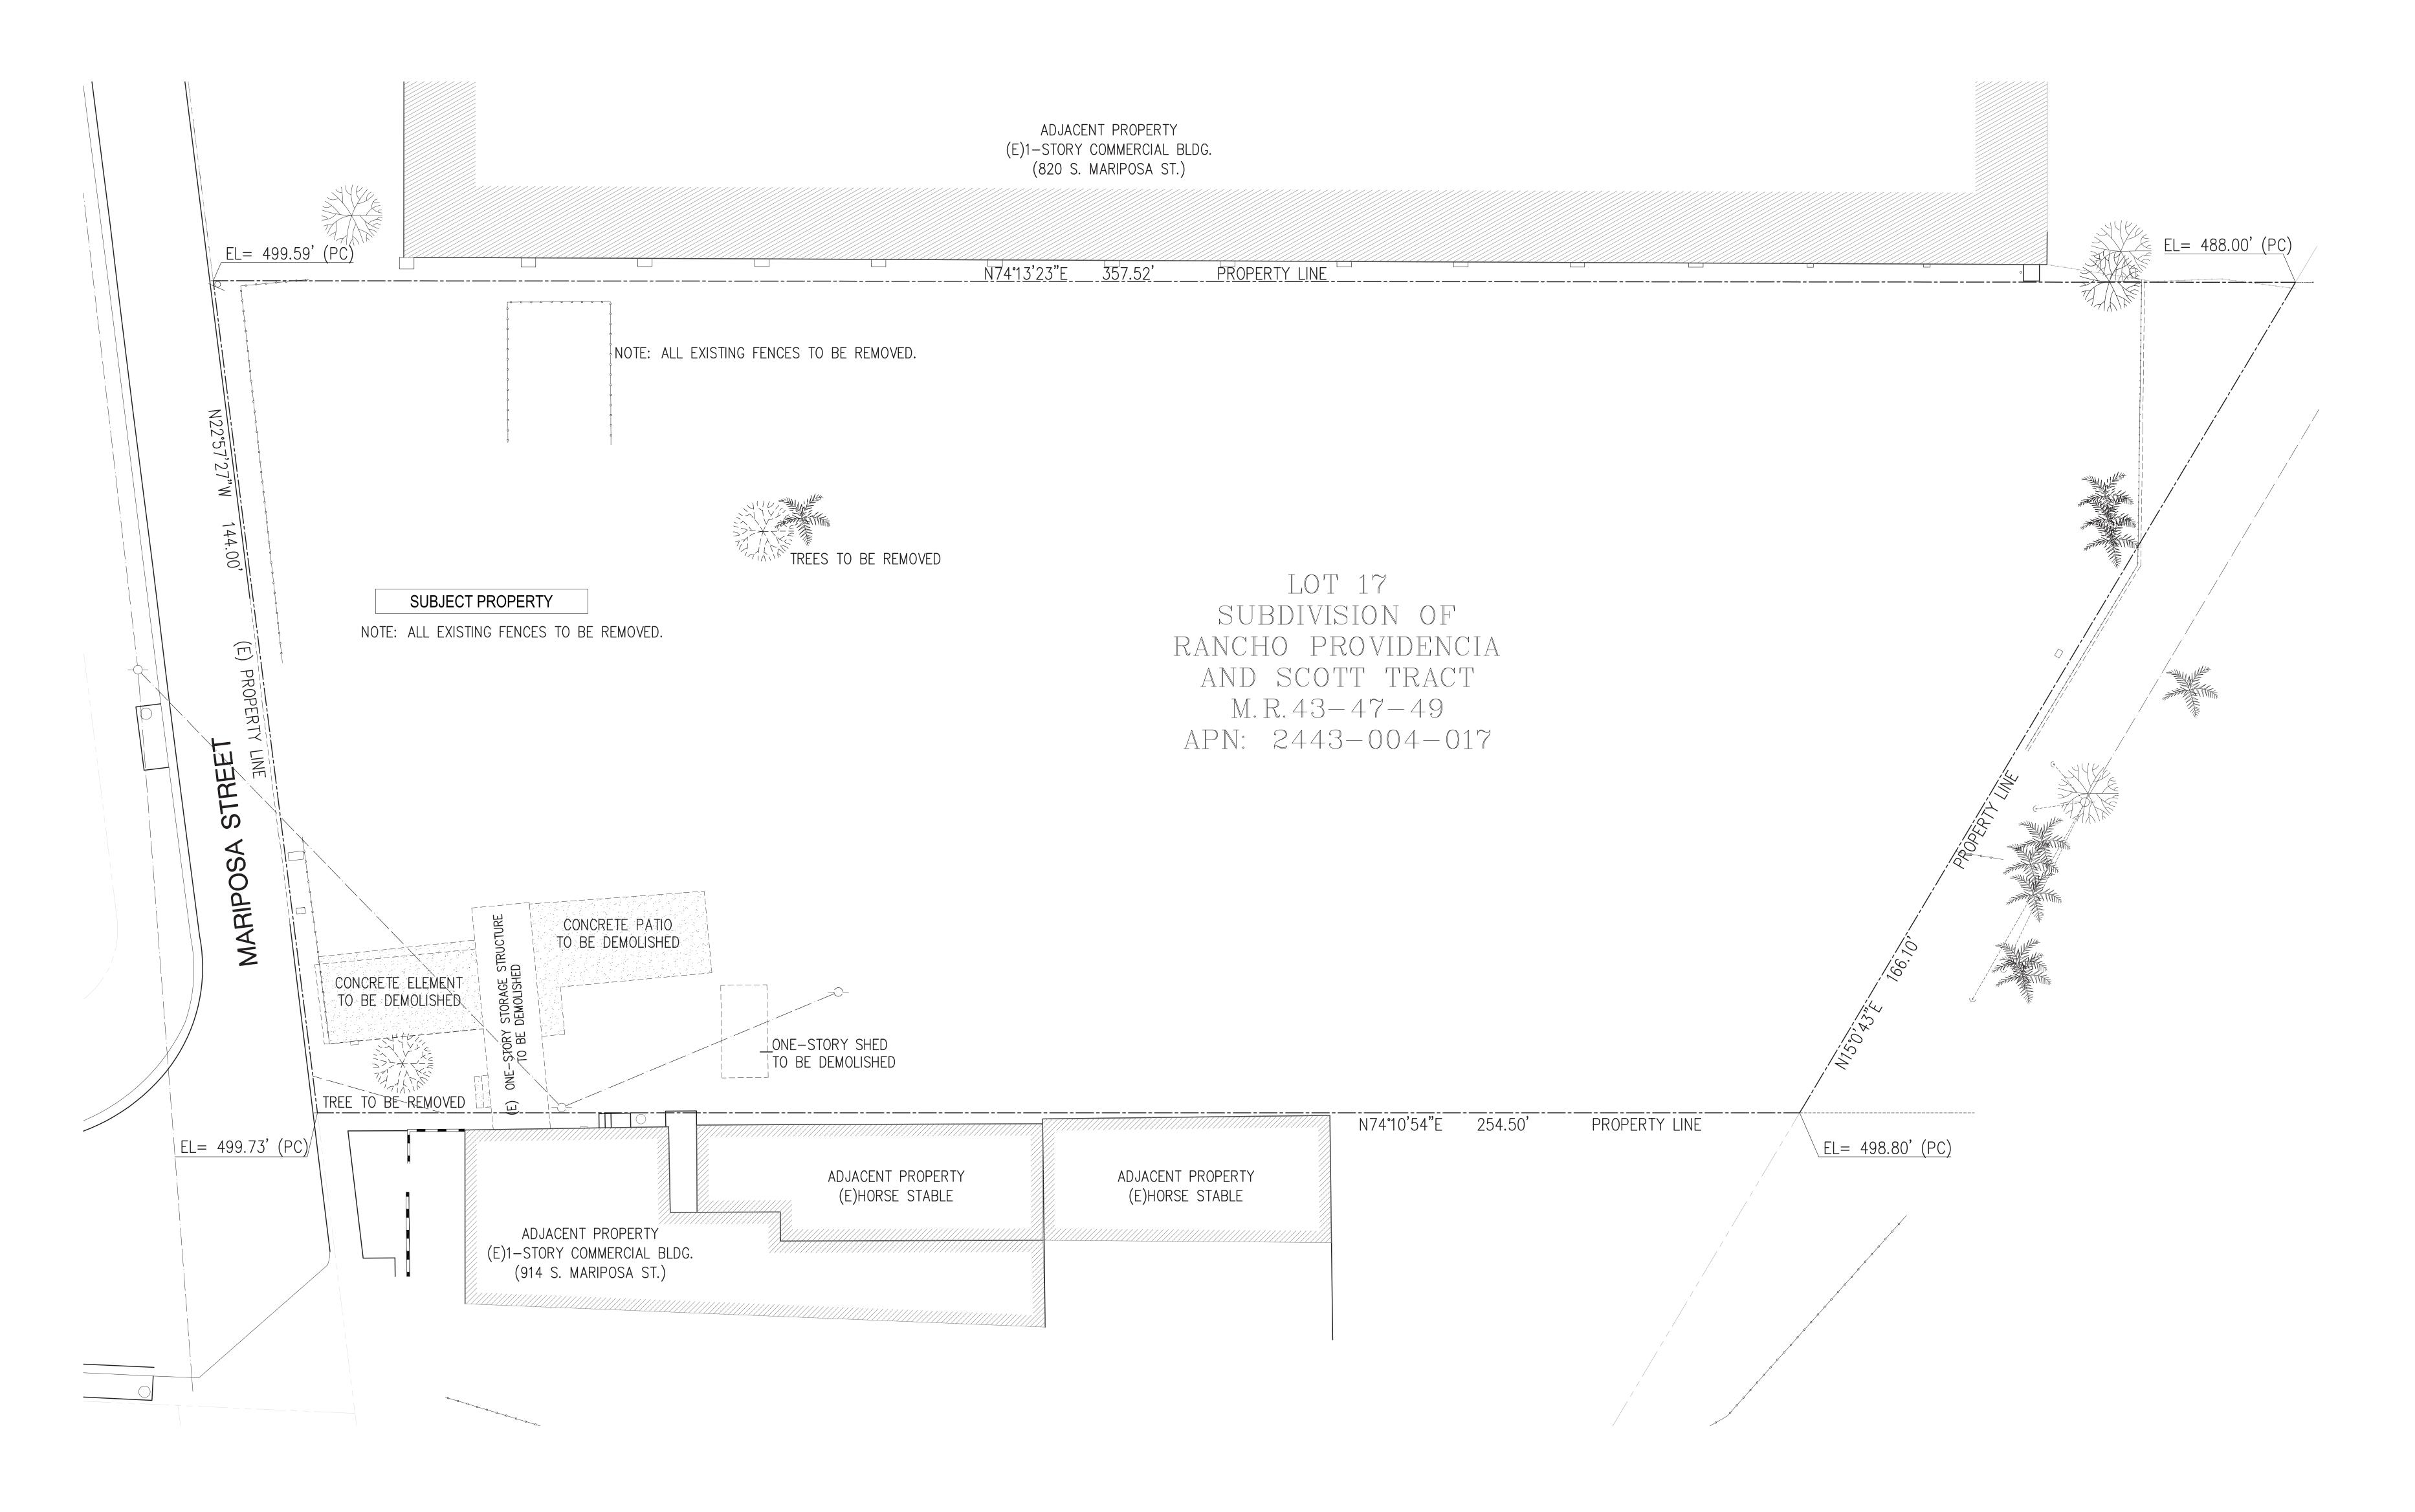SCALE: 3/32" = 1'-0"

DEMOLITION PLANS

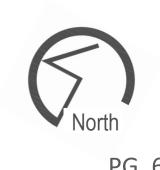


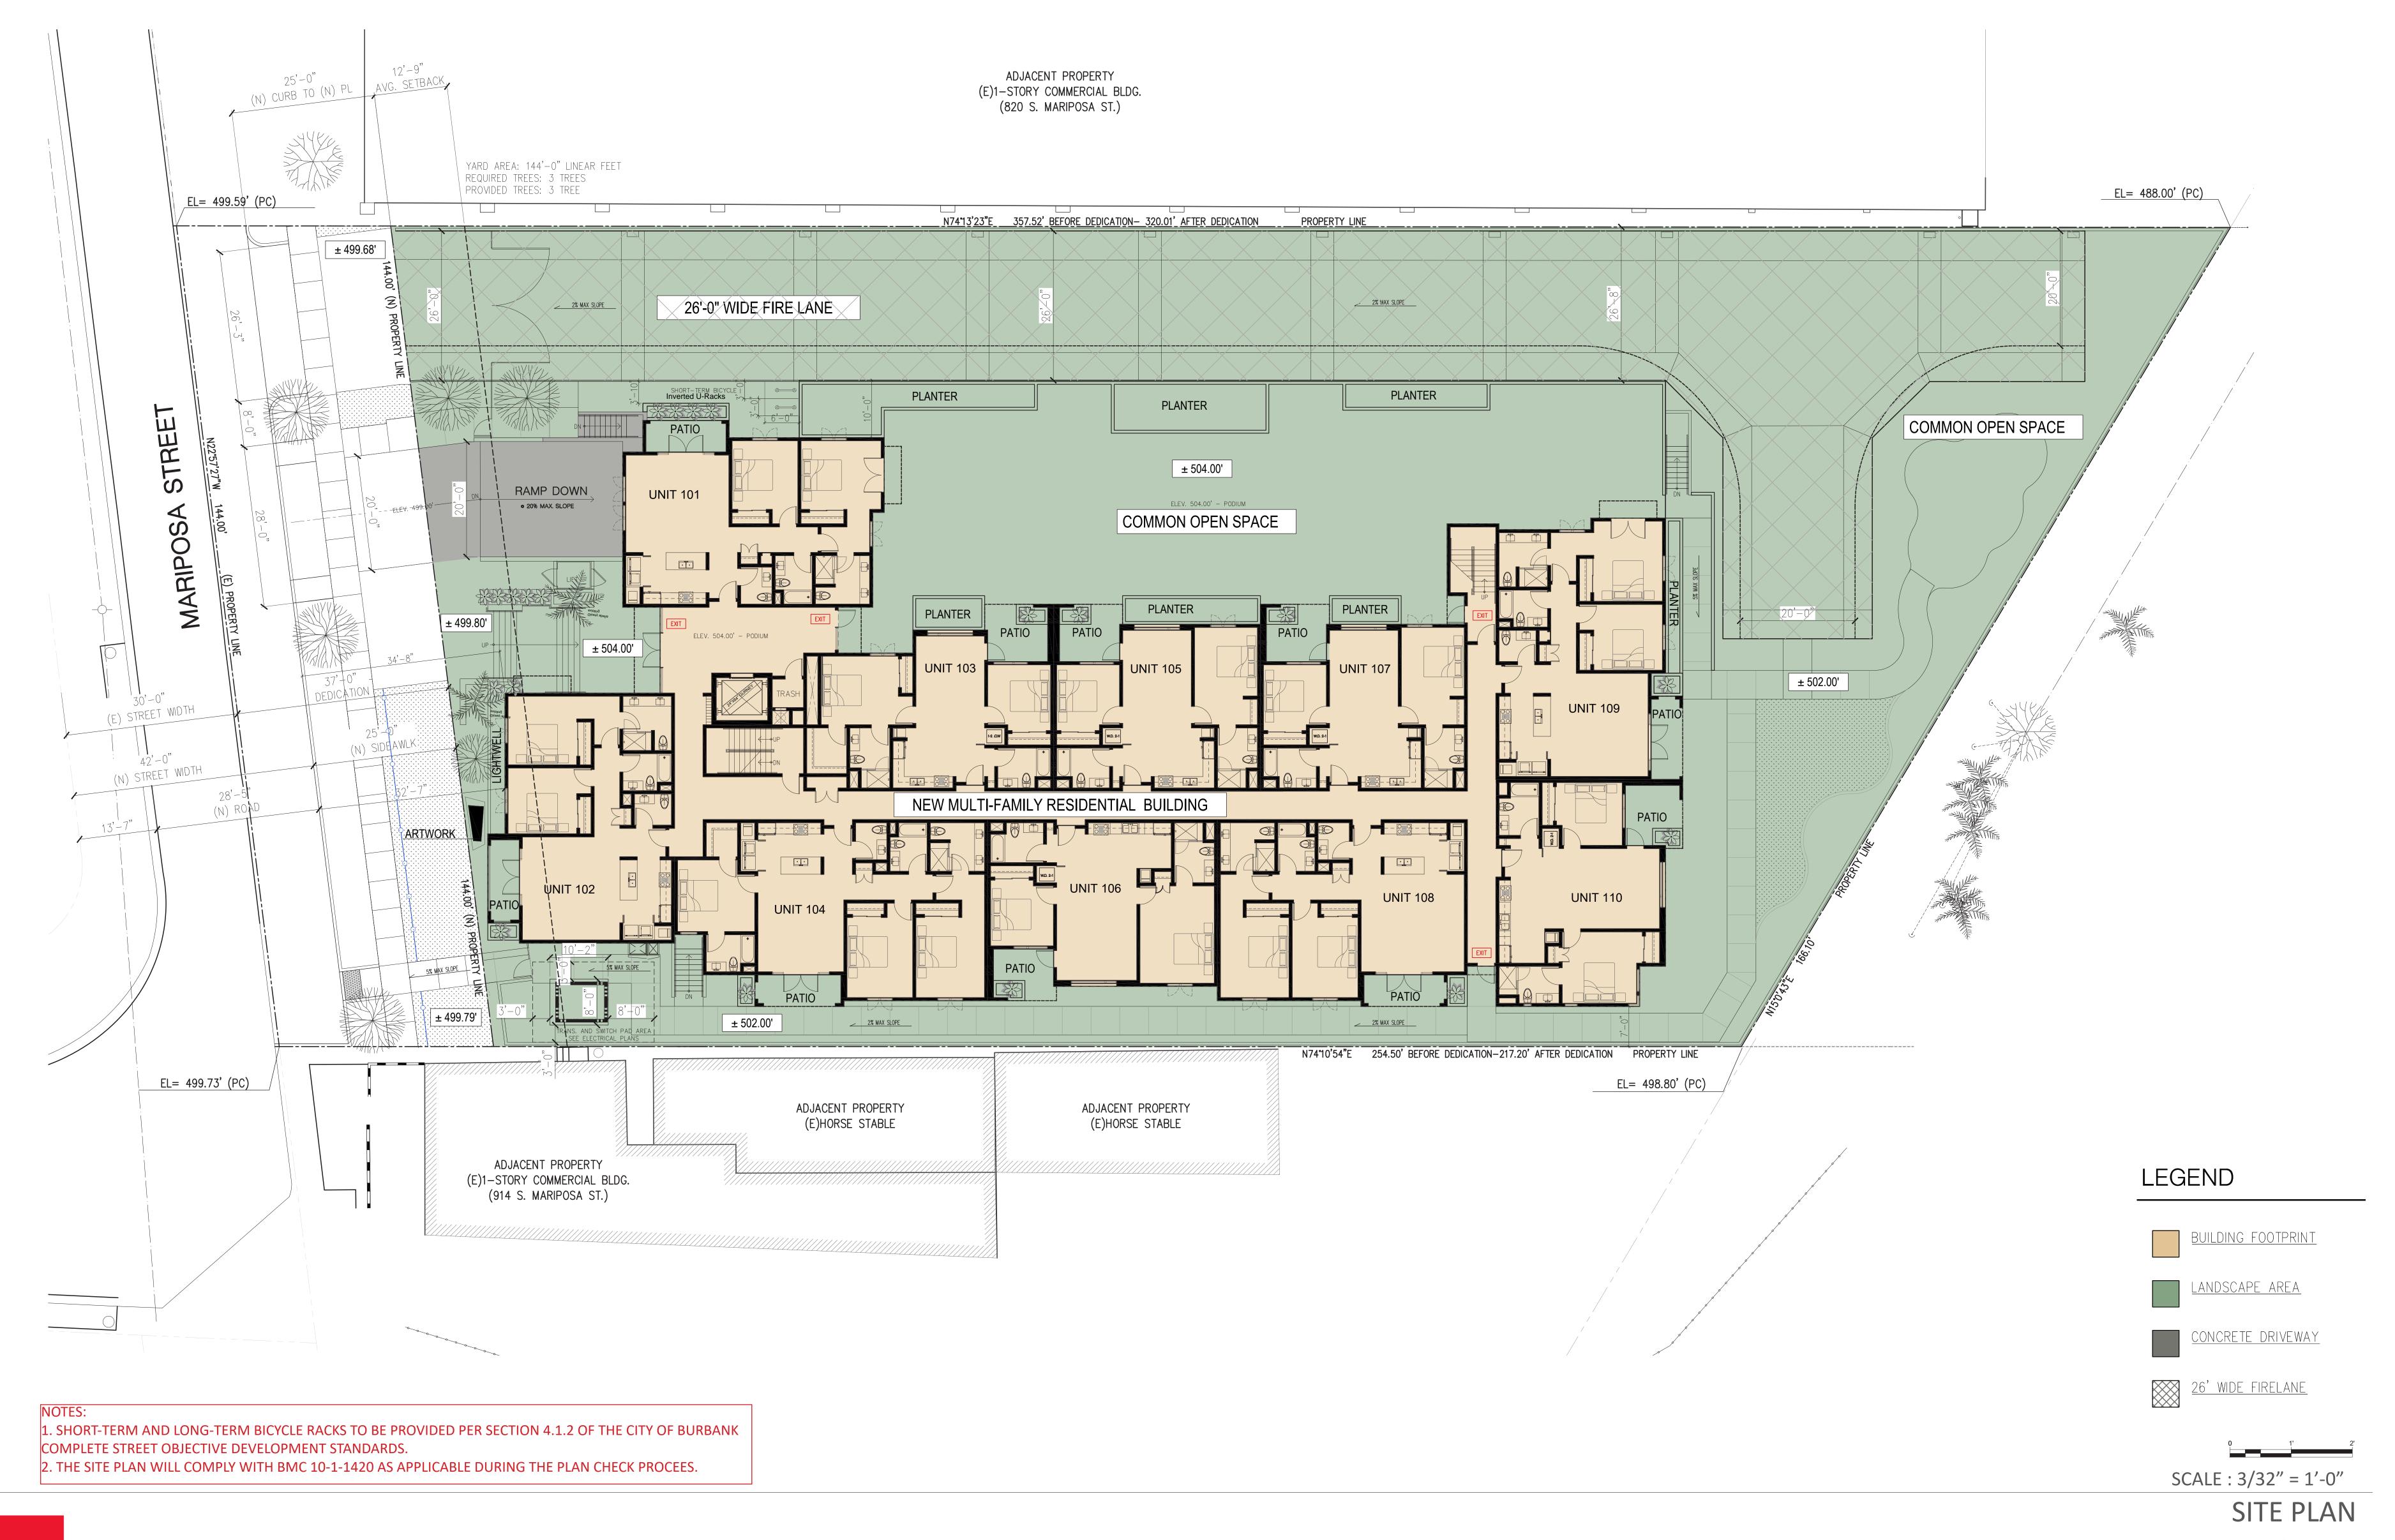

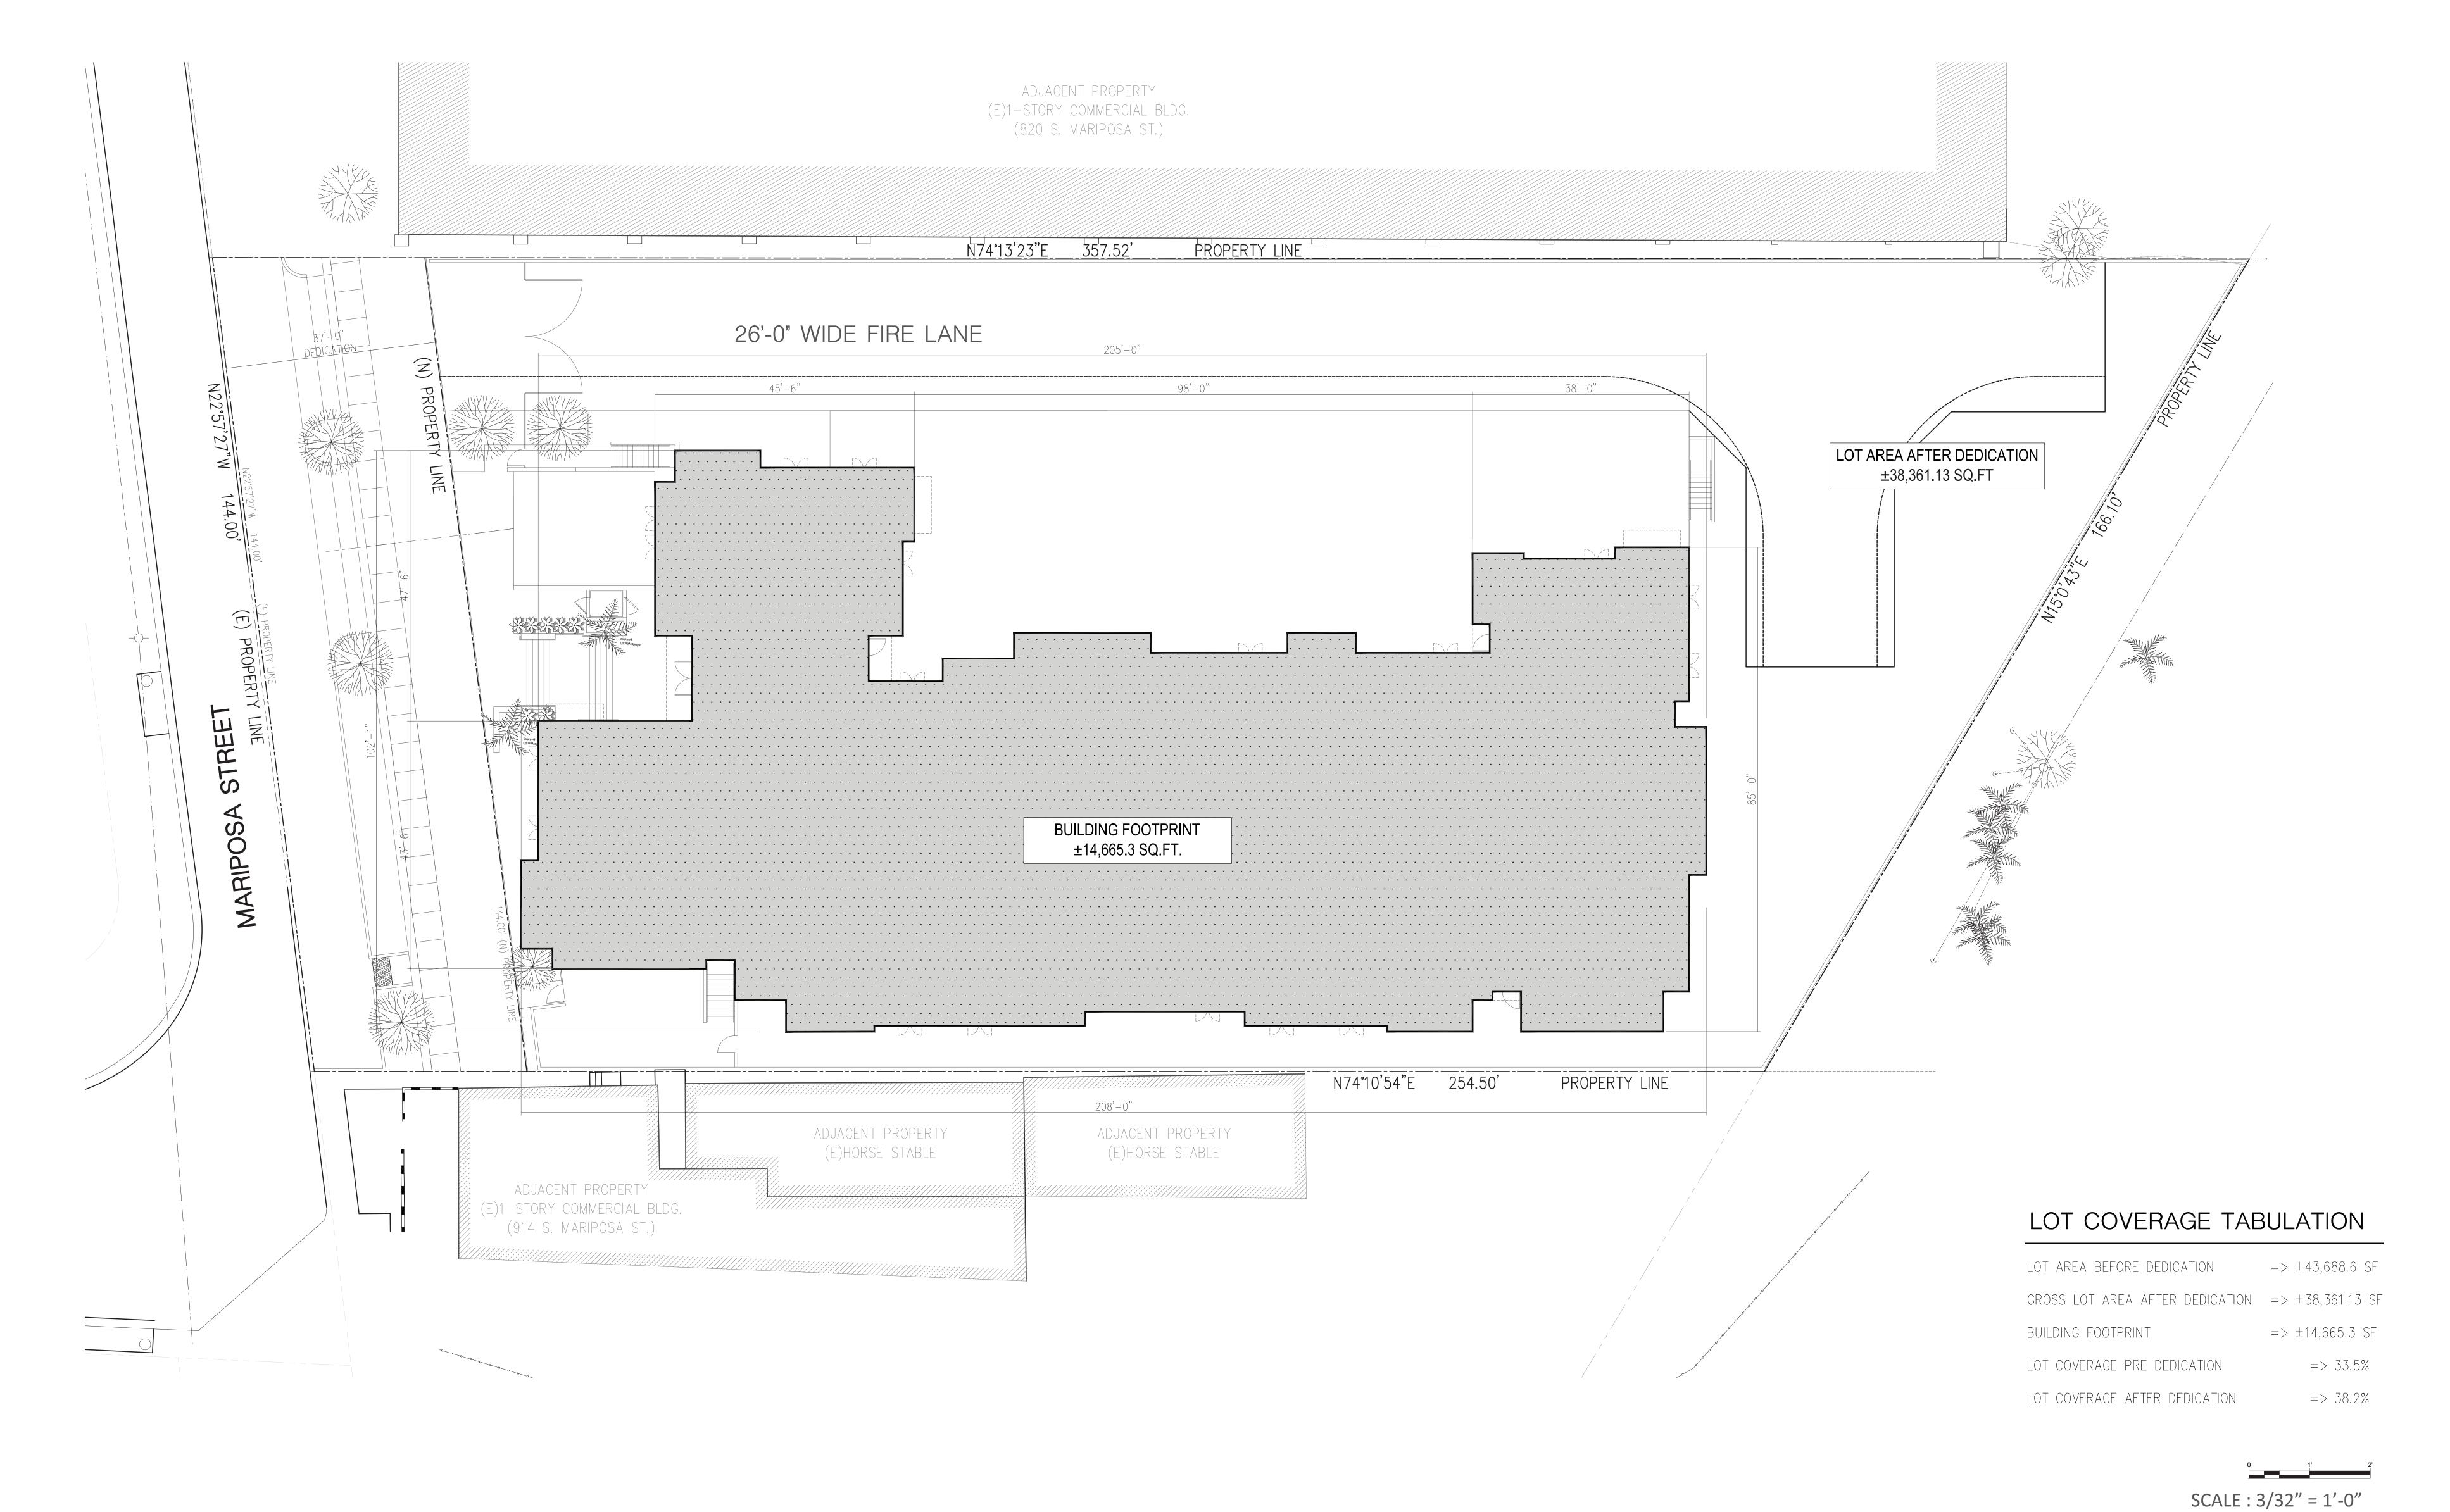

DIAGRAMS: LOT COVERAGE



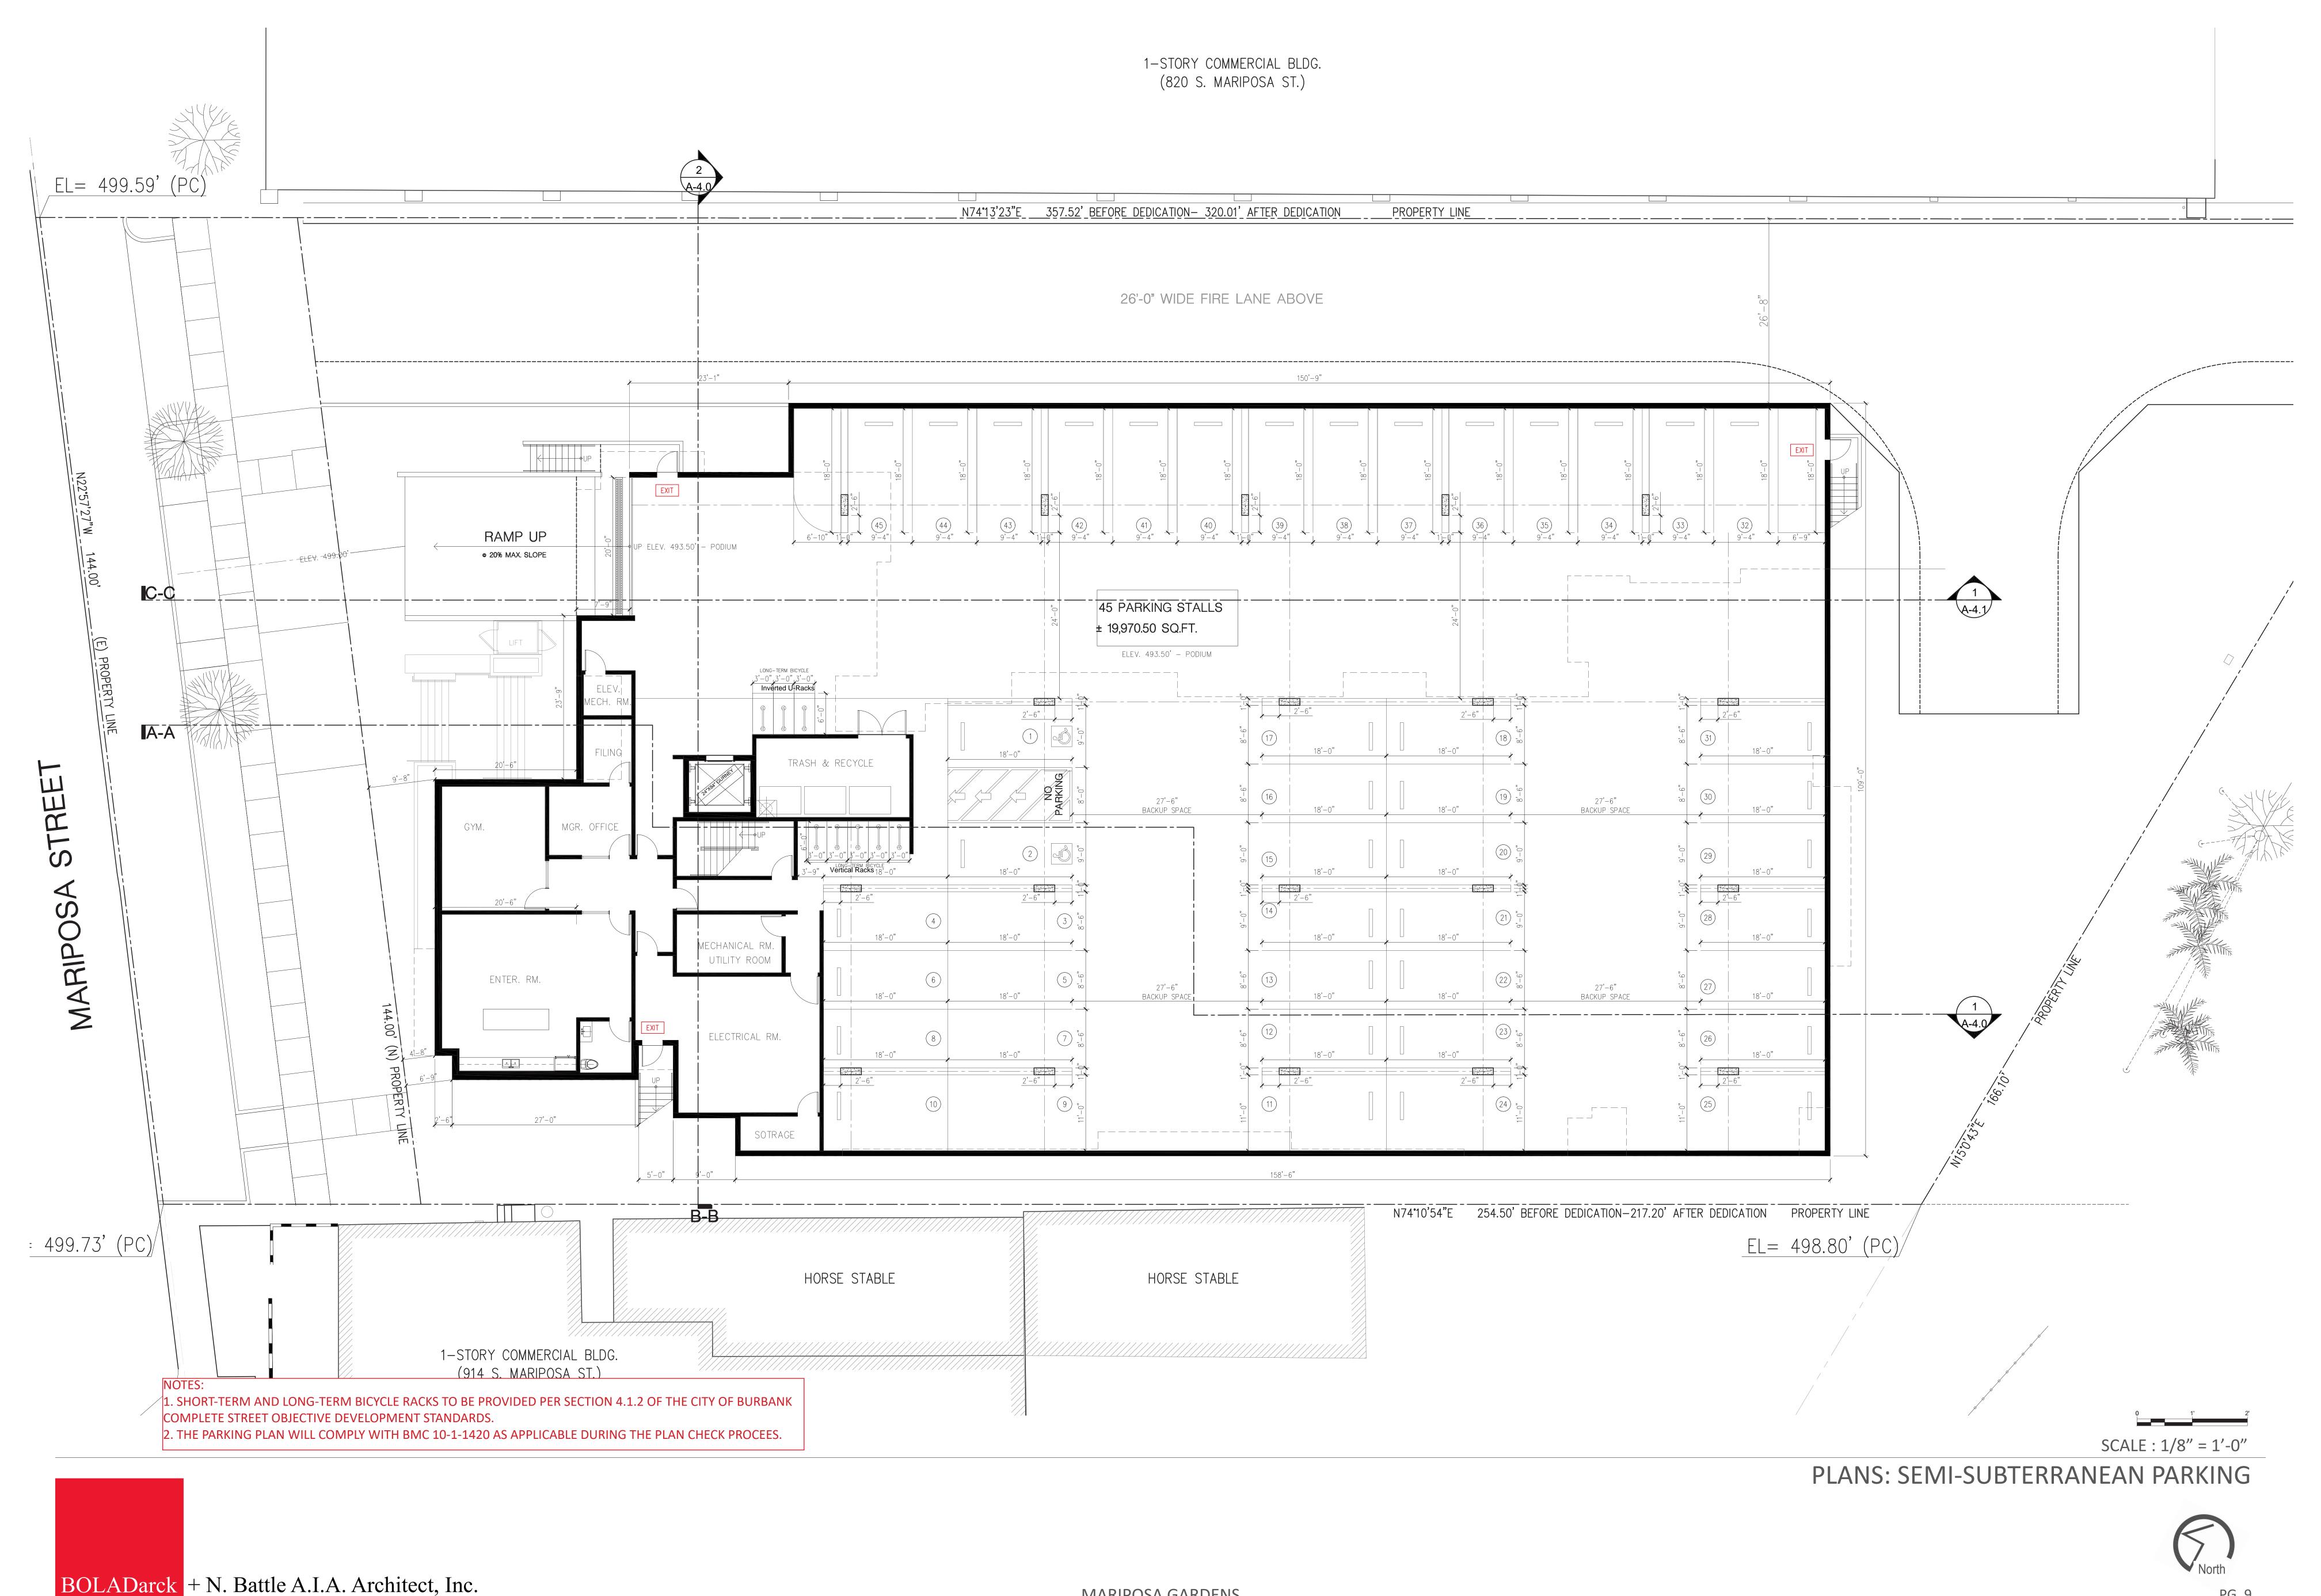

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North




PLANS: SECOND FLOOR




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North



NOTE: MECHANICAL EQUIPMENT TO BE SCREENED ACCORDING TO THE BURBANK MUNICIPAL CODE.

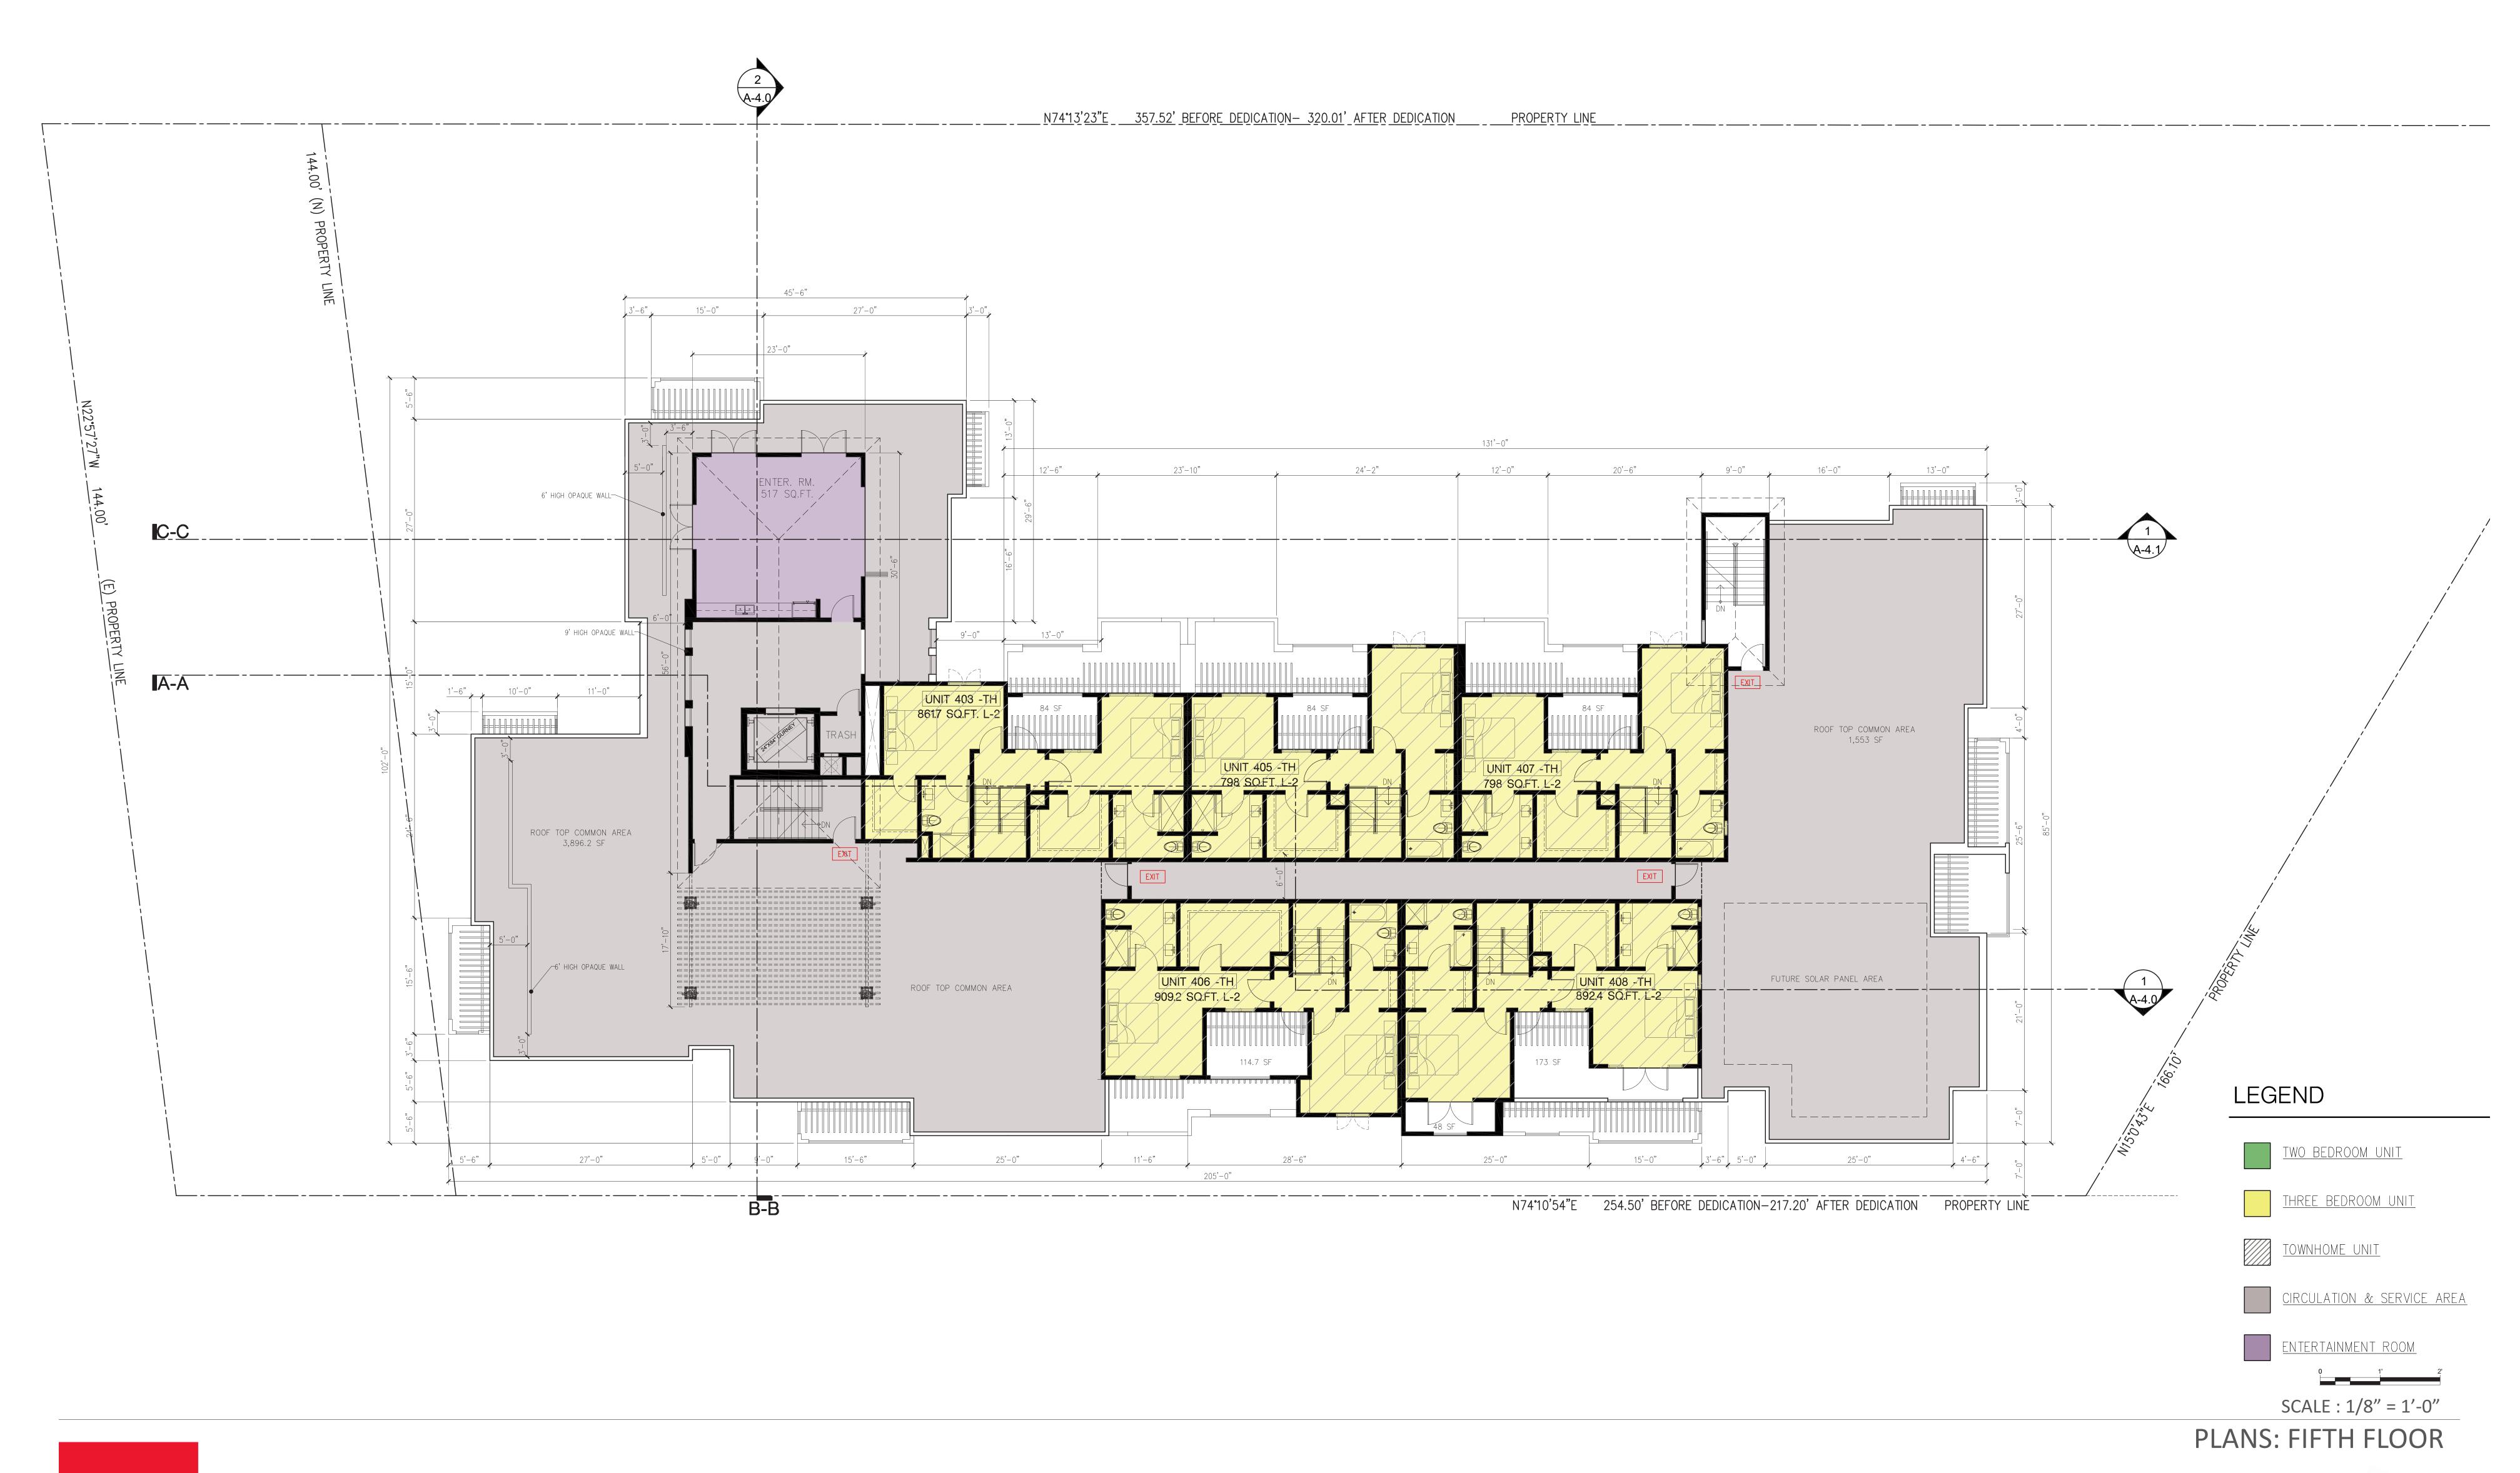SCALE : 1/8" = 1'-0"


PLANS: ROOF LEVEL

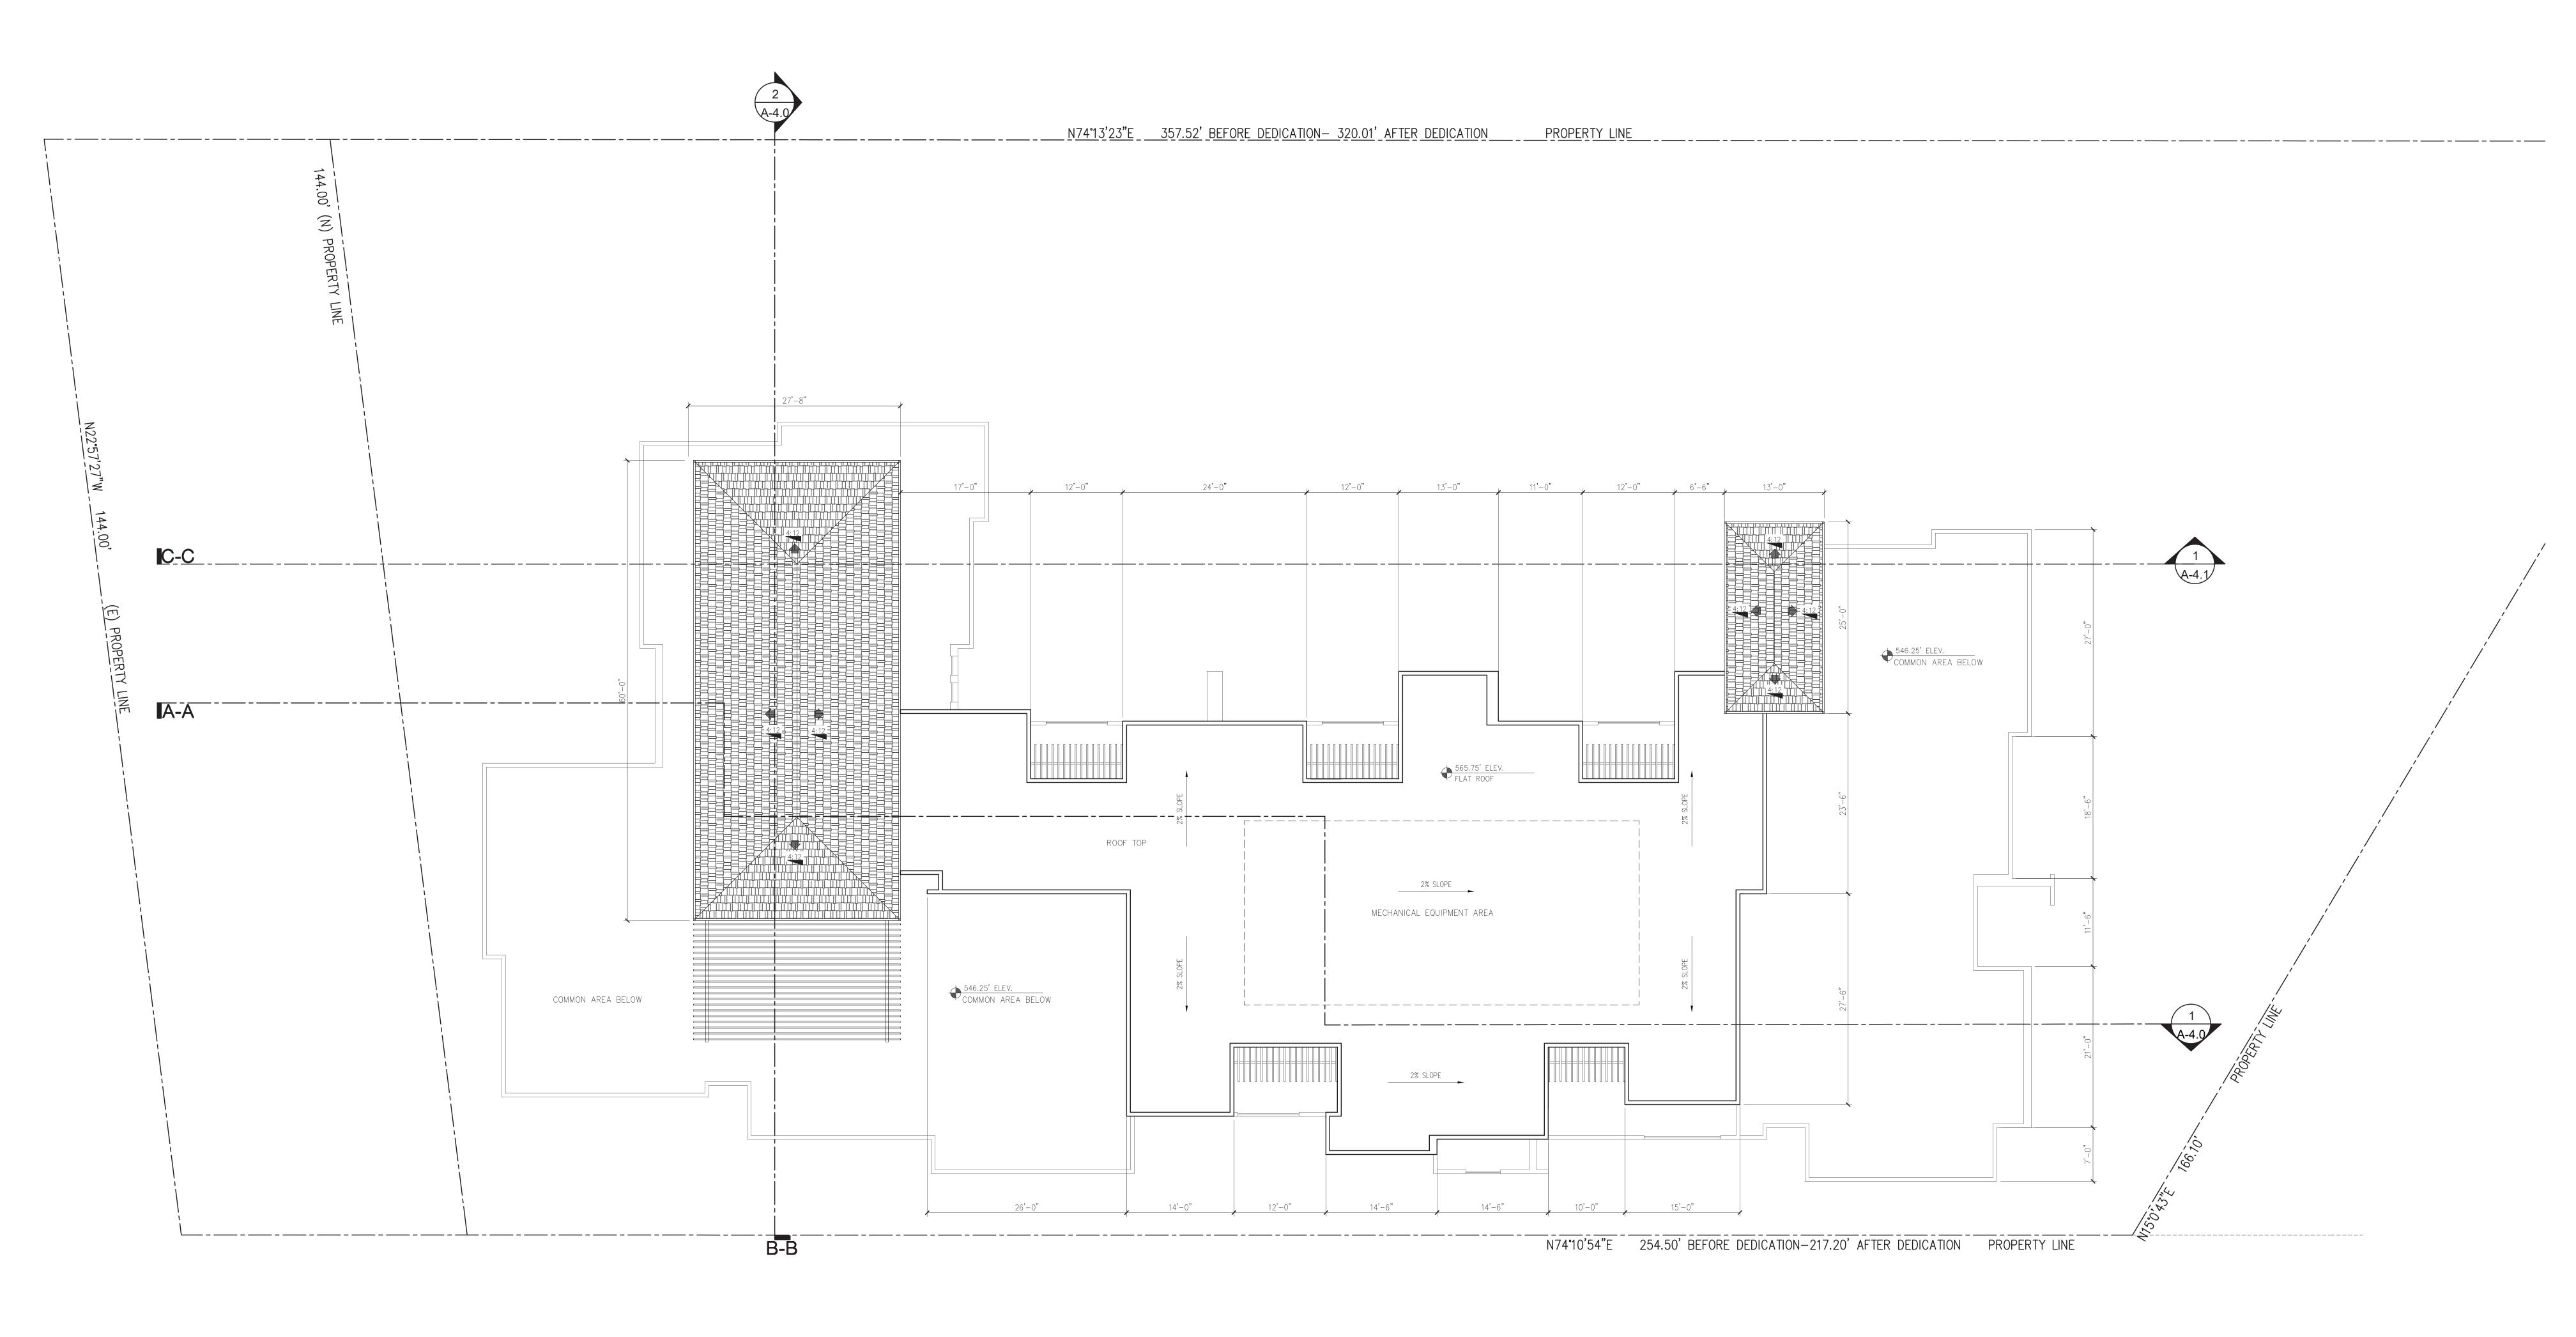

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WEST ELEVATION



EAST ELEVATION

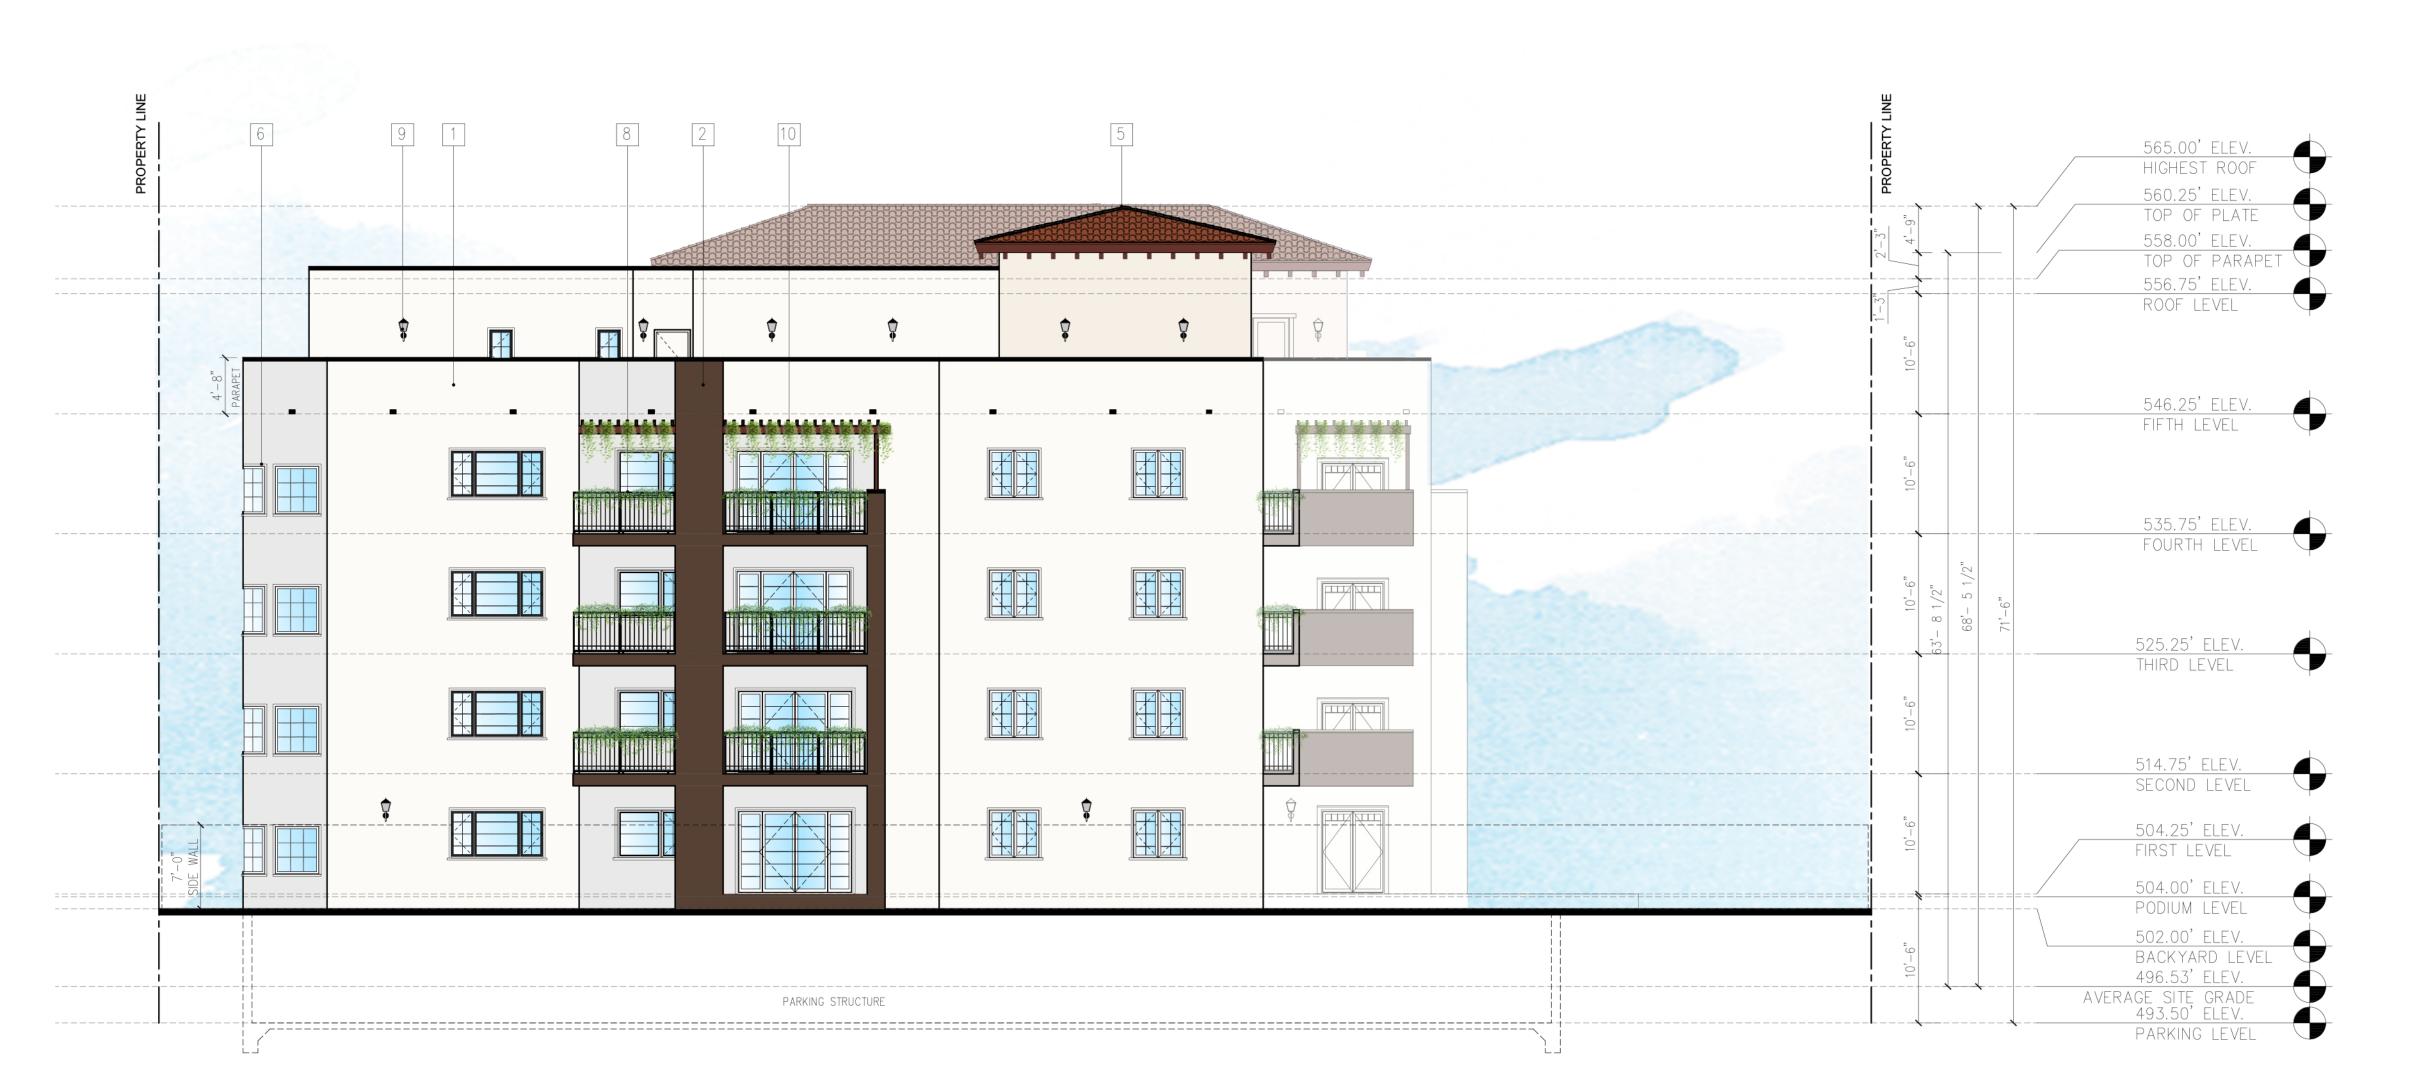NOTE: THE BALCONES WILL COMPLY WITH BMC 10-1-624T AS APPLICABLE DURING THE PLAN CHECK PROCESS.

SCALE: 1/8" = 1'-0"

MATERIAL BOARD:

STUCCO BUILDING COLOR

BENJAMIN MOORE PAINT

STUCCO BUILDING COLOR

BENJAMIN MOORE PAINT

0.75 LB/ PIECE OR EQUAL

PARKING GARAGE GATE: MC NICHOLS CO. GRILL GATE

SUPERIOR CLAY ROOFING TILE CORONA TAPERED MISSION

SIERRA PACIFIC WINDOWS ALUM.

COLORS: CUSTOM BLENDS

CLAD WOOD FRAME ALPINE

METALLIC FINISH & PATIO

7 CUSTOM WROUGHT IRON GATE/FENCE

8 CUSTOM WROUGHT IRON RAILING

HINKLEY LIGHTING 1670-LL EDGEWATER OUTDOOR LIGHTING

OR EQUAL

10 CUSTOM WOOD TRELLIS

DOORS OR EQUAL

OR EQUAL PRODUCT

OR EQUAL

PRENTIS CREAM CW-100 OR EQUAL

TARPLEY BROWN CW-170 OR EQUAL

SMOOTH FINISH

SMOOTH FINISH

STONE CLADDING 5/8" THICKNESS

ELEVATIONS

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SOUTH ELEVATION




NORTH ELEVATION


NOTE: THE BALCONES WILL COMPLY WITH BMC 10-1-624T AS APPLICABLE DURING THE PLAN CHECK PROCESS.

SCALE : 1/8" = 1'-0"

ELEVATIONS

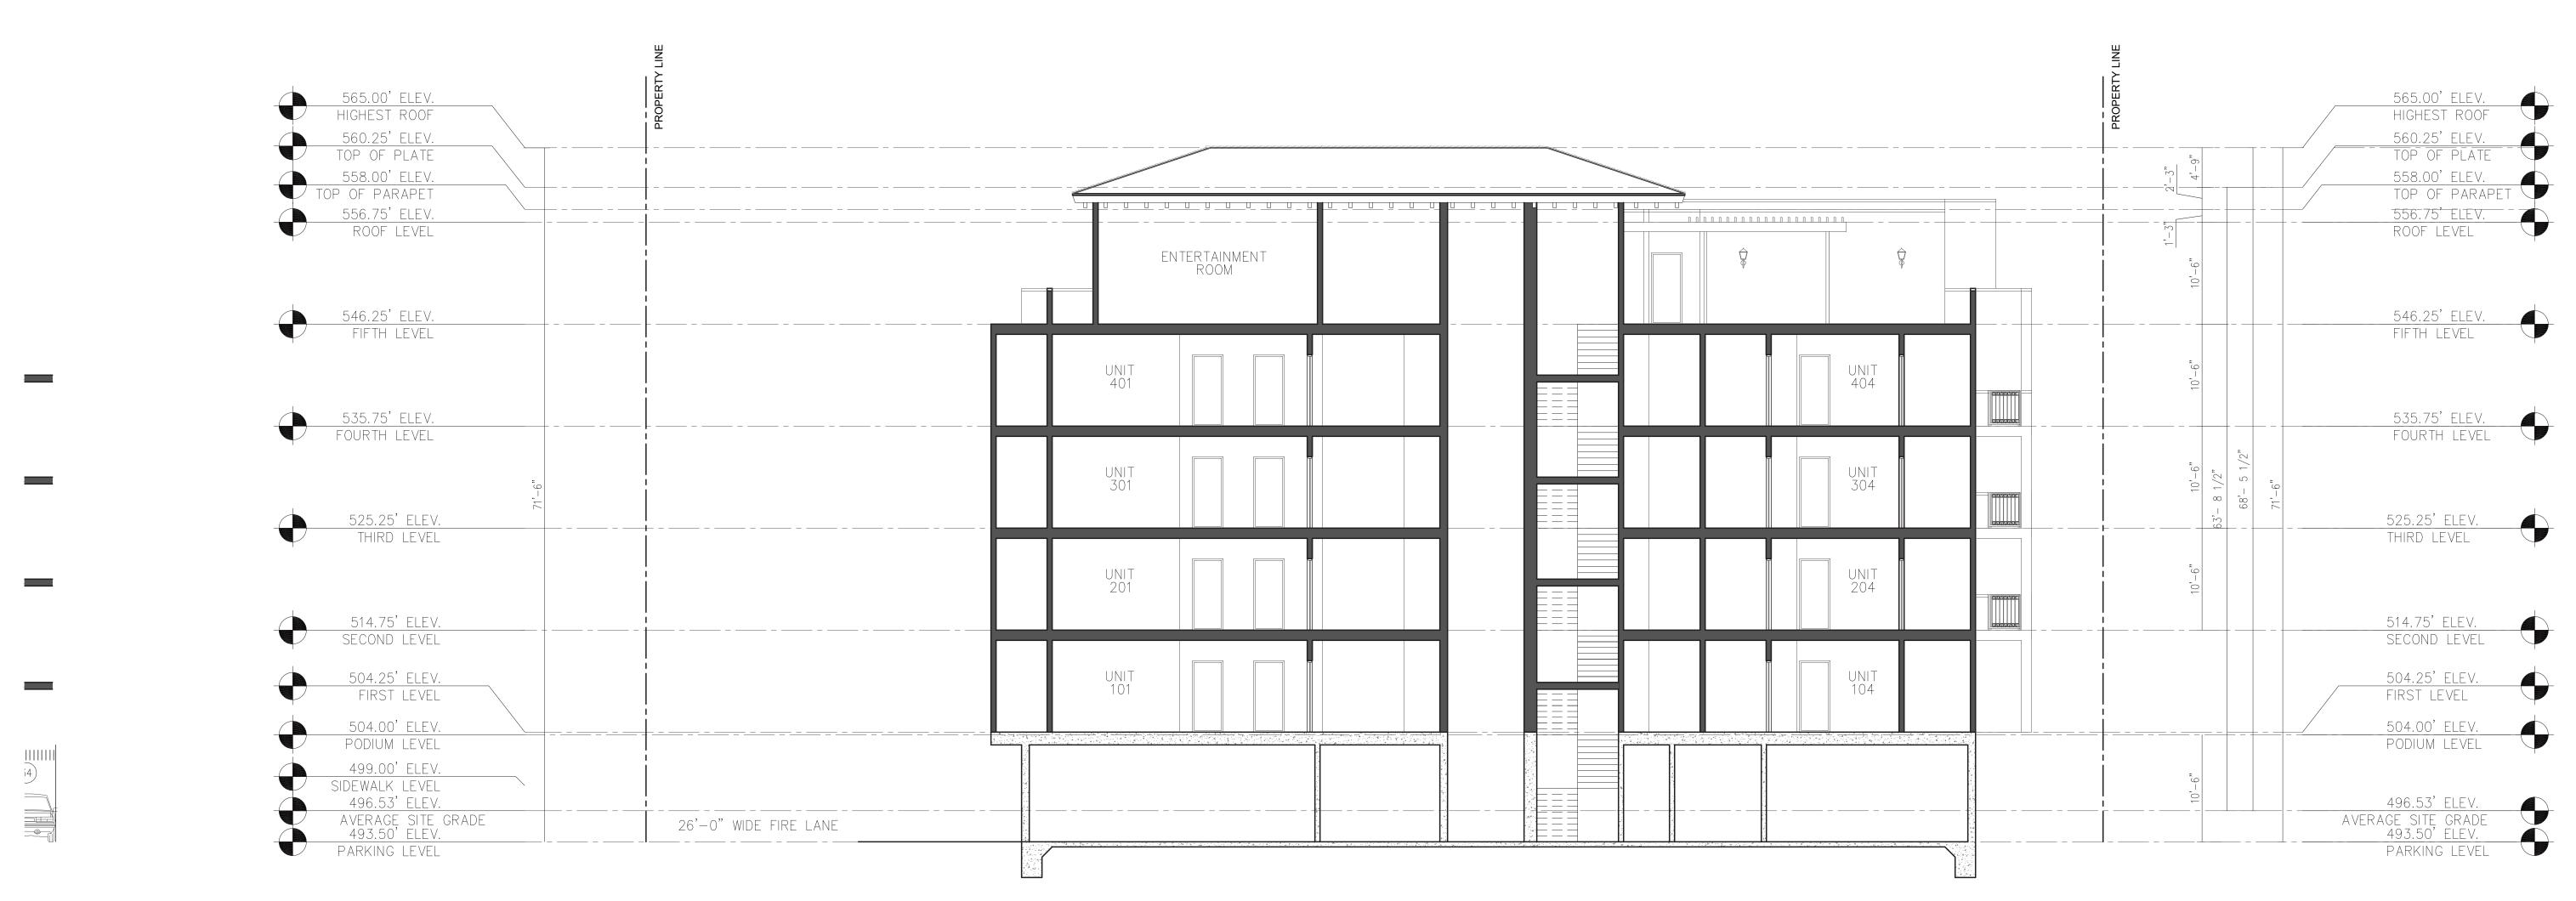


SECTION B-B

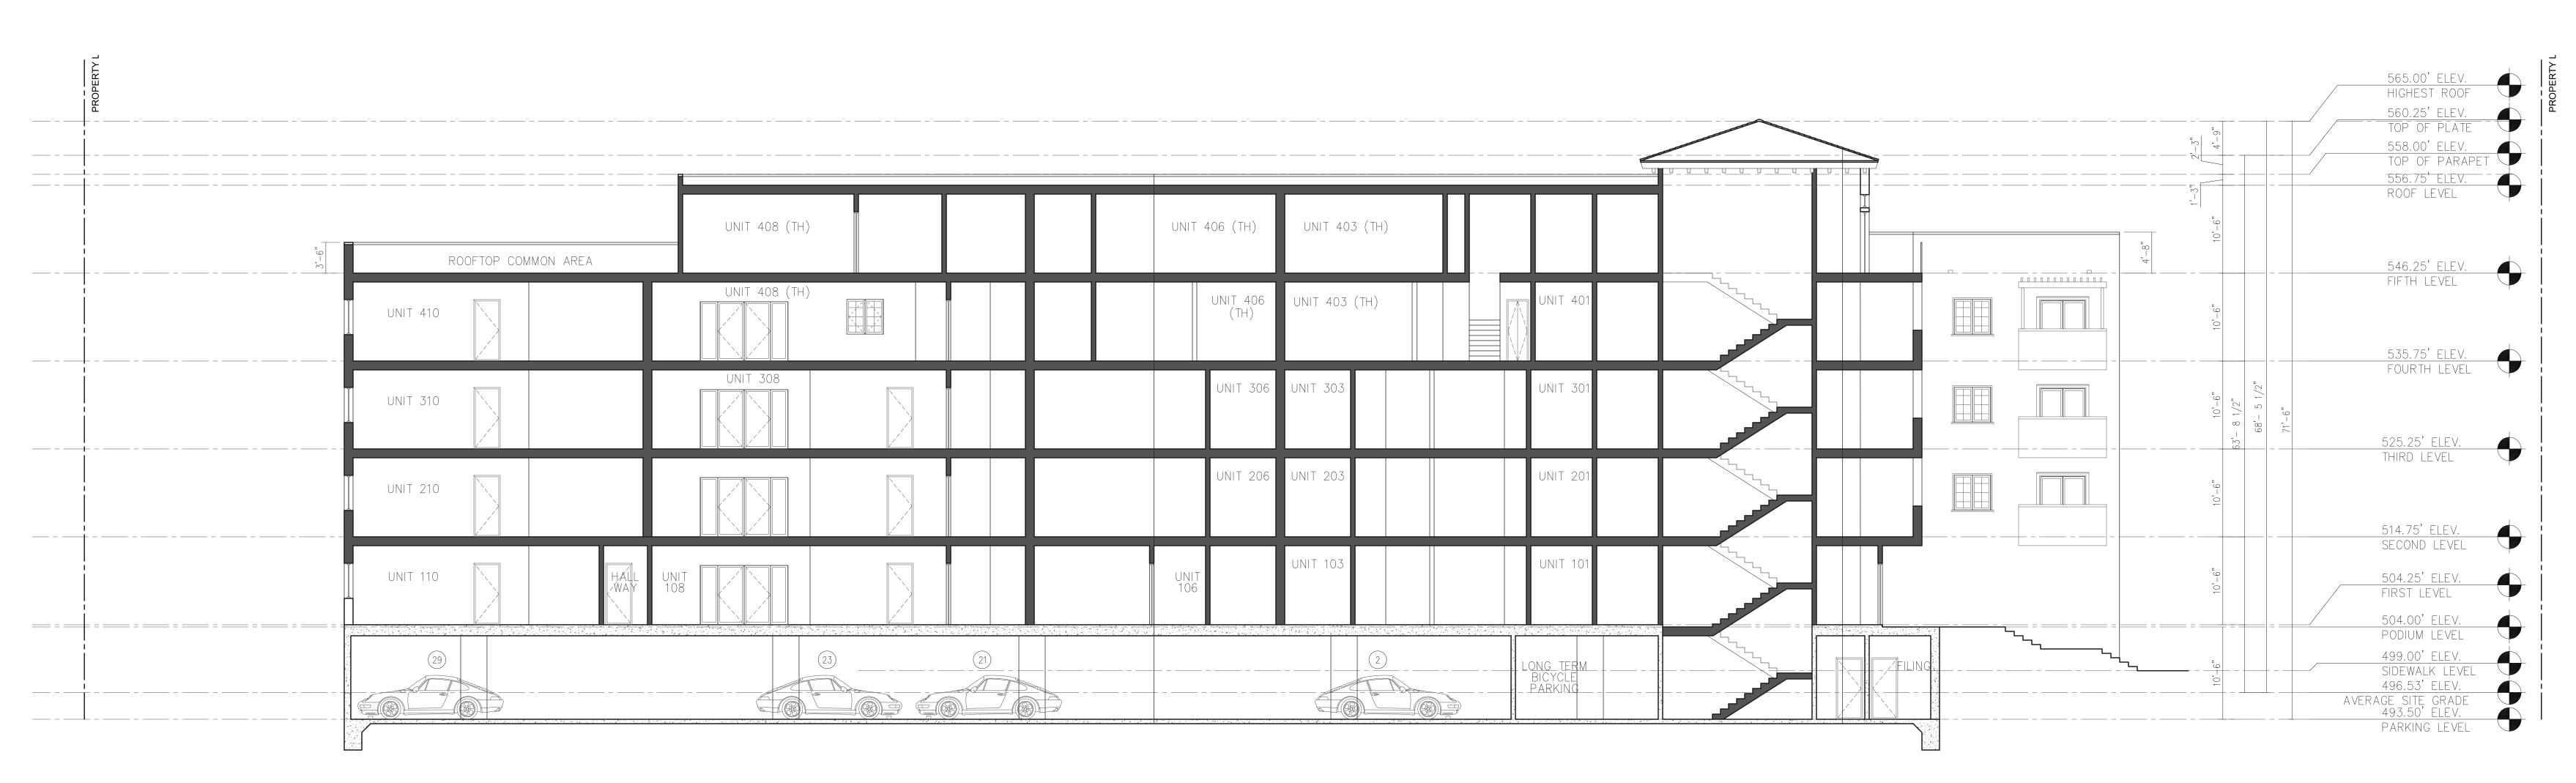

SECTION A-A

SCALE : 1/8" = 1'-0"

SECTIONS

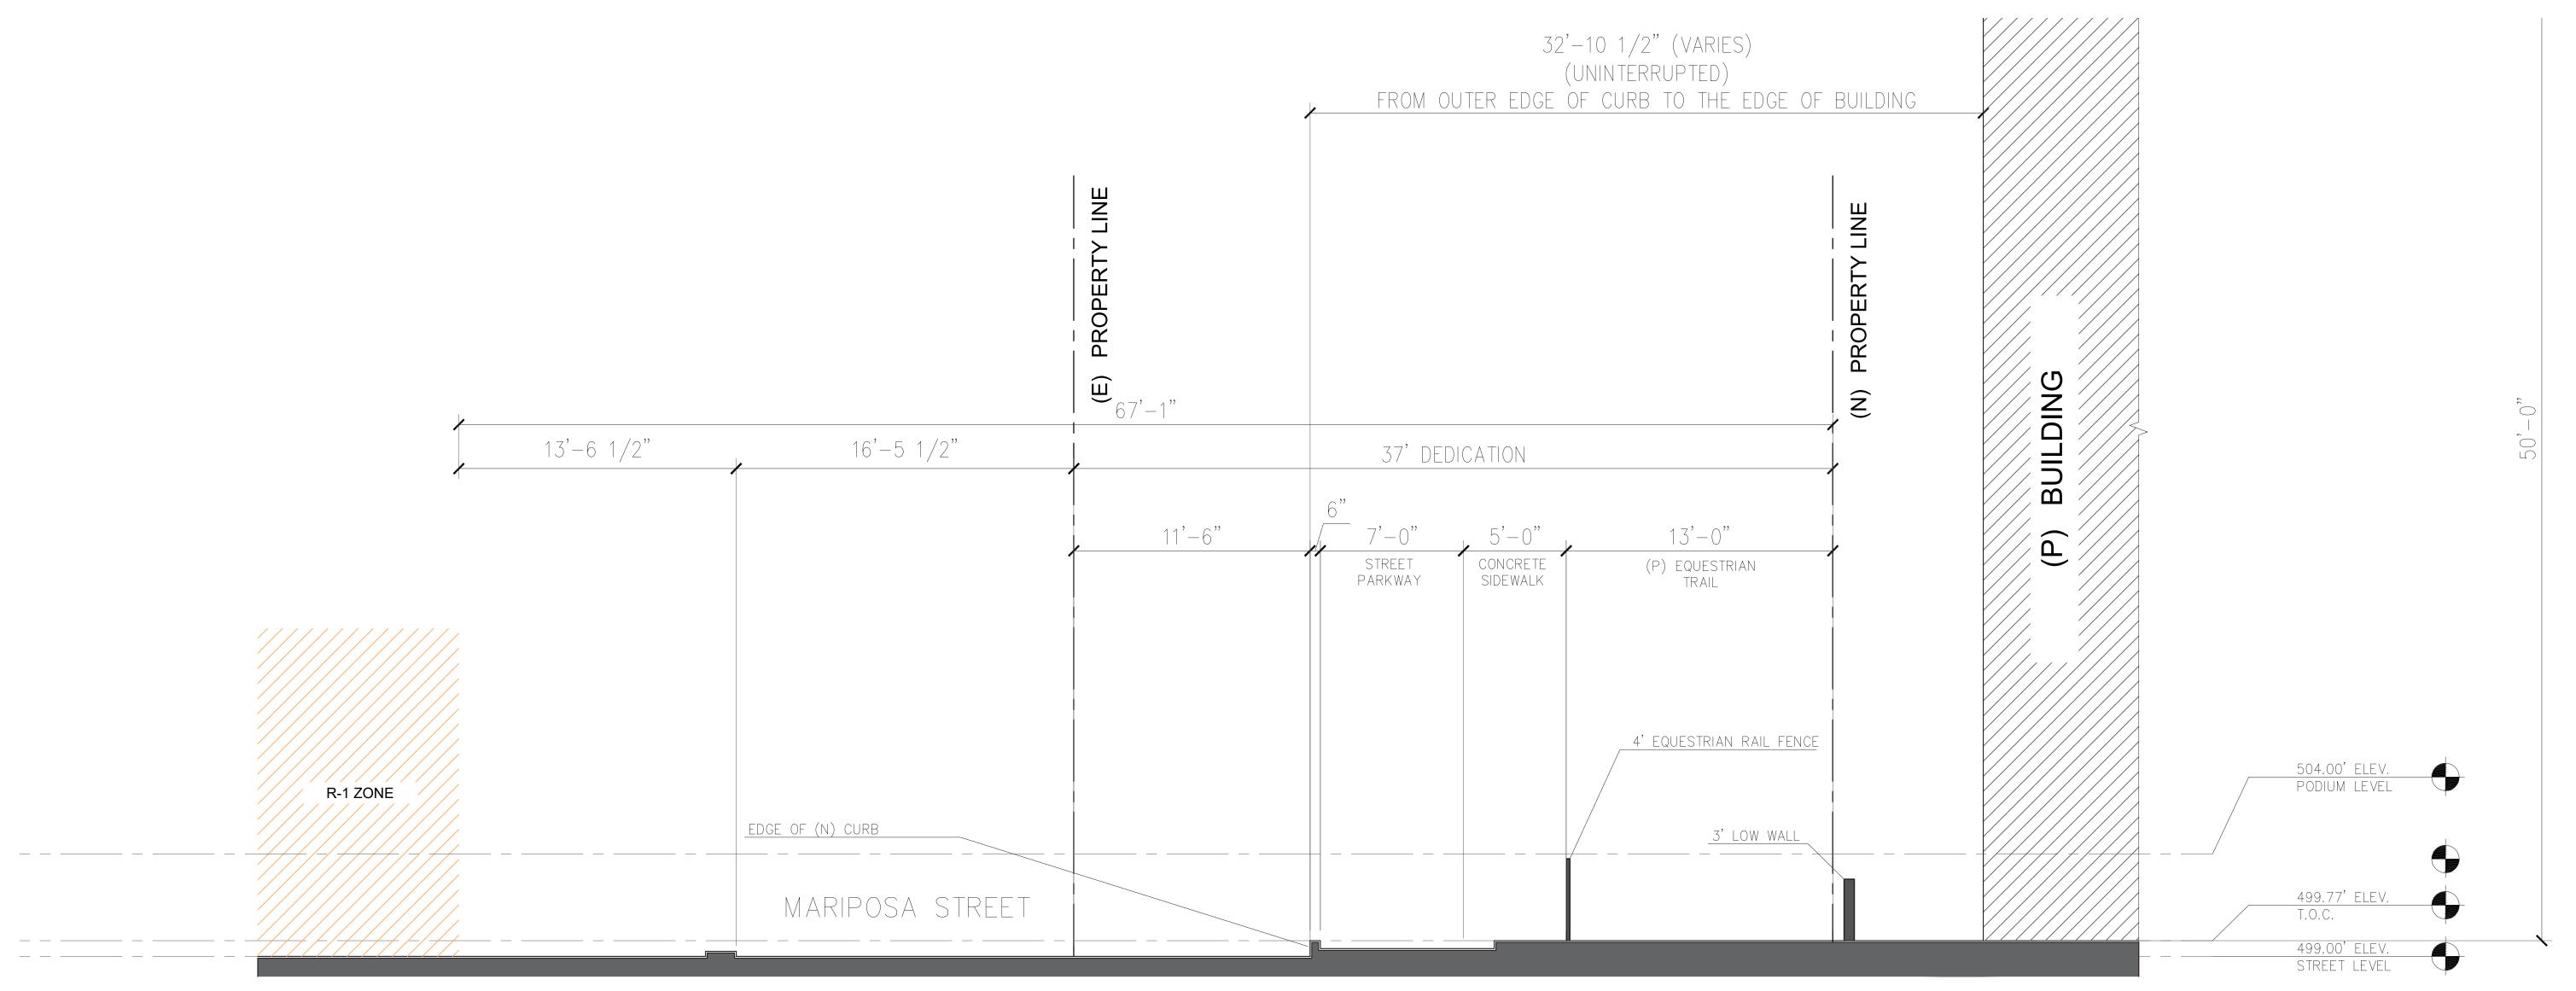


STREET CROSS-SECTION



SECTION C-C

SCALE: 1/8" = 1'-0"

SECTIONS

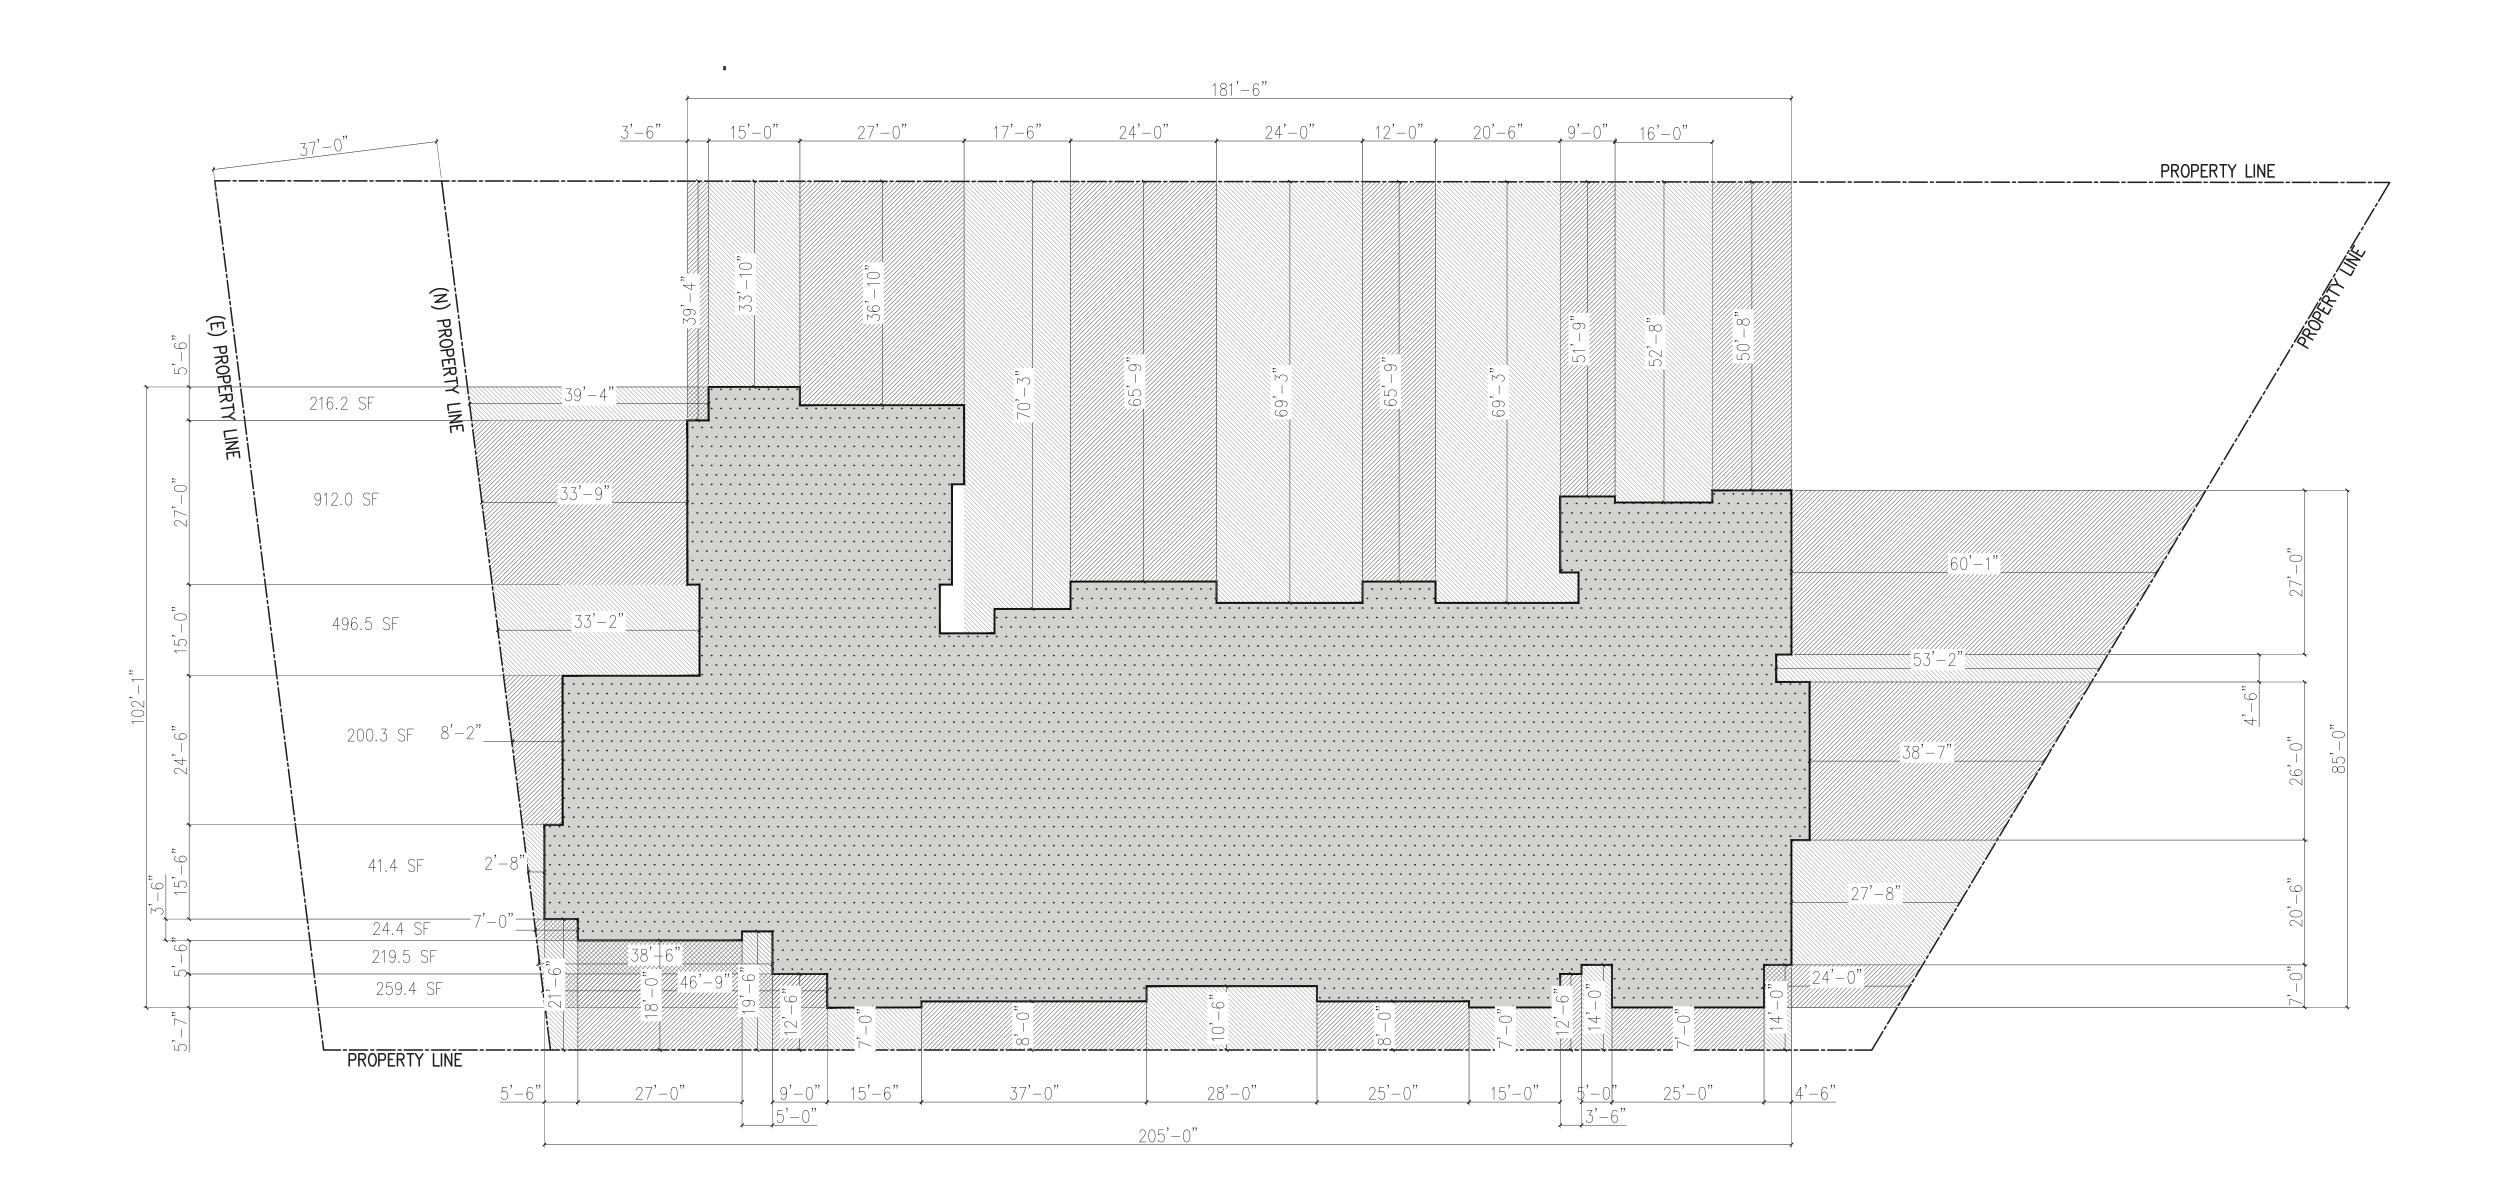


AVERAGE FRONT SETBACK CALCULATIONS:

MIN AVG = 63'-8 1/2" BLDG HGT X 20% = 12'-9" PROVIDED AVERAGE ON 1ST FLOOR= 23'-2"

TOTAL FRONTAGE= 102'-1"

(216.2 SF) + (912 SF) + (496.5 SF) + (200.3 SF) + (41.4 SF) + (24.4 SF) + (219.5 SF) + (259.4 SF) = 2,437.2 SF / 102'-1" = 23'-2"

SECOND FLOOR SETBACK DIAGRAM

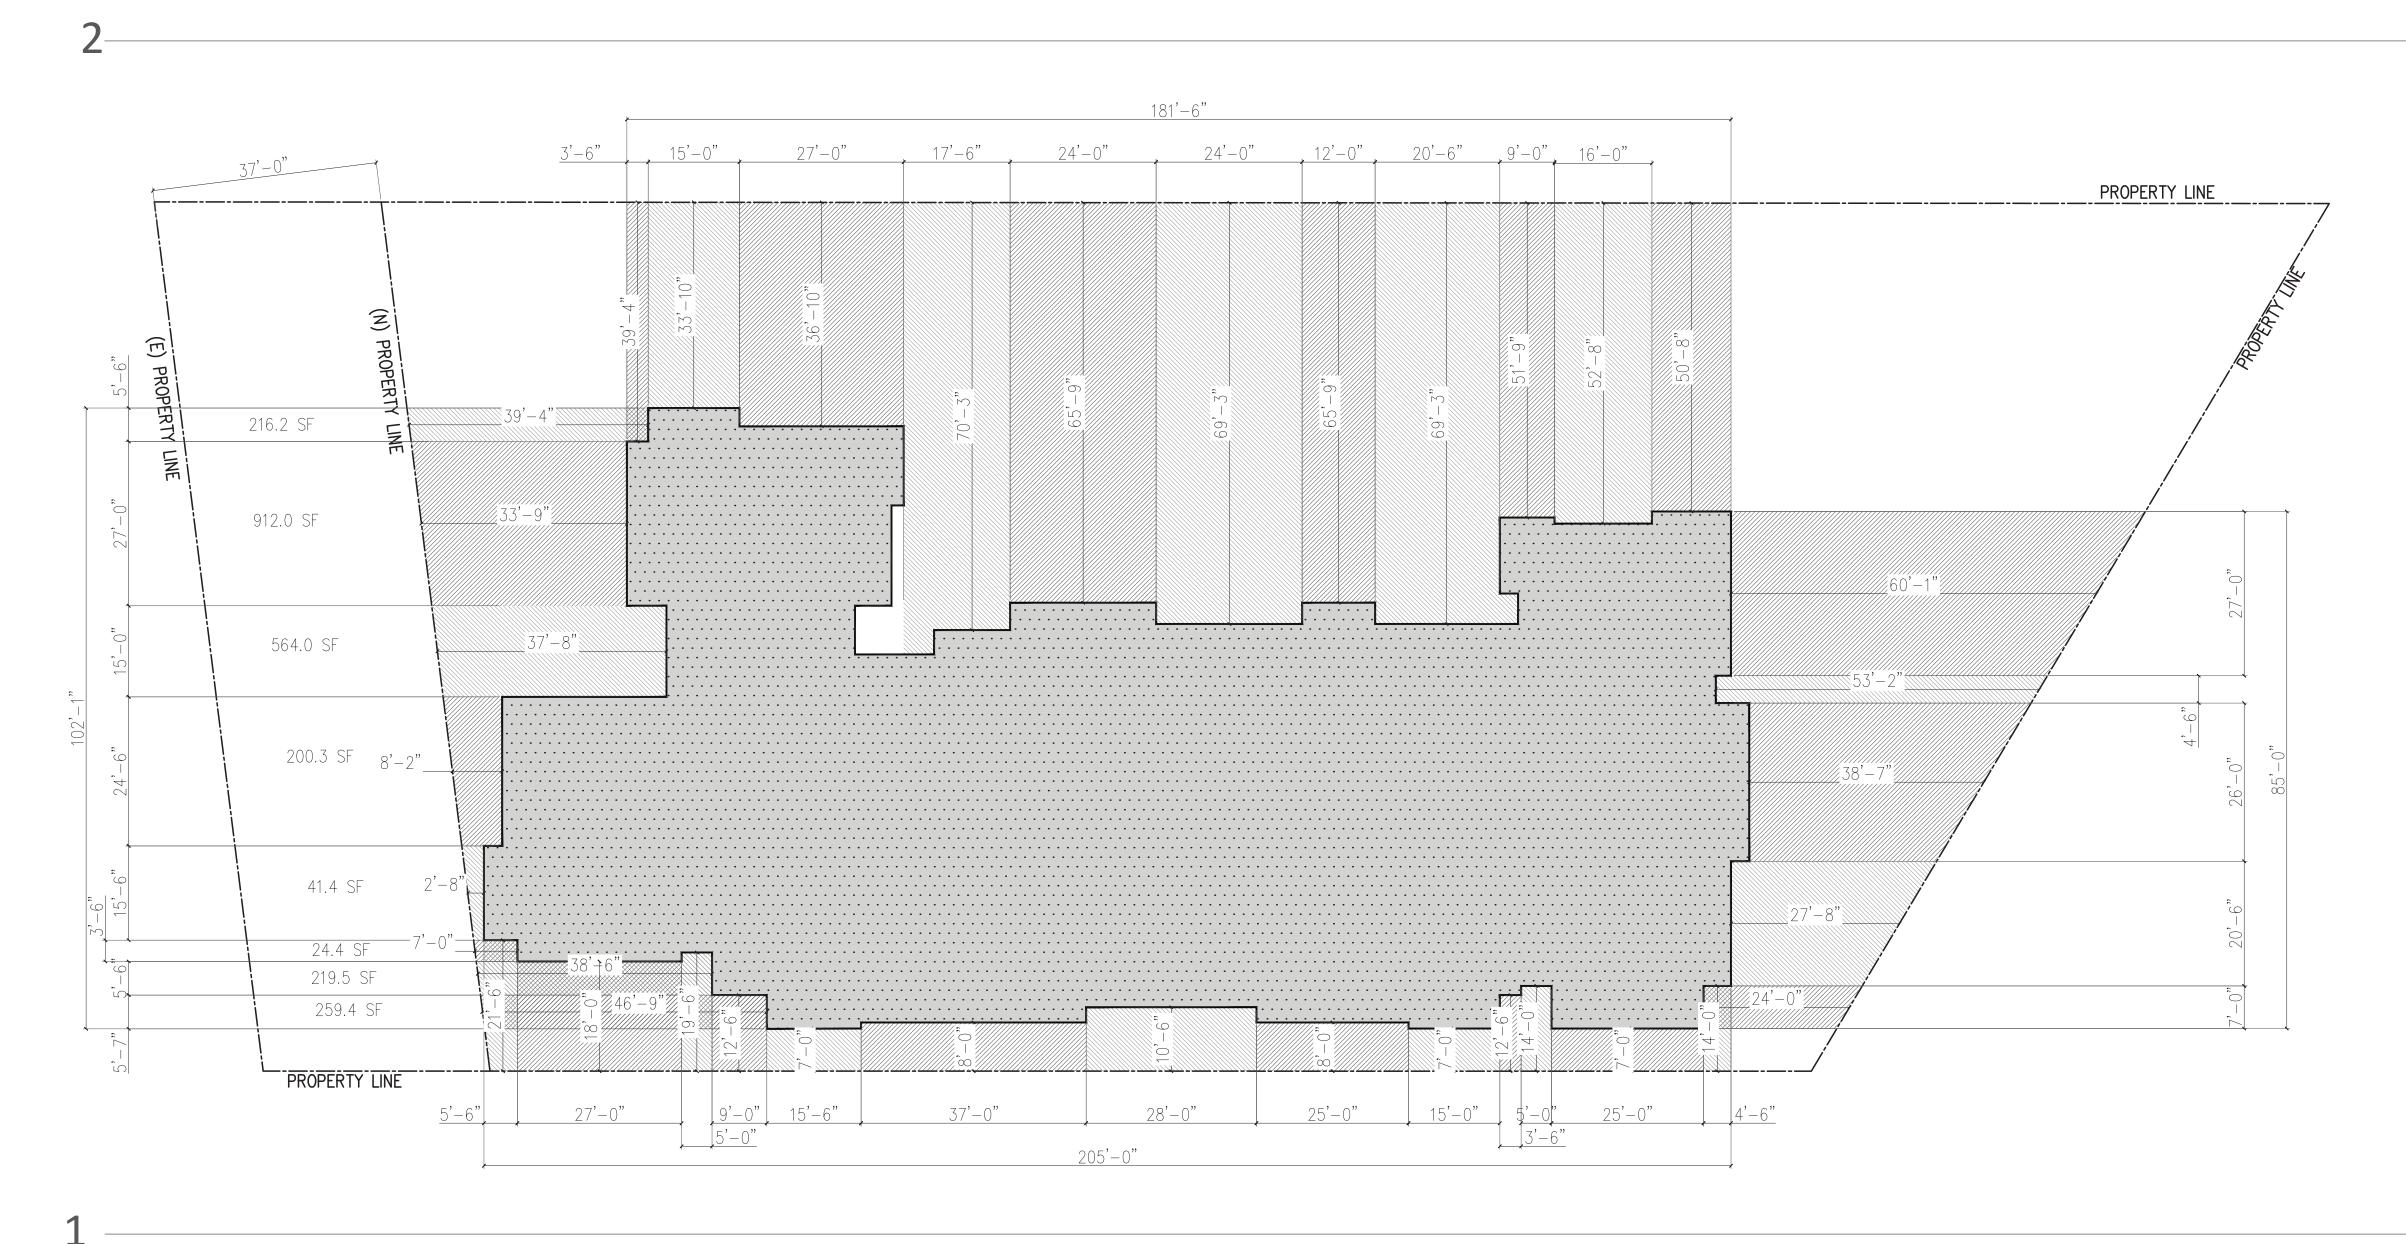

AVERAGE FRONT SETBACK CALCULATIONS:

MIN AVG = 63'-8 1/2" BLDG HGT X 20% = 12'-9" PROVIDED AVERAGE ON 1ST FLOOR= 23'-10 1/2"

TOTAL FRONTAGE= 102'-1"

(216.2 SF) + (912 SF) + (564 SF) + (200.3 SF) + (41.4 SF) + (24.4 SF) + (219.5 SF) + (259.4 SF) = 2,437.2 SF / 102'-1" = 23'-10 1/2"

FIRST FLOOR SETBACK DIAGRAM

SCALE: 1/16" = 1'-0"

DIAGRAMS: SETBACKS






AVERAGE FRONT SETBACK CALCULATIONS:

MIN AVG = 63'-8 1/2" BLDG HGT X 20% = 12'-9" => 12'-9" + 5'-0" = 17'-9" PROVIDED AVERAGE ON 4TH FLOOR = 23'-2"

TOTAL FRONTAGE= 102'-1"

(216.2 SF) + (912 SF) + (496.5 SF) + (200.3 SF) + (41.4 SF) + (24.4 SF) + (219.5 SF) + (259.4 SF) = 2,437.2 SF / 102'-1" = 23'-2"

FOURTH FLOOR SETBACK DIAGRAM

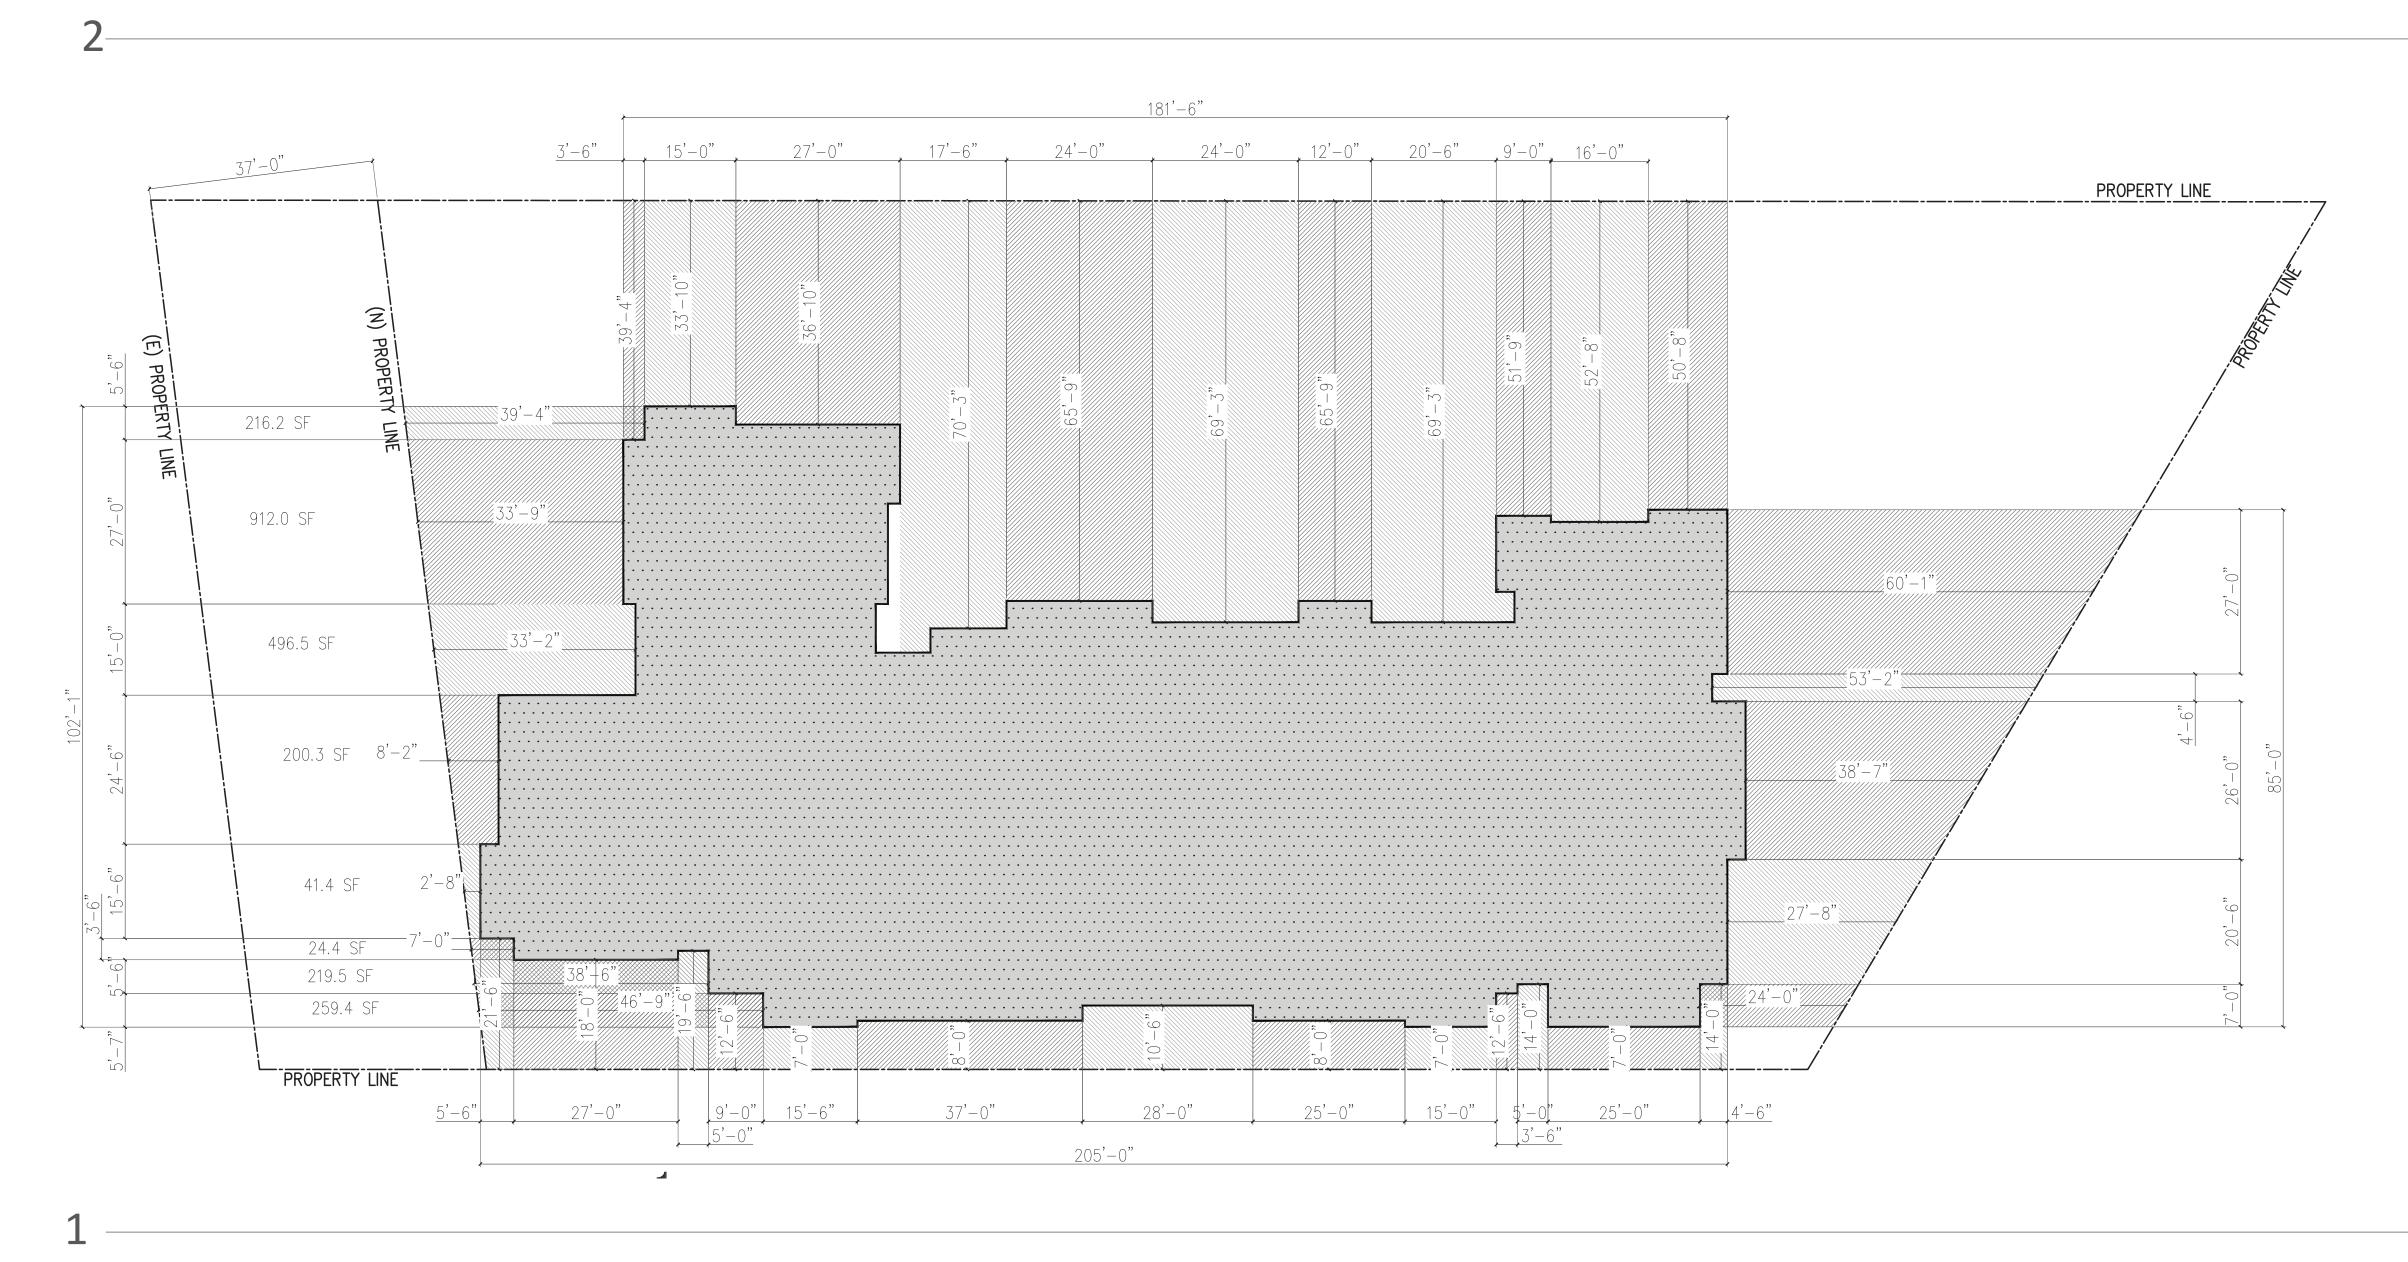

AVERAGE FRONT SETBACK CALCULATIONS:

MIN AVG = 63'-8 1/2" BLDG HGT X 20% = 12'-9" PROVIDED AVERAGE ON 1ST FLOOR= 23'-2"

TOTAL FRONTAGE= 102'-1"


(216.2 SF) + (912 SF) + (496.5 SF) + (200.3 SF) + (41.4 SF) + (24.4 SF) + (219.5 SF) + (259.4 SF) = 2,437.2 SF / 102'-1" = 23'-2"

THIRD FLOOR SETBACK DIAGRAM

SCALE: 1/16" = 1'-0"


DIAGRAMS: SETBACKS



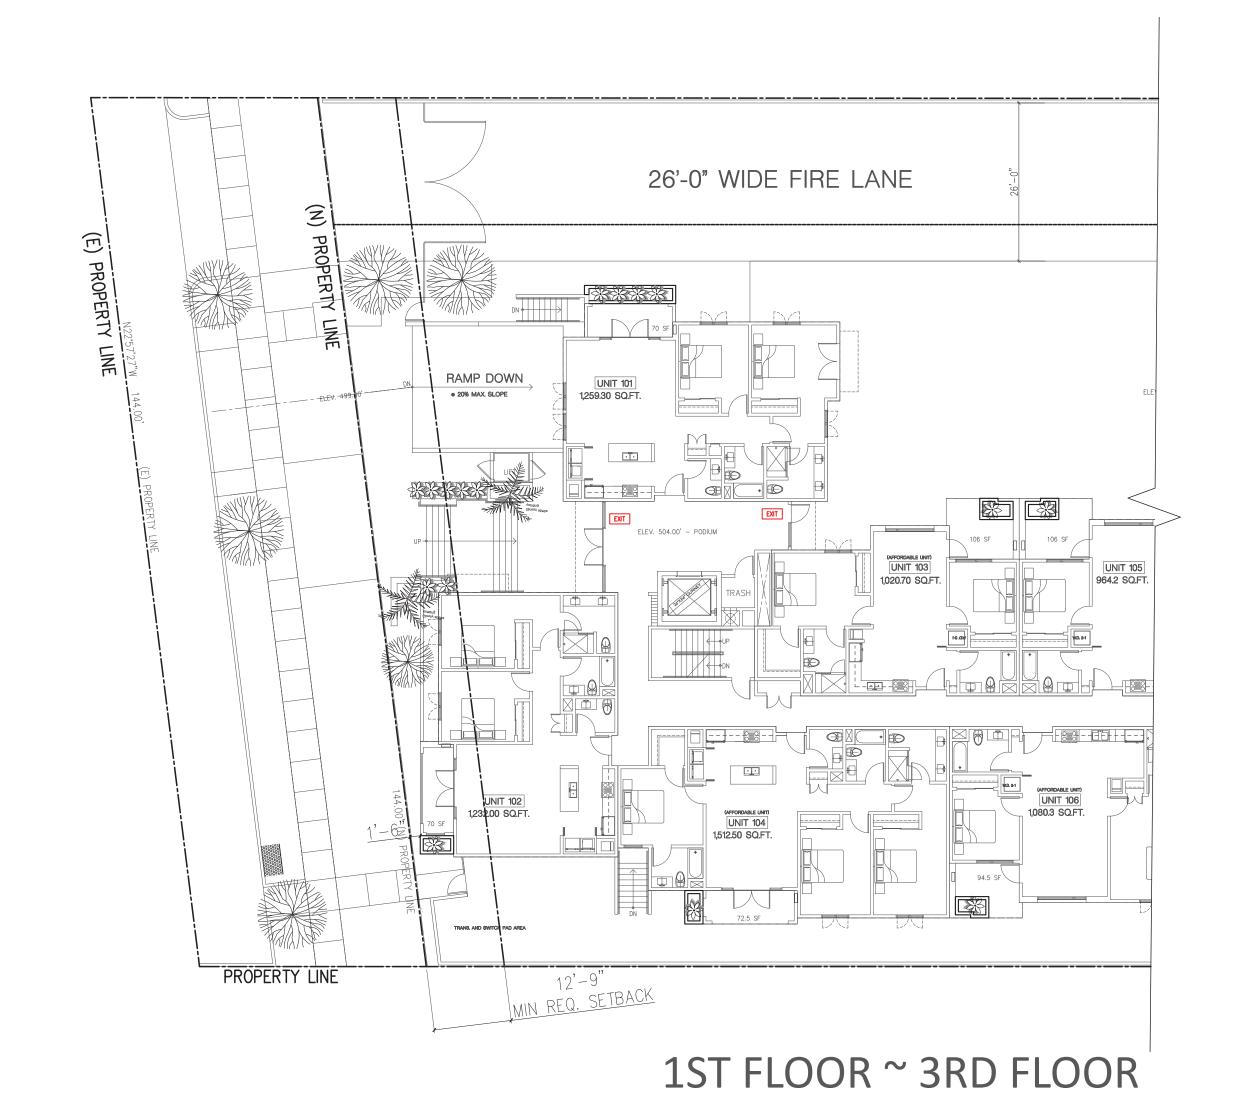



ENCROACHMENT DIAGRAM

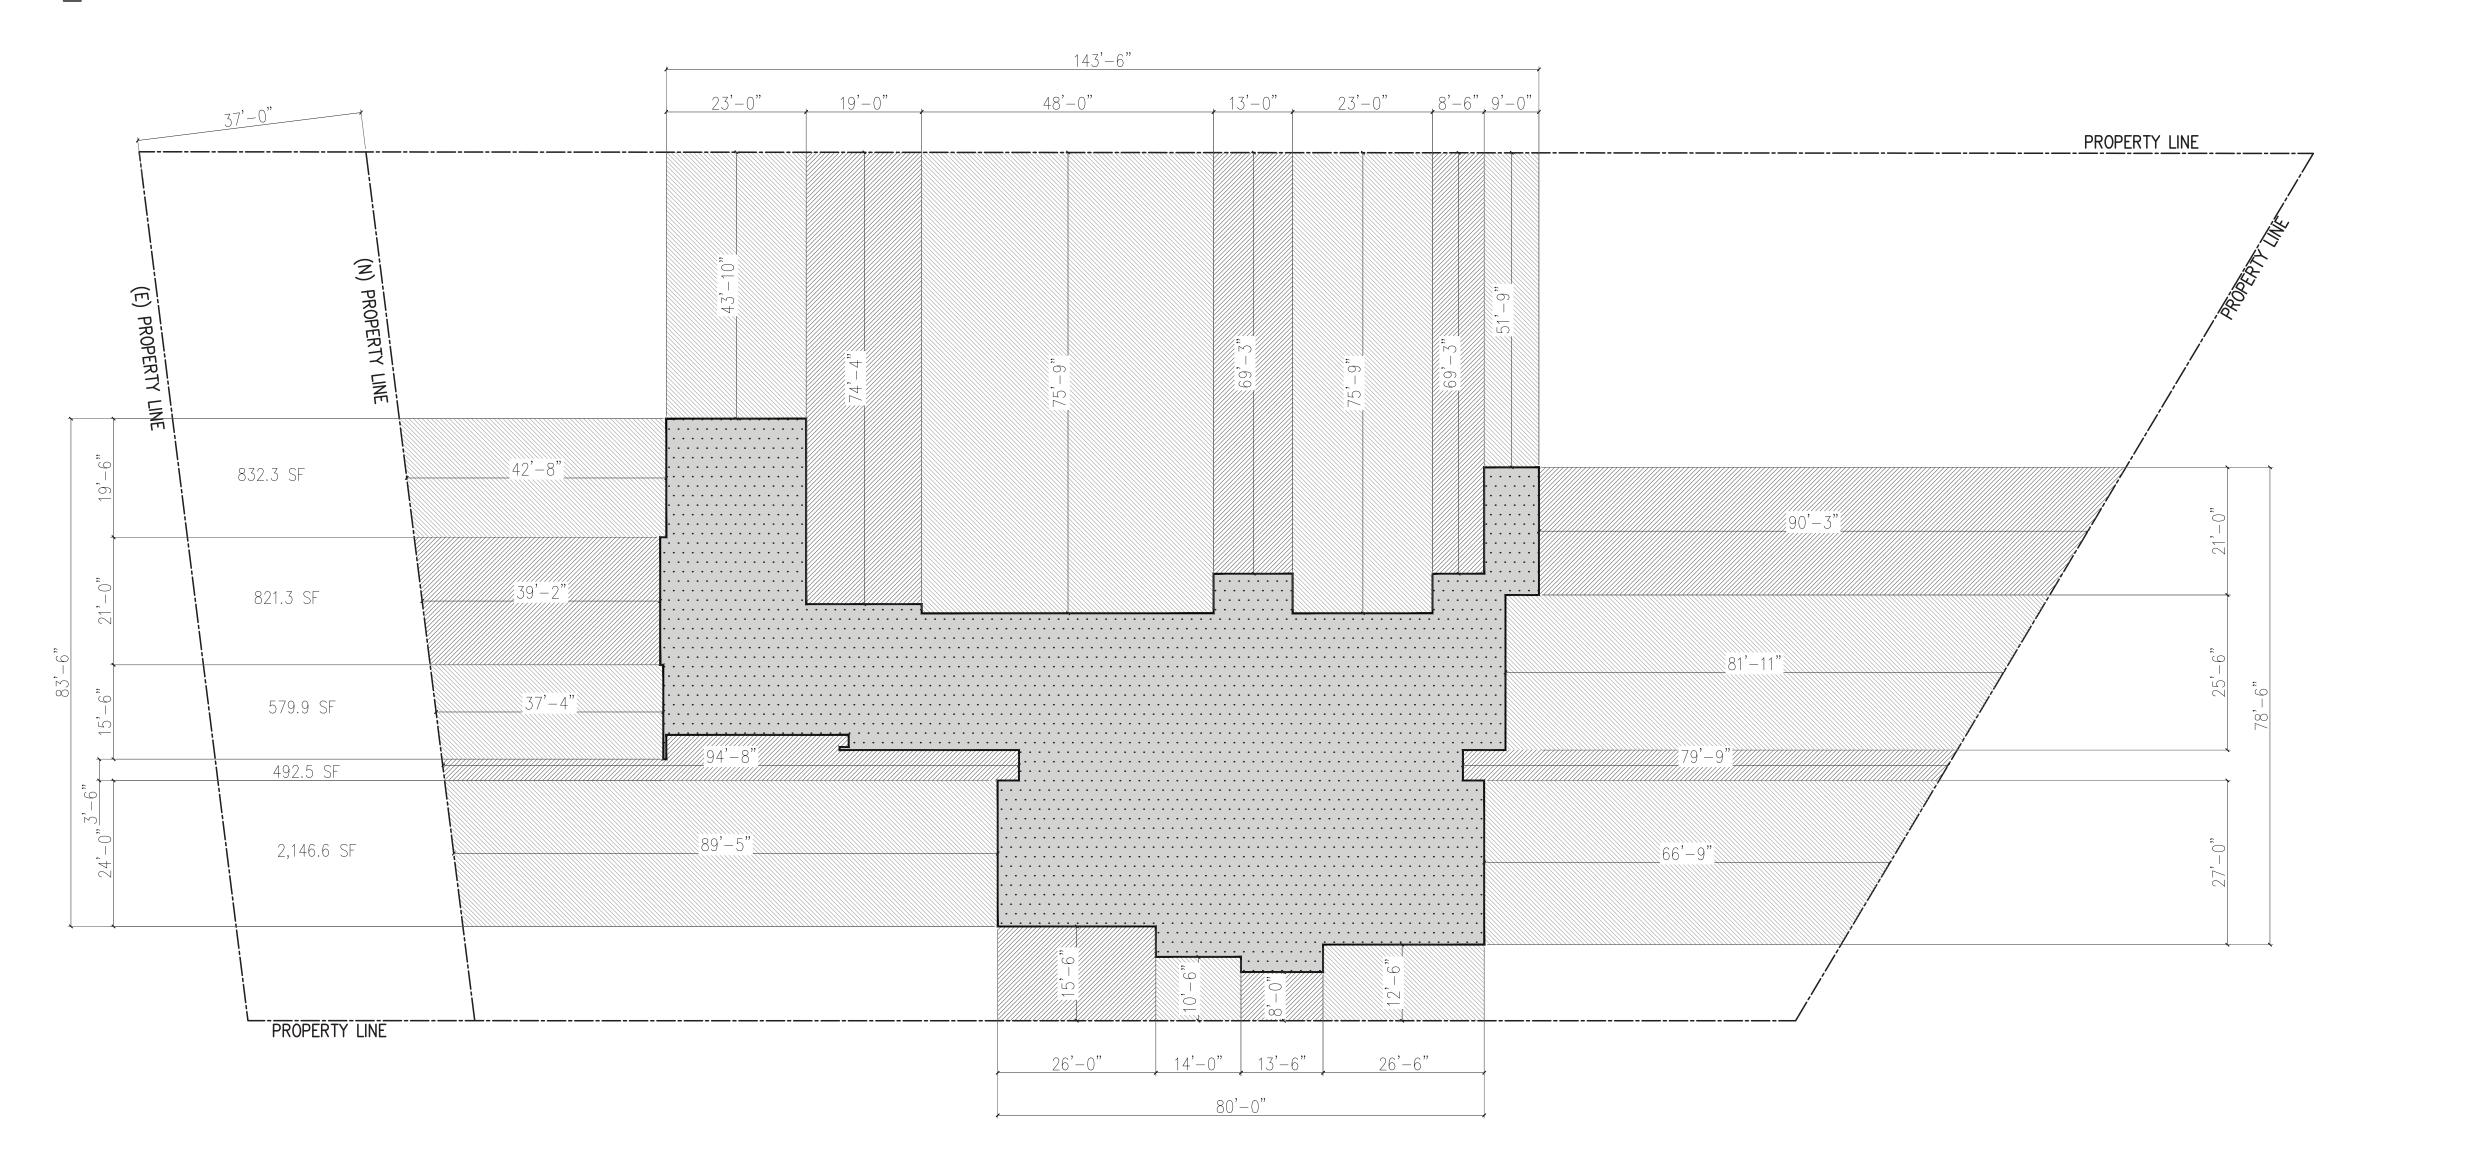

AVERAGE FRONT SETBACK CALCULATIONS:

MIN AVG = 63'-8 1/2" BLDG HGT X 20% = 12'-9" => 12'-9" + 5'-0" = 17'-9"

PROVIDED AVERAGE ON 5TH FLOOR = 58'-4"


TOTAL FRONTAGE= 83'-6"


(832.3 SF) + (821.3 SF) + (579.9 SF) + (492.5 SF) + (2,146.6SF) = 8,872.6 SF / 83'-6" = 58'-4"

FIFTH FLOOR SETBACK DIAGRAM

SCALE: 1/16" = 1'-0"

DIAGRAMS: SETBACKS

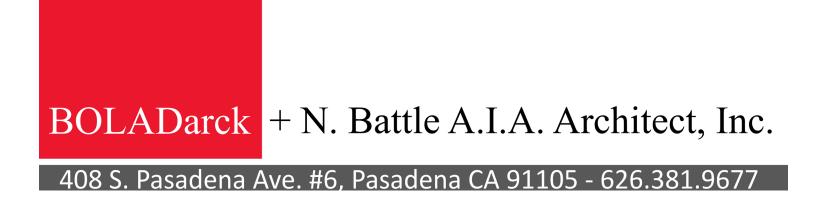


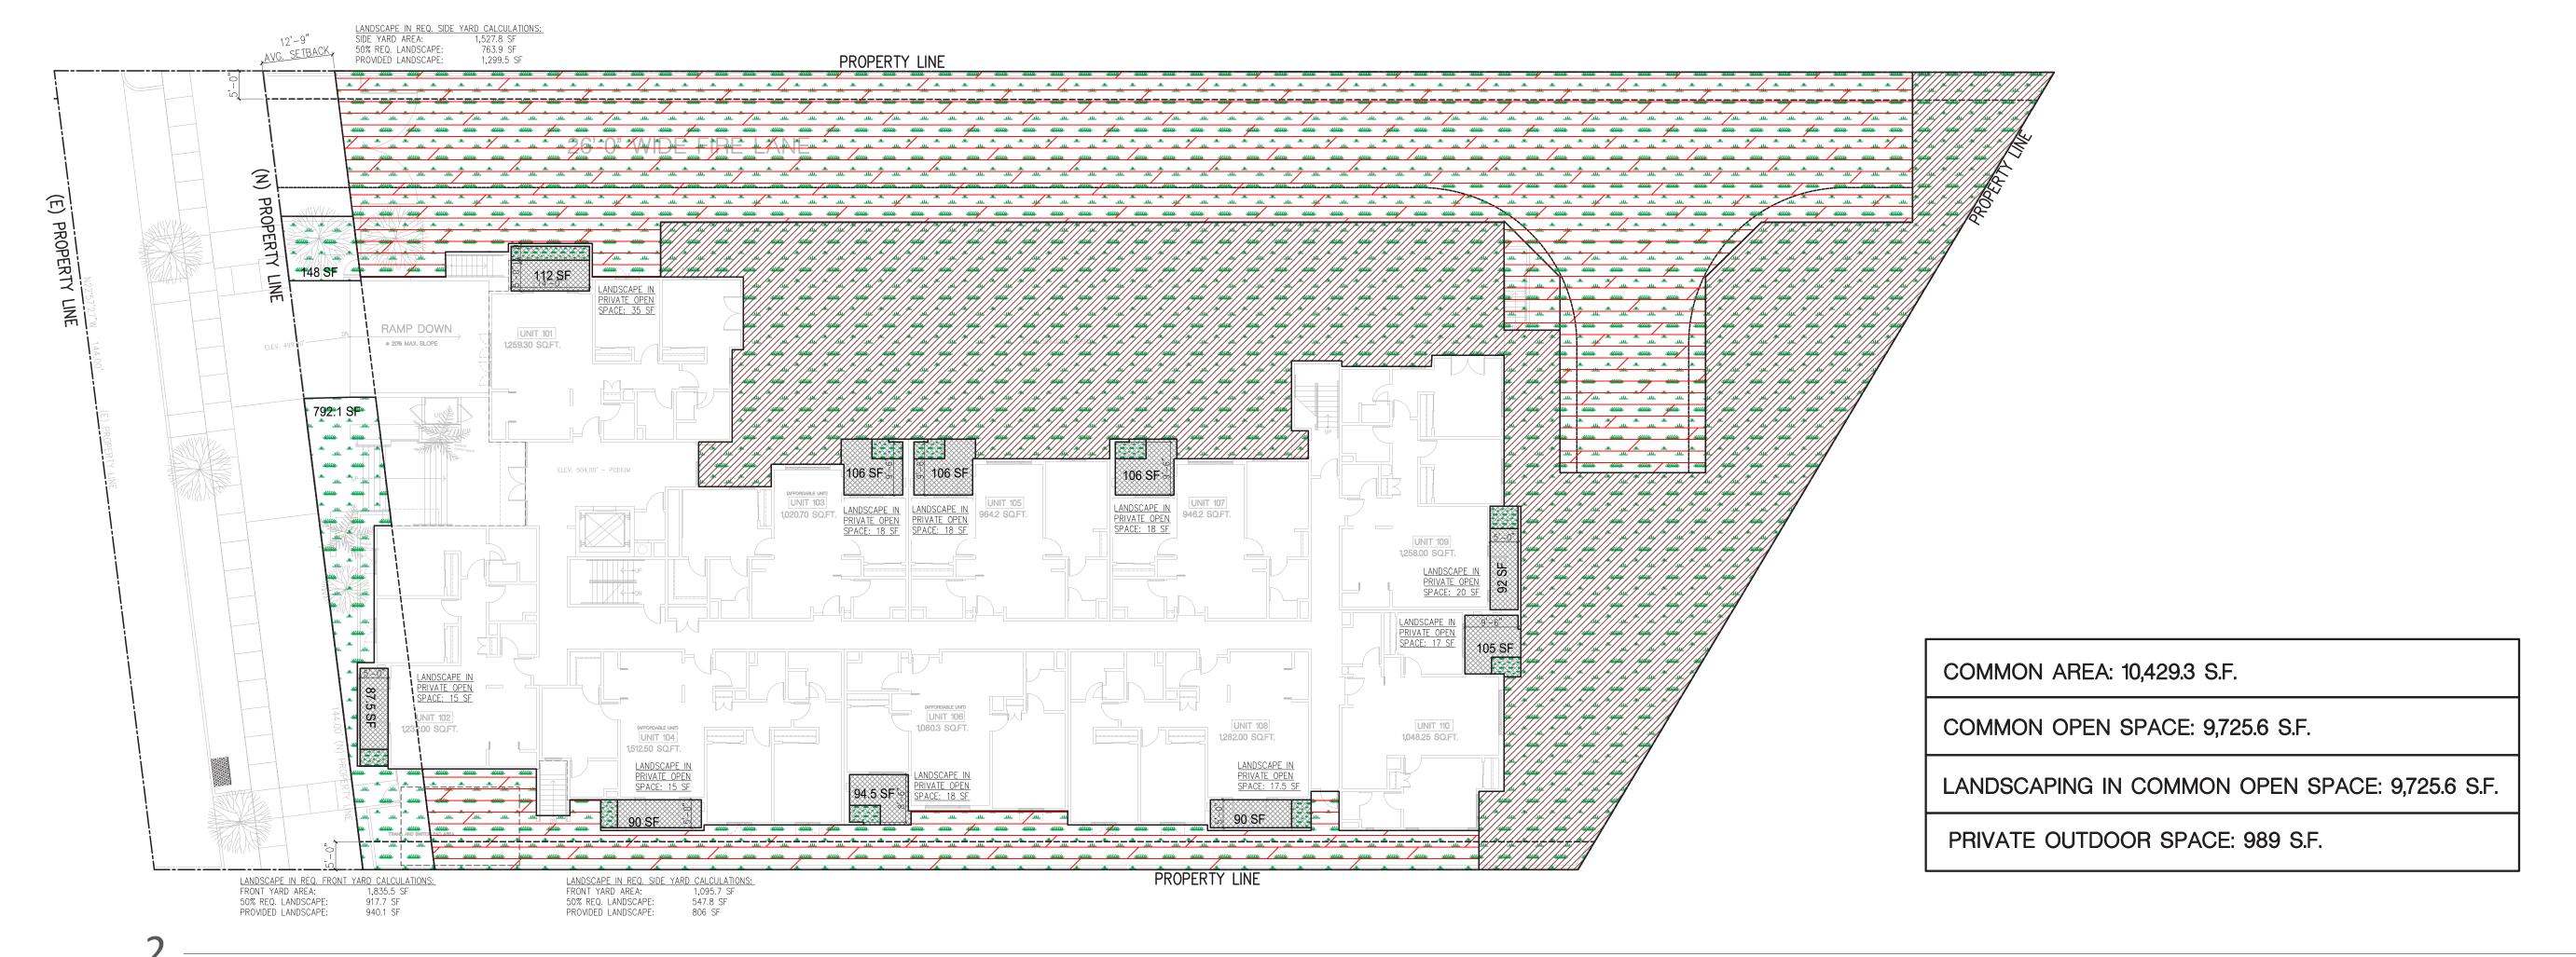

IOTES:

1. PROJECT WILL COMPLY WITH BMS 10-1-624(E)7 AS APPLICABLE DURING THE PLAN CHECK PROCESS.
2. MINIMUM 10% OF PRIVATE OPEN SPACES ON THE GROUND LEVEL ARE LANDSCAPED.

FIRST FLOOR OPEN SPACE DIAGRAM

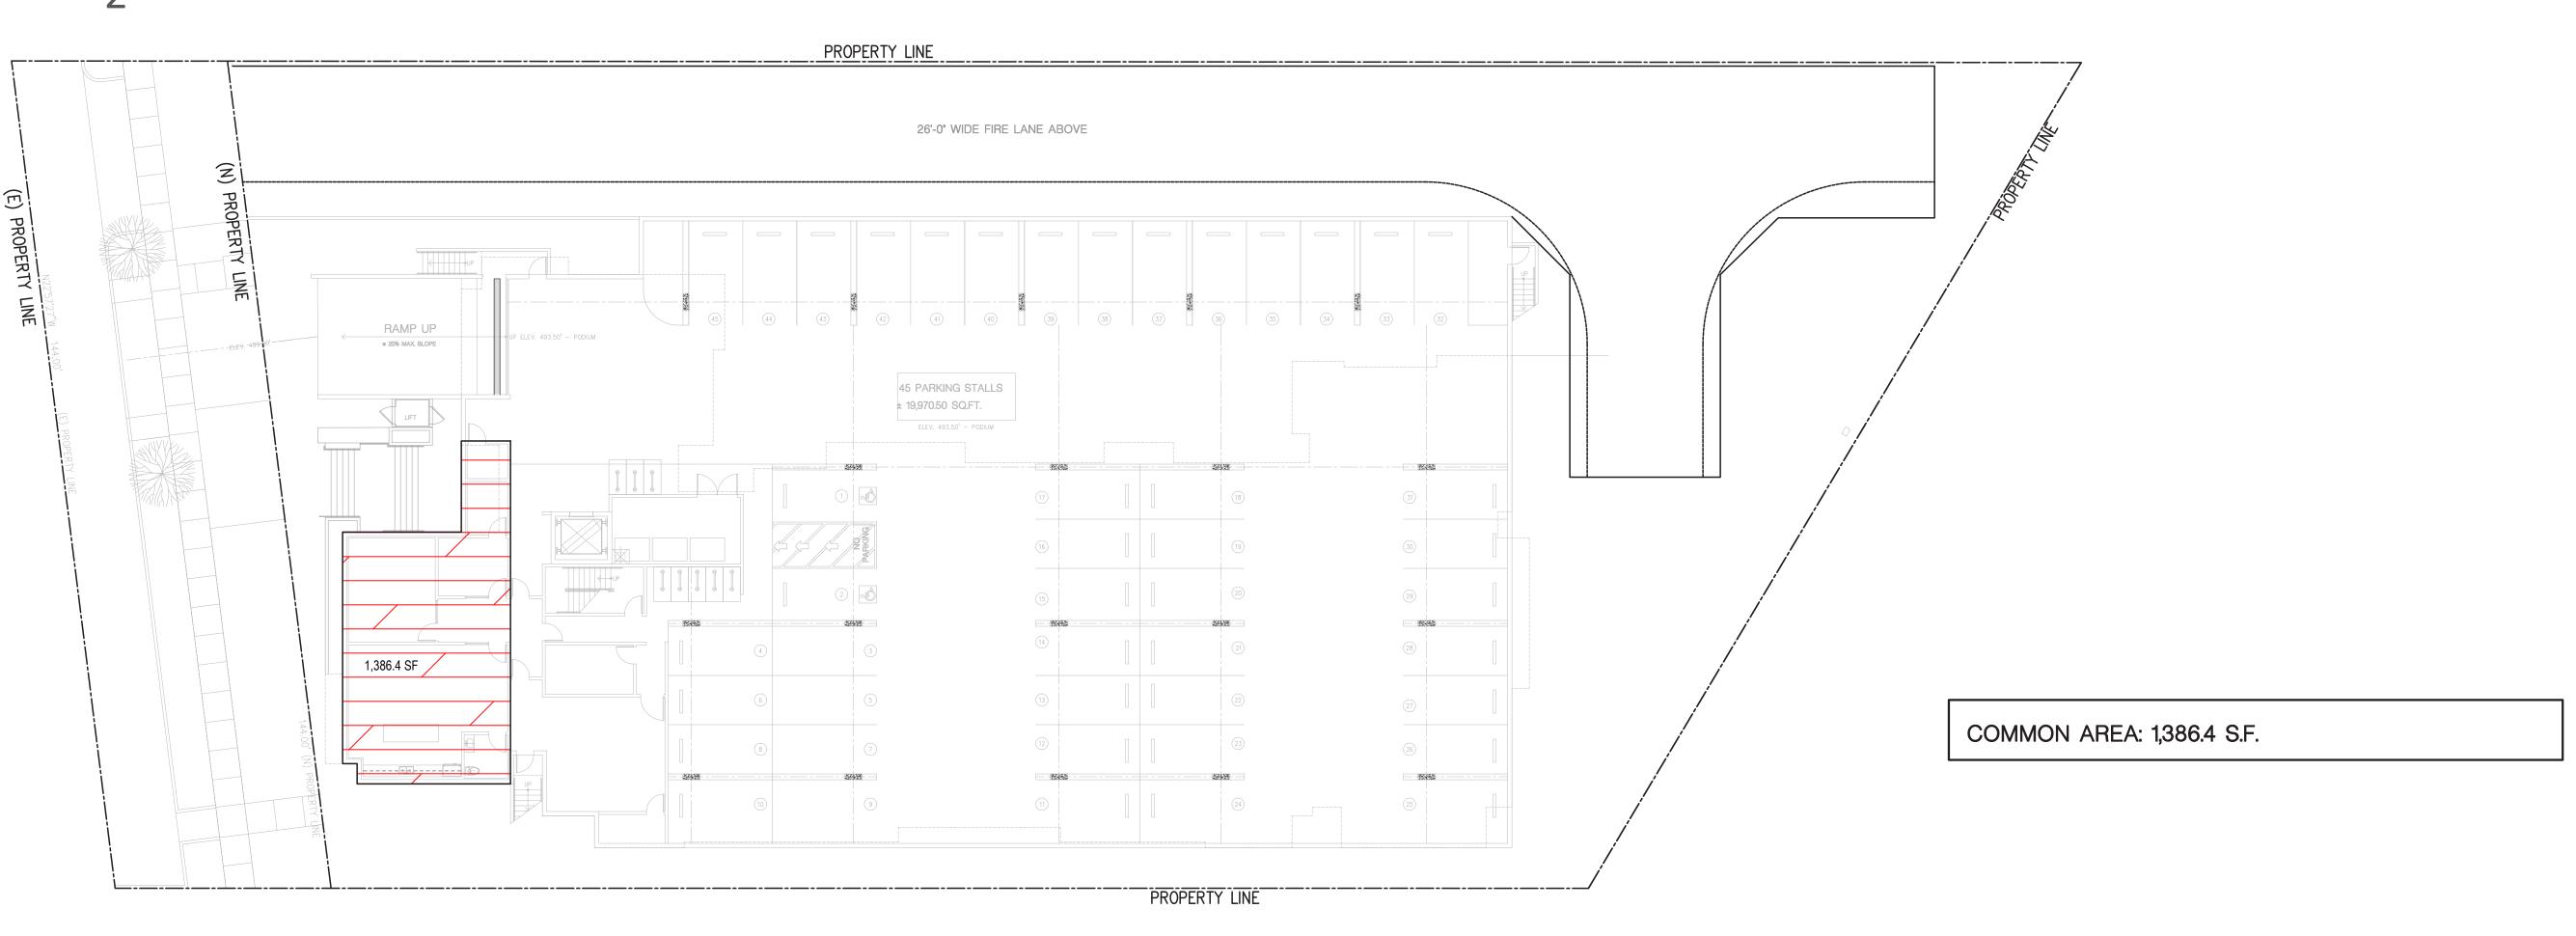

SEMI-SUBTERRANEAN OPEN SPACE DIAGRAM

OPEN SPACE TABULATION							
FLOOR LEVEL	PARKING	1ST FLOOR	2ND FLOOR	3RD FLOOR	4TH FLOOR	5TH FLOOR	TOTAL
COMMON AREA	1,386.4 S.F.	10,429.3 S.F.				517 S.F.	12,332.7 S.F.
COMMON OPEN SPACE AREA		9,725.6 S.F.				5,966.2 S.F.	15,691.8 S.F.
LANDSCAPING IN COMMON OPEN SPACE		9,725.6 S.F.					9,725.6 S.F.
PRIVATE OUTDOOR SPACE:		989 S.F.	867.5 S.F.	867.5 S.F.	1,067 S.F.	481.7 S.F.	4,272.7 SF

LEGEND

COMMON OPEN SPACE

PRIVATE OUTDOOR SPACE

COMMON AREA


LANDSCAPE ARE

SCALE: 1/16" = 1'-0"

DIAGRAMS: OPEN SPACE



NOTE: ANY OPEN SPACE WITH MINIMUM DIMENSION OF LESS THAT 5 FEET IS NOT A PART OF THE CALCULATIONS.

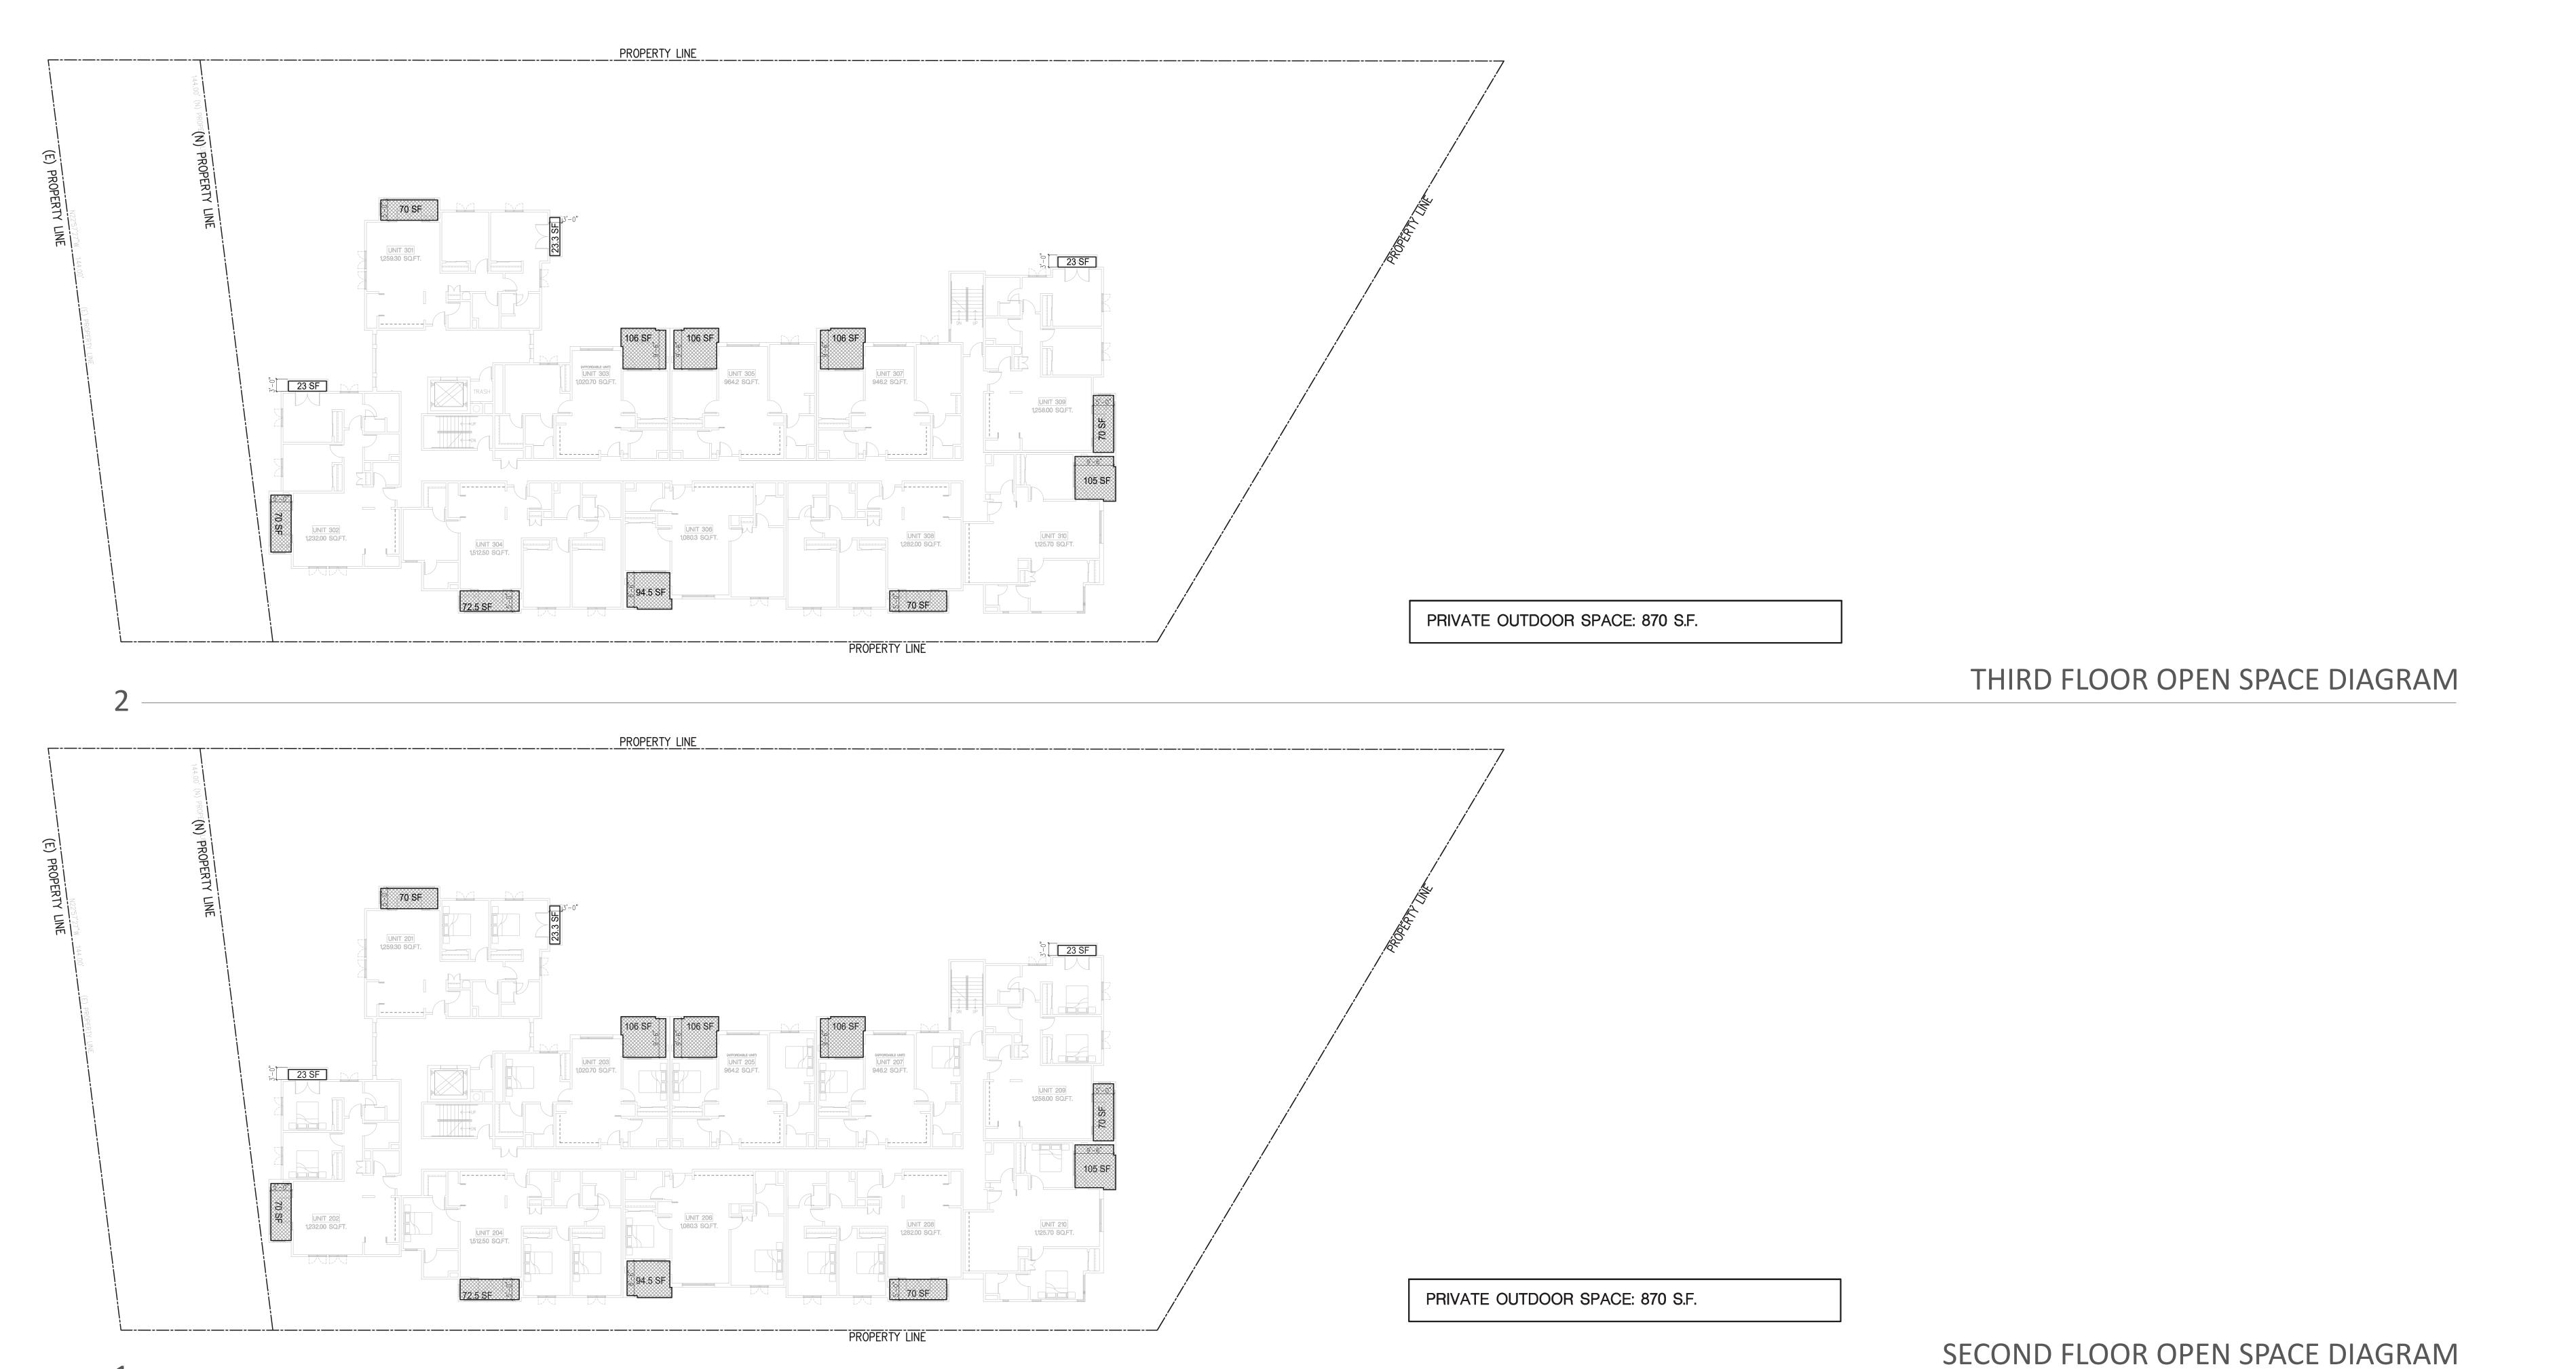

OPEN SPACE TABULATION	V						
FLOOR LEVEL	PARKING	1ST FLOOR	2ND FLOOR	3RD FLOOR	4TH FLOOR	5TH FLOOR	TOTAL
COMMON AREA	1,386.4 S.F.	10,429.3 S.F.				517 S.F.	12,332.7 S.F.
COMMON OPEN SPACE AREA		9,725.6 S.F.				5,966.2 S.F.	15,691.8 S.F.
LANDSCAPING IN COMMON OPEN SPACE		9,725.6 S.F.					9,725.6 S.F.
PRIVATE OUTDOOR SPACE:		989 S.F.	867.5 S.F.	867.5 S.F.	1,067 S.F.	481.7 S.F.	4,272.7 SF

LCOND I LOOK OF LIN STACE DIAGRAM

COMMON OPEN SPACE

PRIVATE OUTDOOR SPACE


COMMON AREA

LANDSCAPE AREA


LEGEND

SCALE : 1/16" = 1'-0"


DIAGRAMS: OPEN SPACE

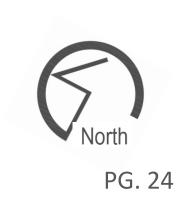

NOTE: ANY OPEN SPACE WITH MINIMUM DIMENSION OF LESS THAT 5 FEET IS NOT A PART OF THE CALCULATIONS.

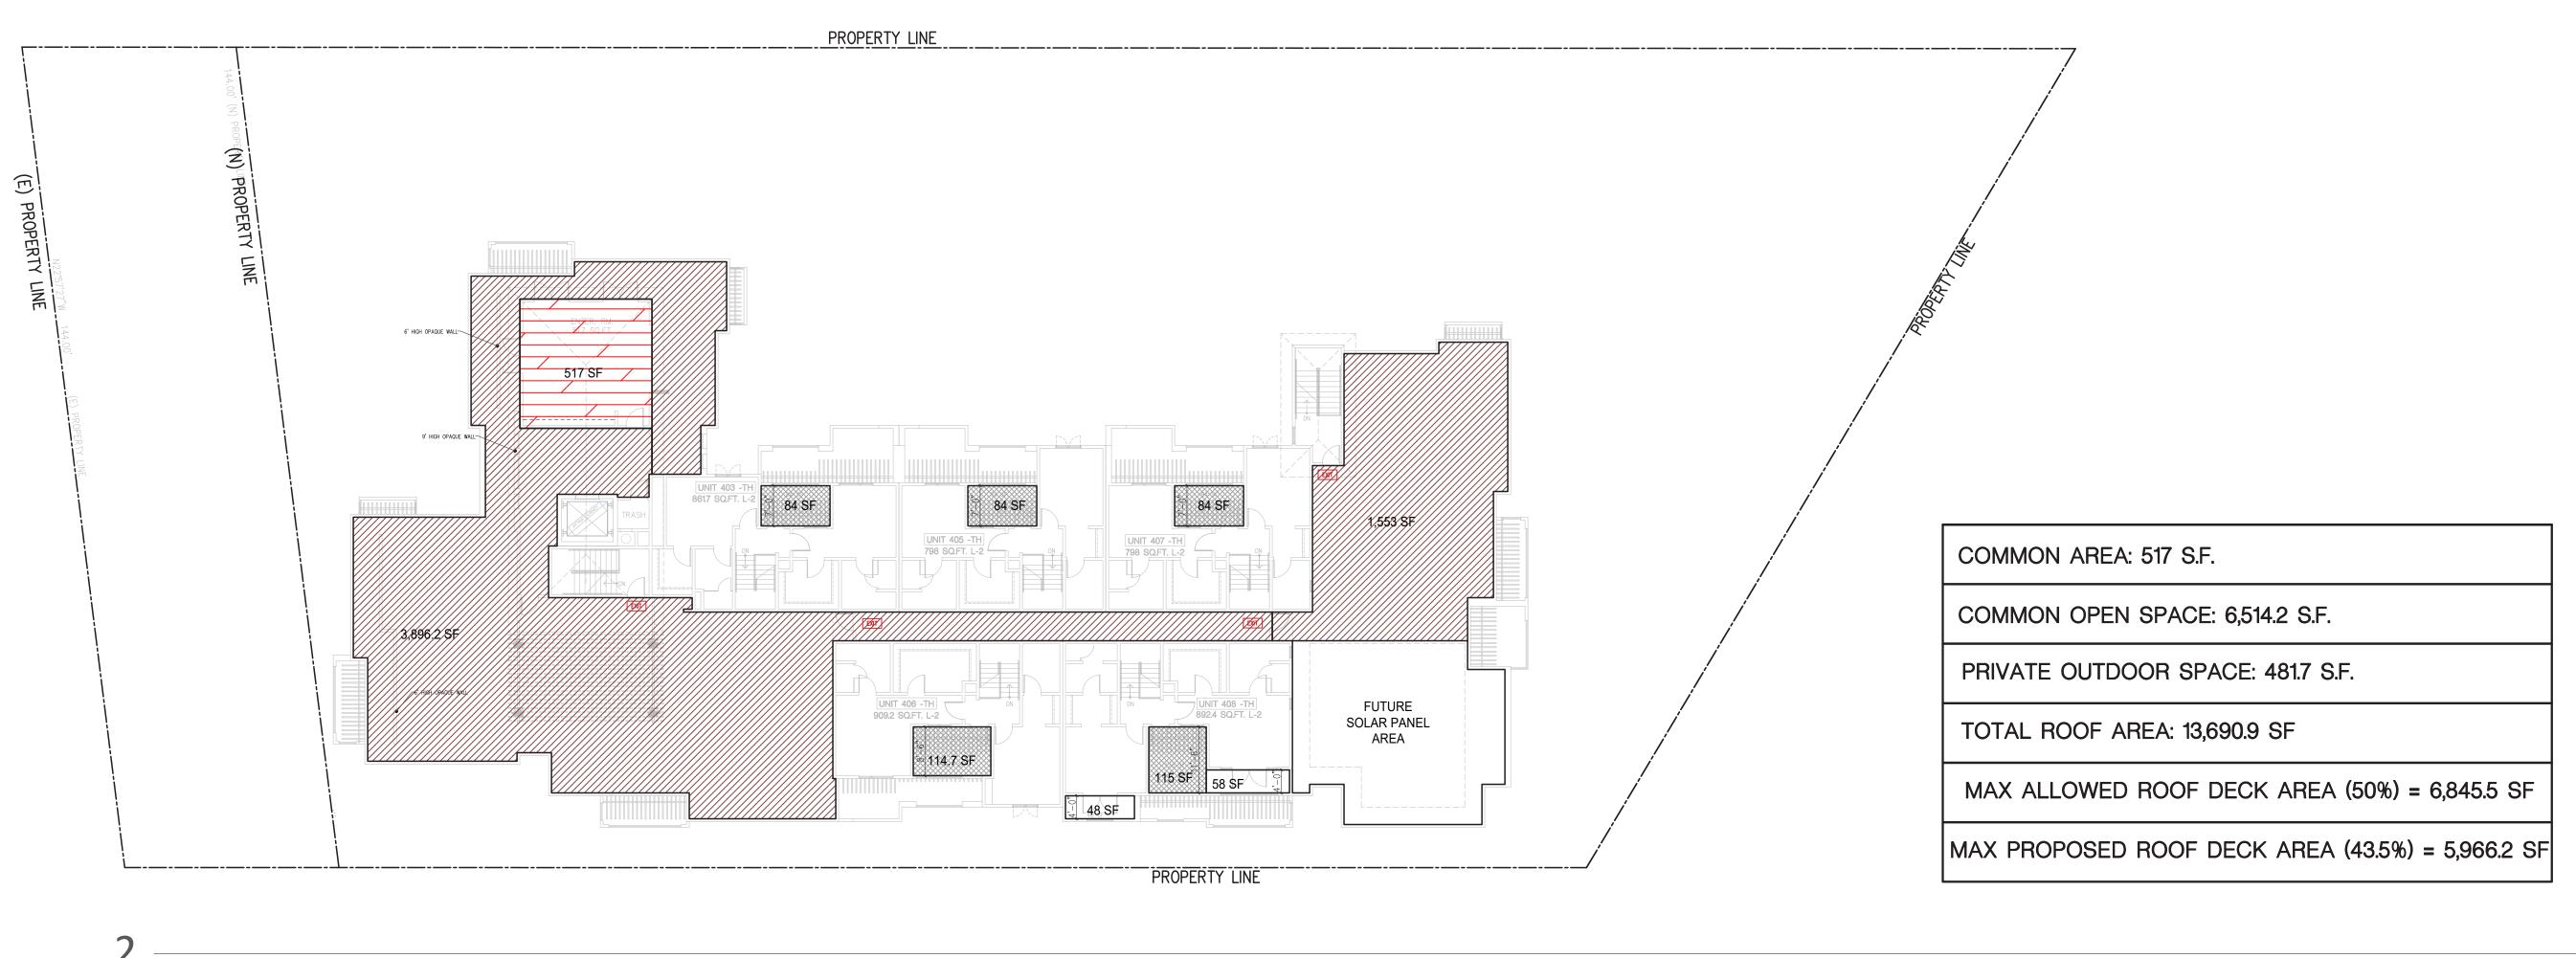

FIFTH FLOOR OPEN SPACE DIAGRAM

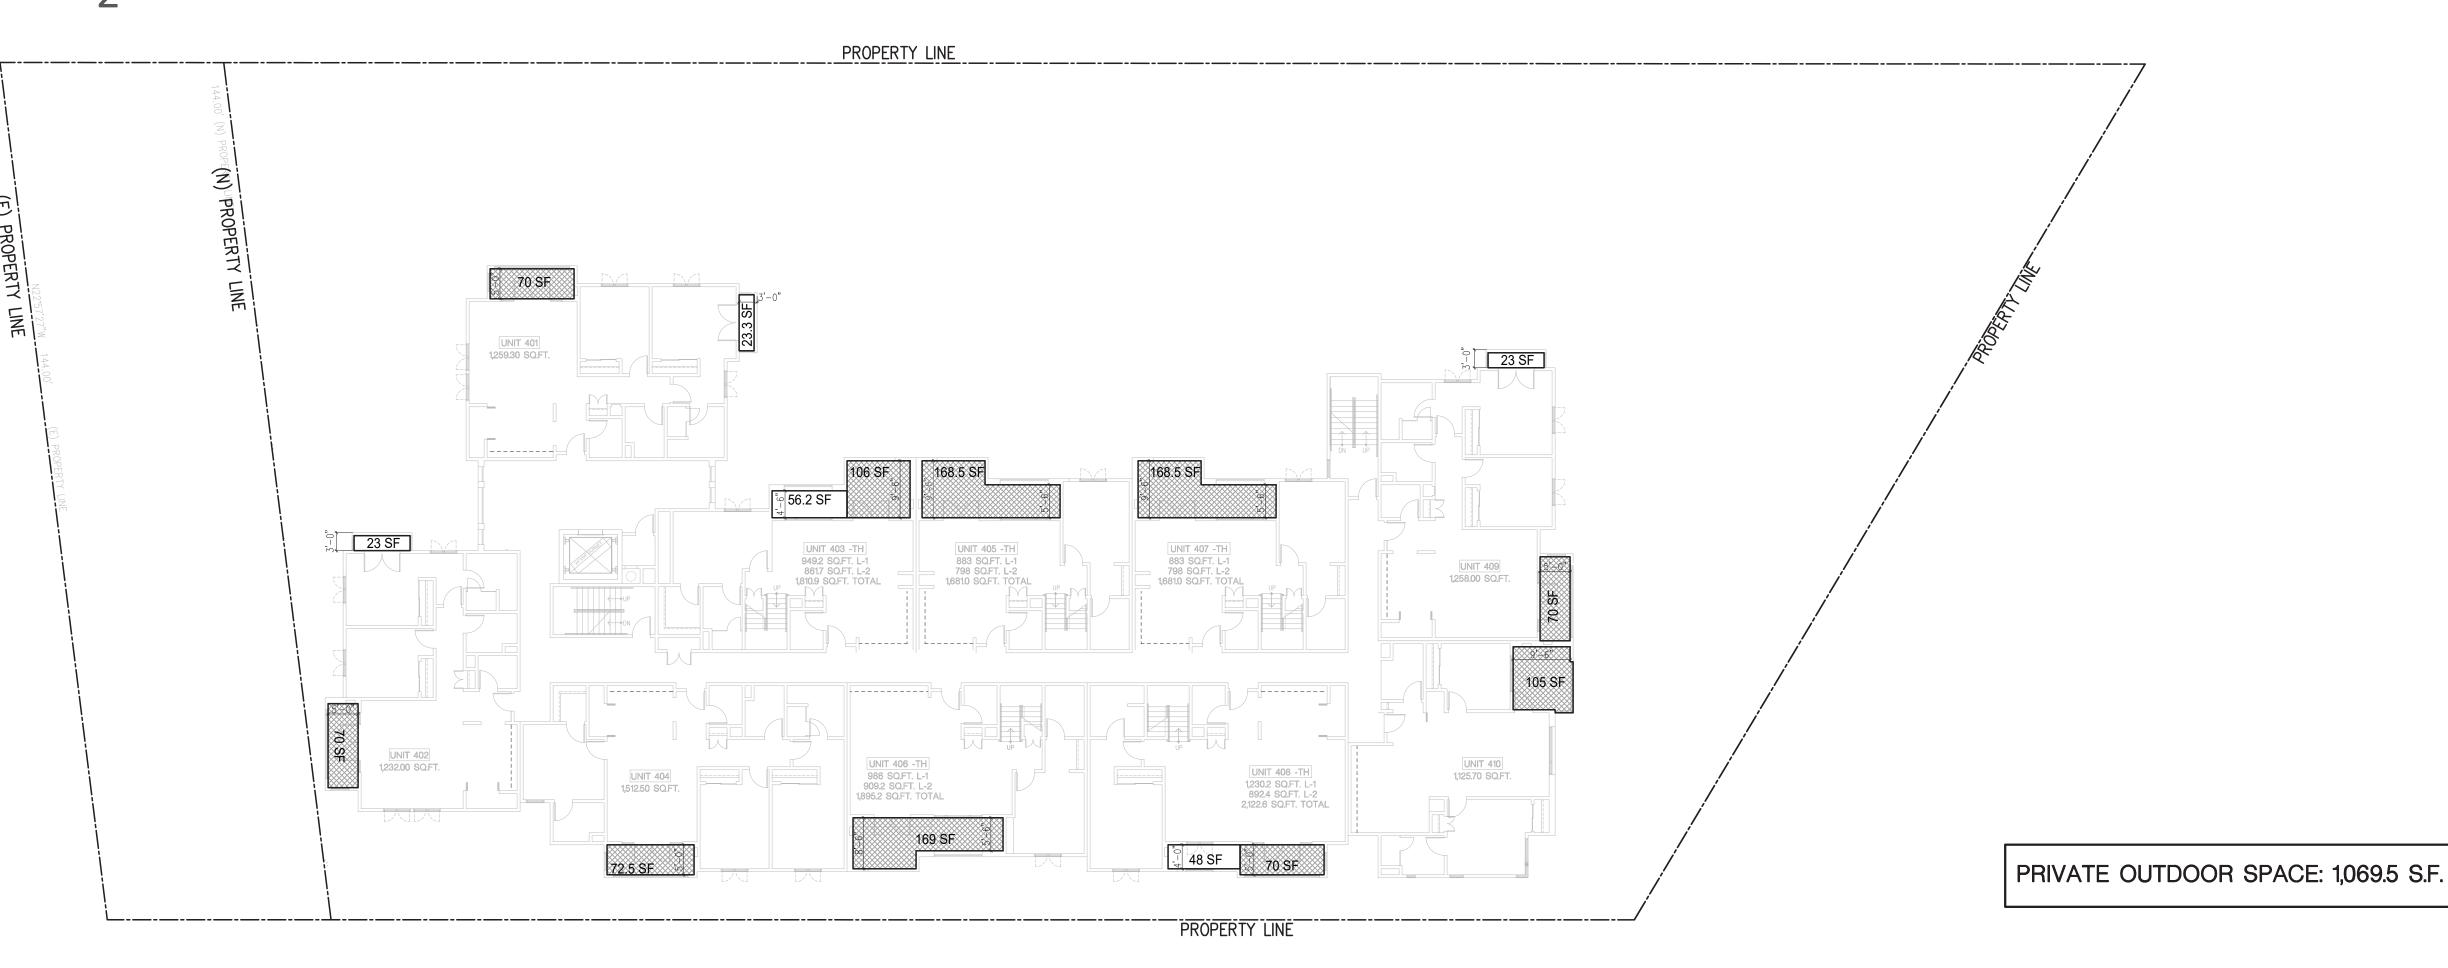

FOURTH FLOOR OPEN SPACE DIAGRAM

OPEN SPACE TABULATION							
FLOOR LEVEL	PARKING	1ST FLOOR	2ND FLOOR	3RD FLOOR	4TH FLOOR	5TH FLOOR	TOTAL
COMMON AREA	1,386.4 S.F.	10,429.3 S.F.				517 S.F.	12,332.7 S.F.
COMMON OPEN SPACE AREA		9,725.6 S.F.				5,966.2 S.F.	15,691.8 S.F.
LANDSCAPING IN COMMON OPEN SPACE		9,725.6 S.F.					9,725.6 S.F.
PRIVATE OUTDOOR SPACE:		989 S.F.	867.5 S.F.	867.5 S.F.	1,067 S.F.	481.7 S.F.	4,272.7 SF

NOTE: ANY OPEN SPACE WITH MINIMUM DIMENSION OF LESS THAT 5 FEET IS NOT A PART OF THE CALCULATIONS.

COMMON OPEN SPACE

PRIVATE OUTDOOR SPACE

COMMON AREA


LEGEND

SCALE: 1/16" = 1'-0"

DIAGRAMS: OPEN SPACE




408 S. Pasadena Ave. #6, Pasadena CA 91105 - 626.381.9677

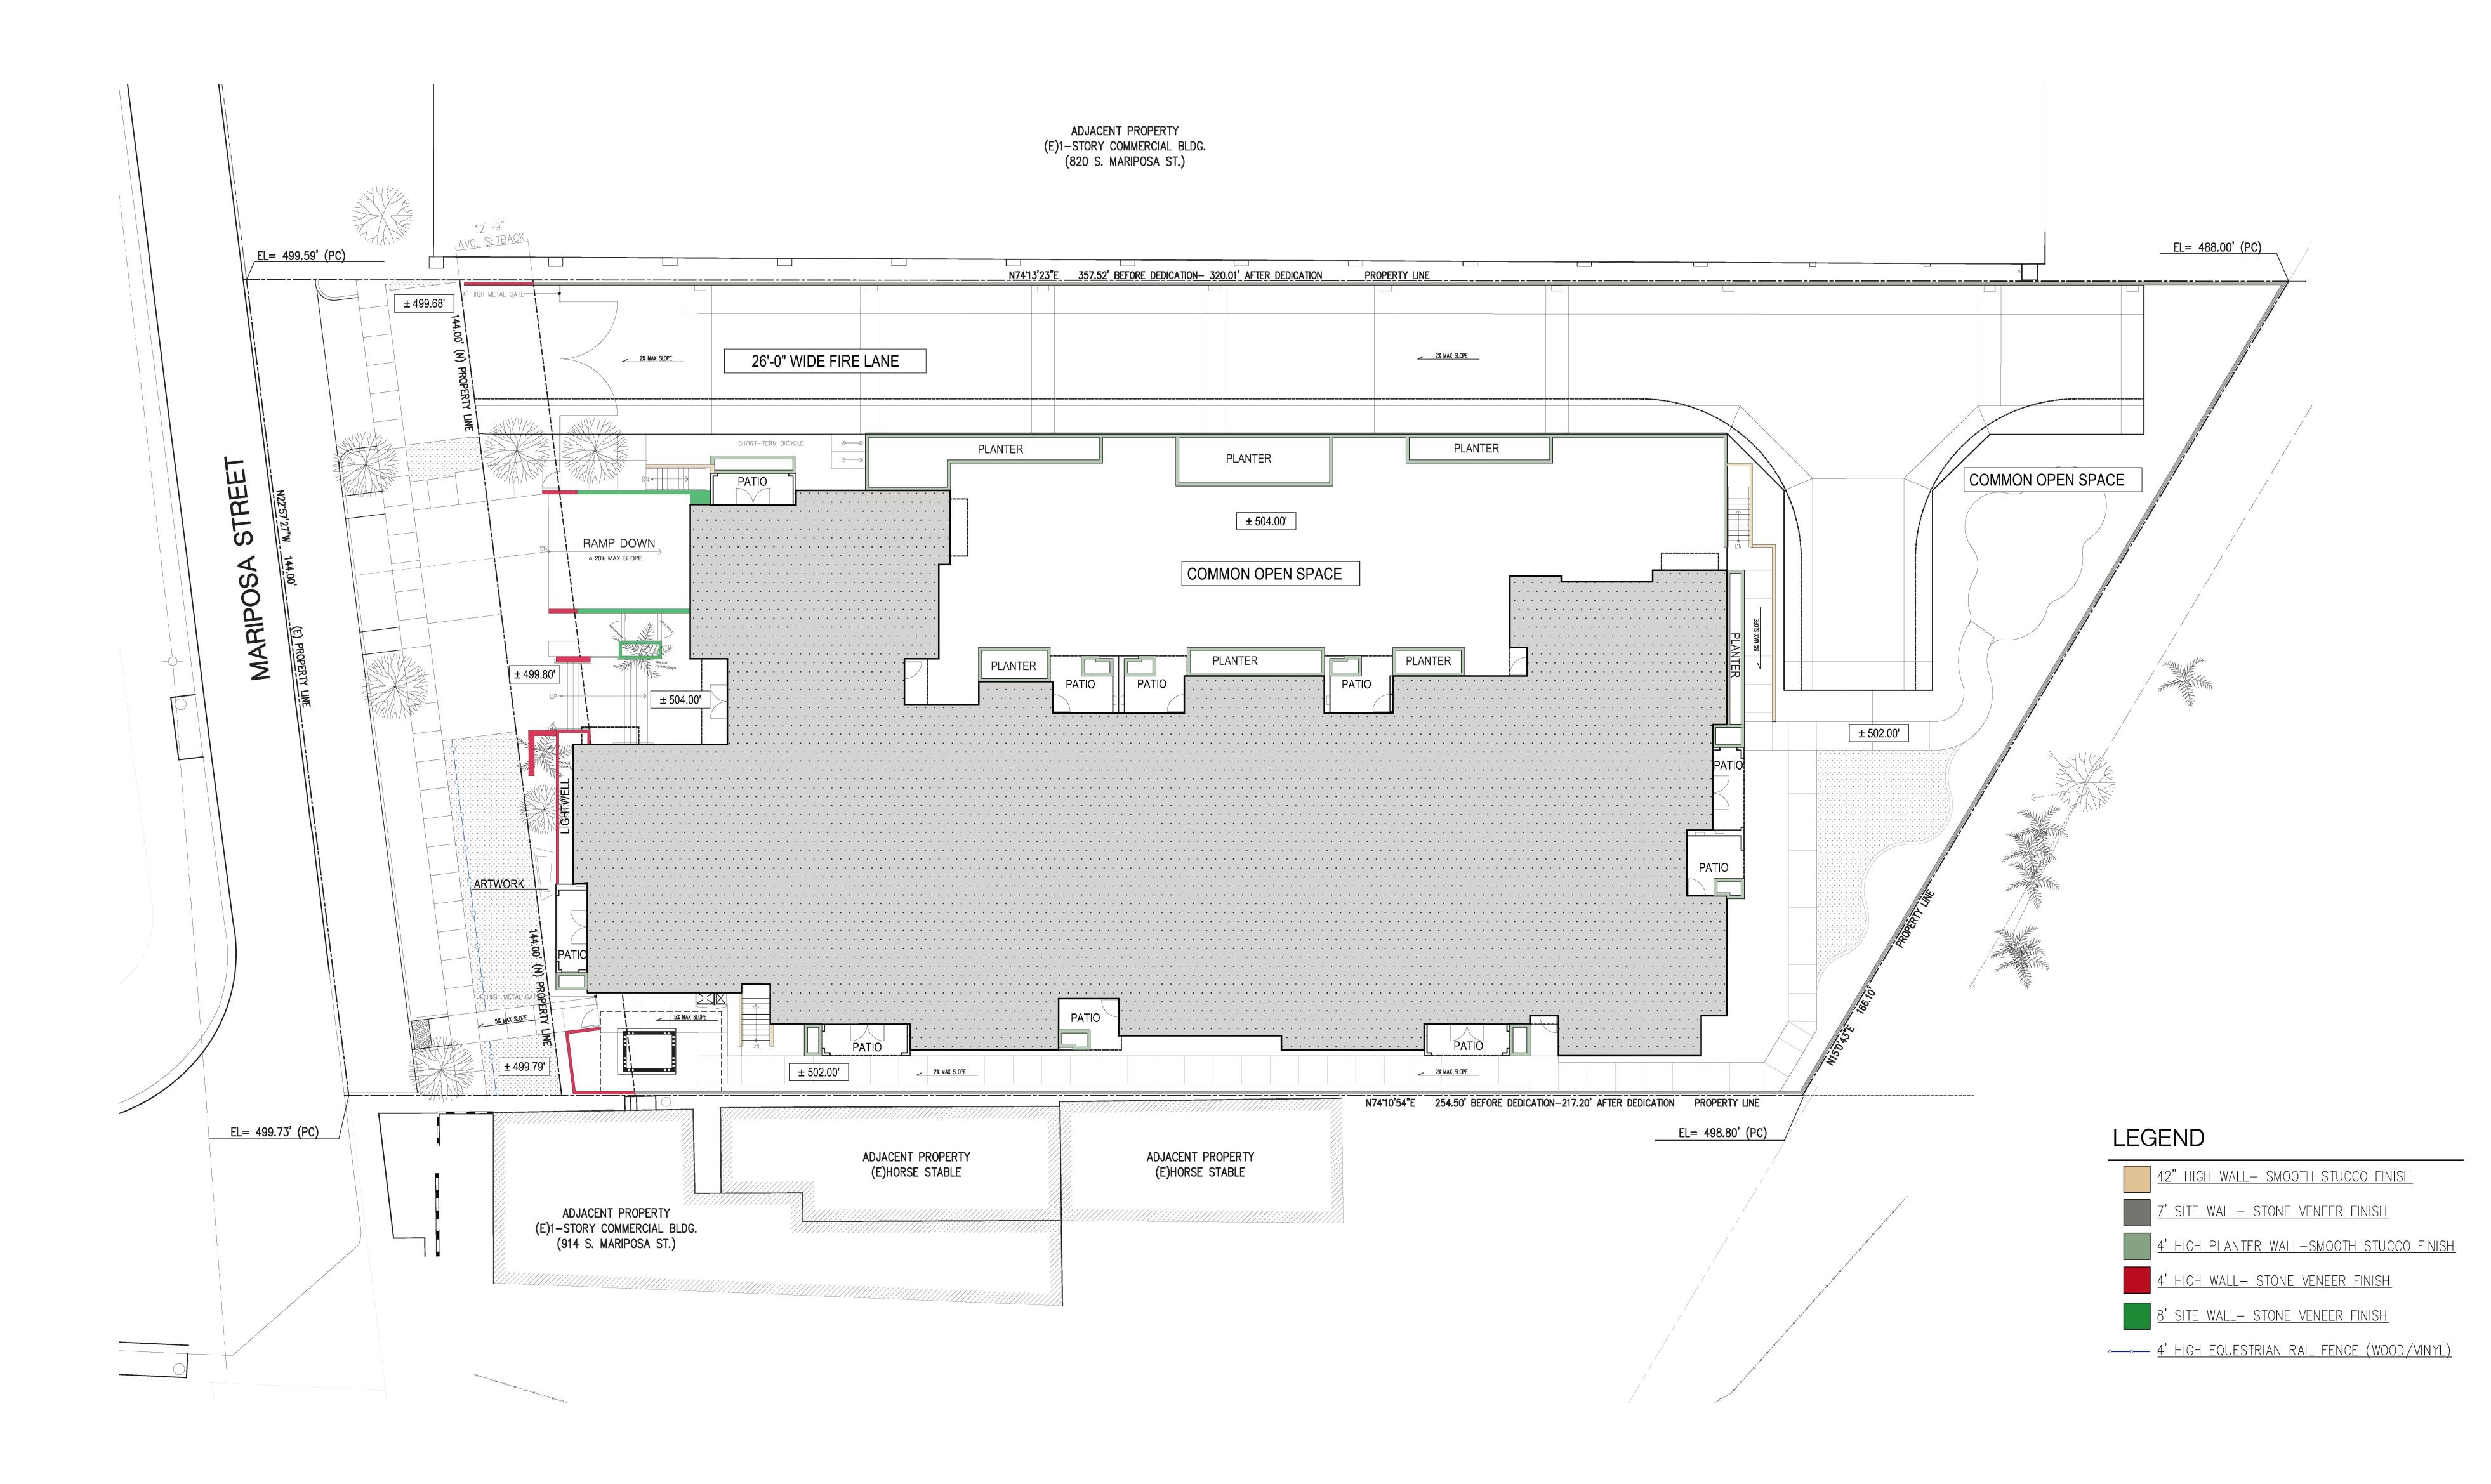


SCALE: 3/32" = 1'-0"

DIAGRAMS: SITE WALLS AND FENCES




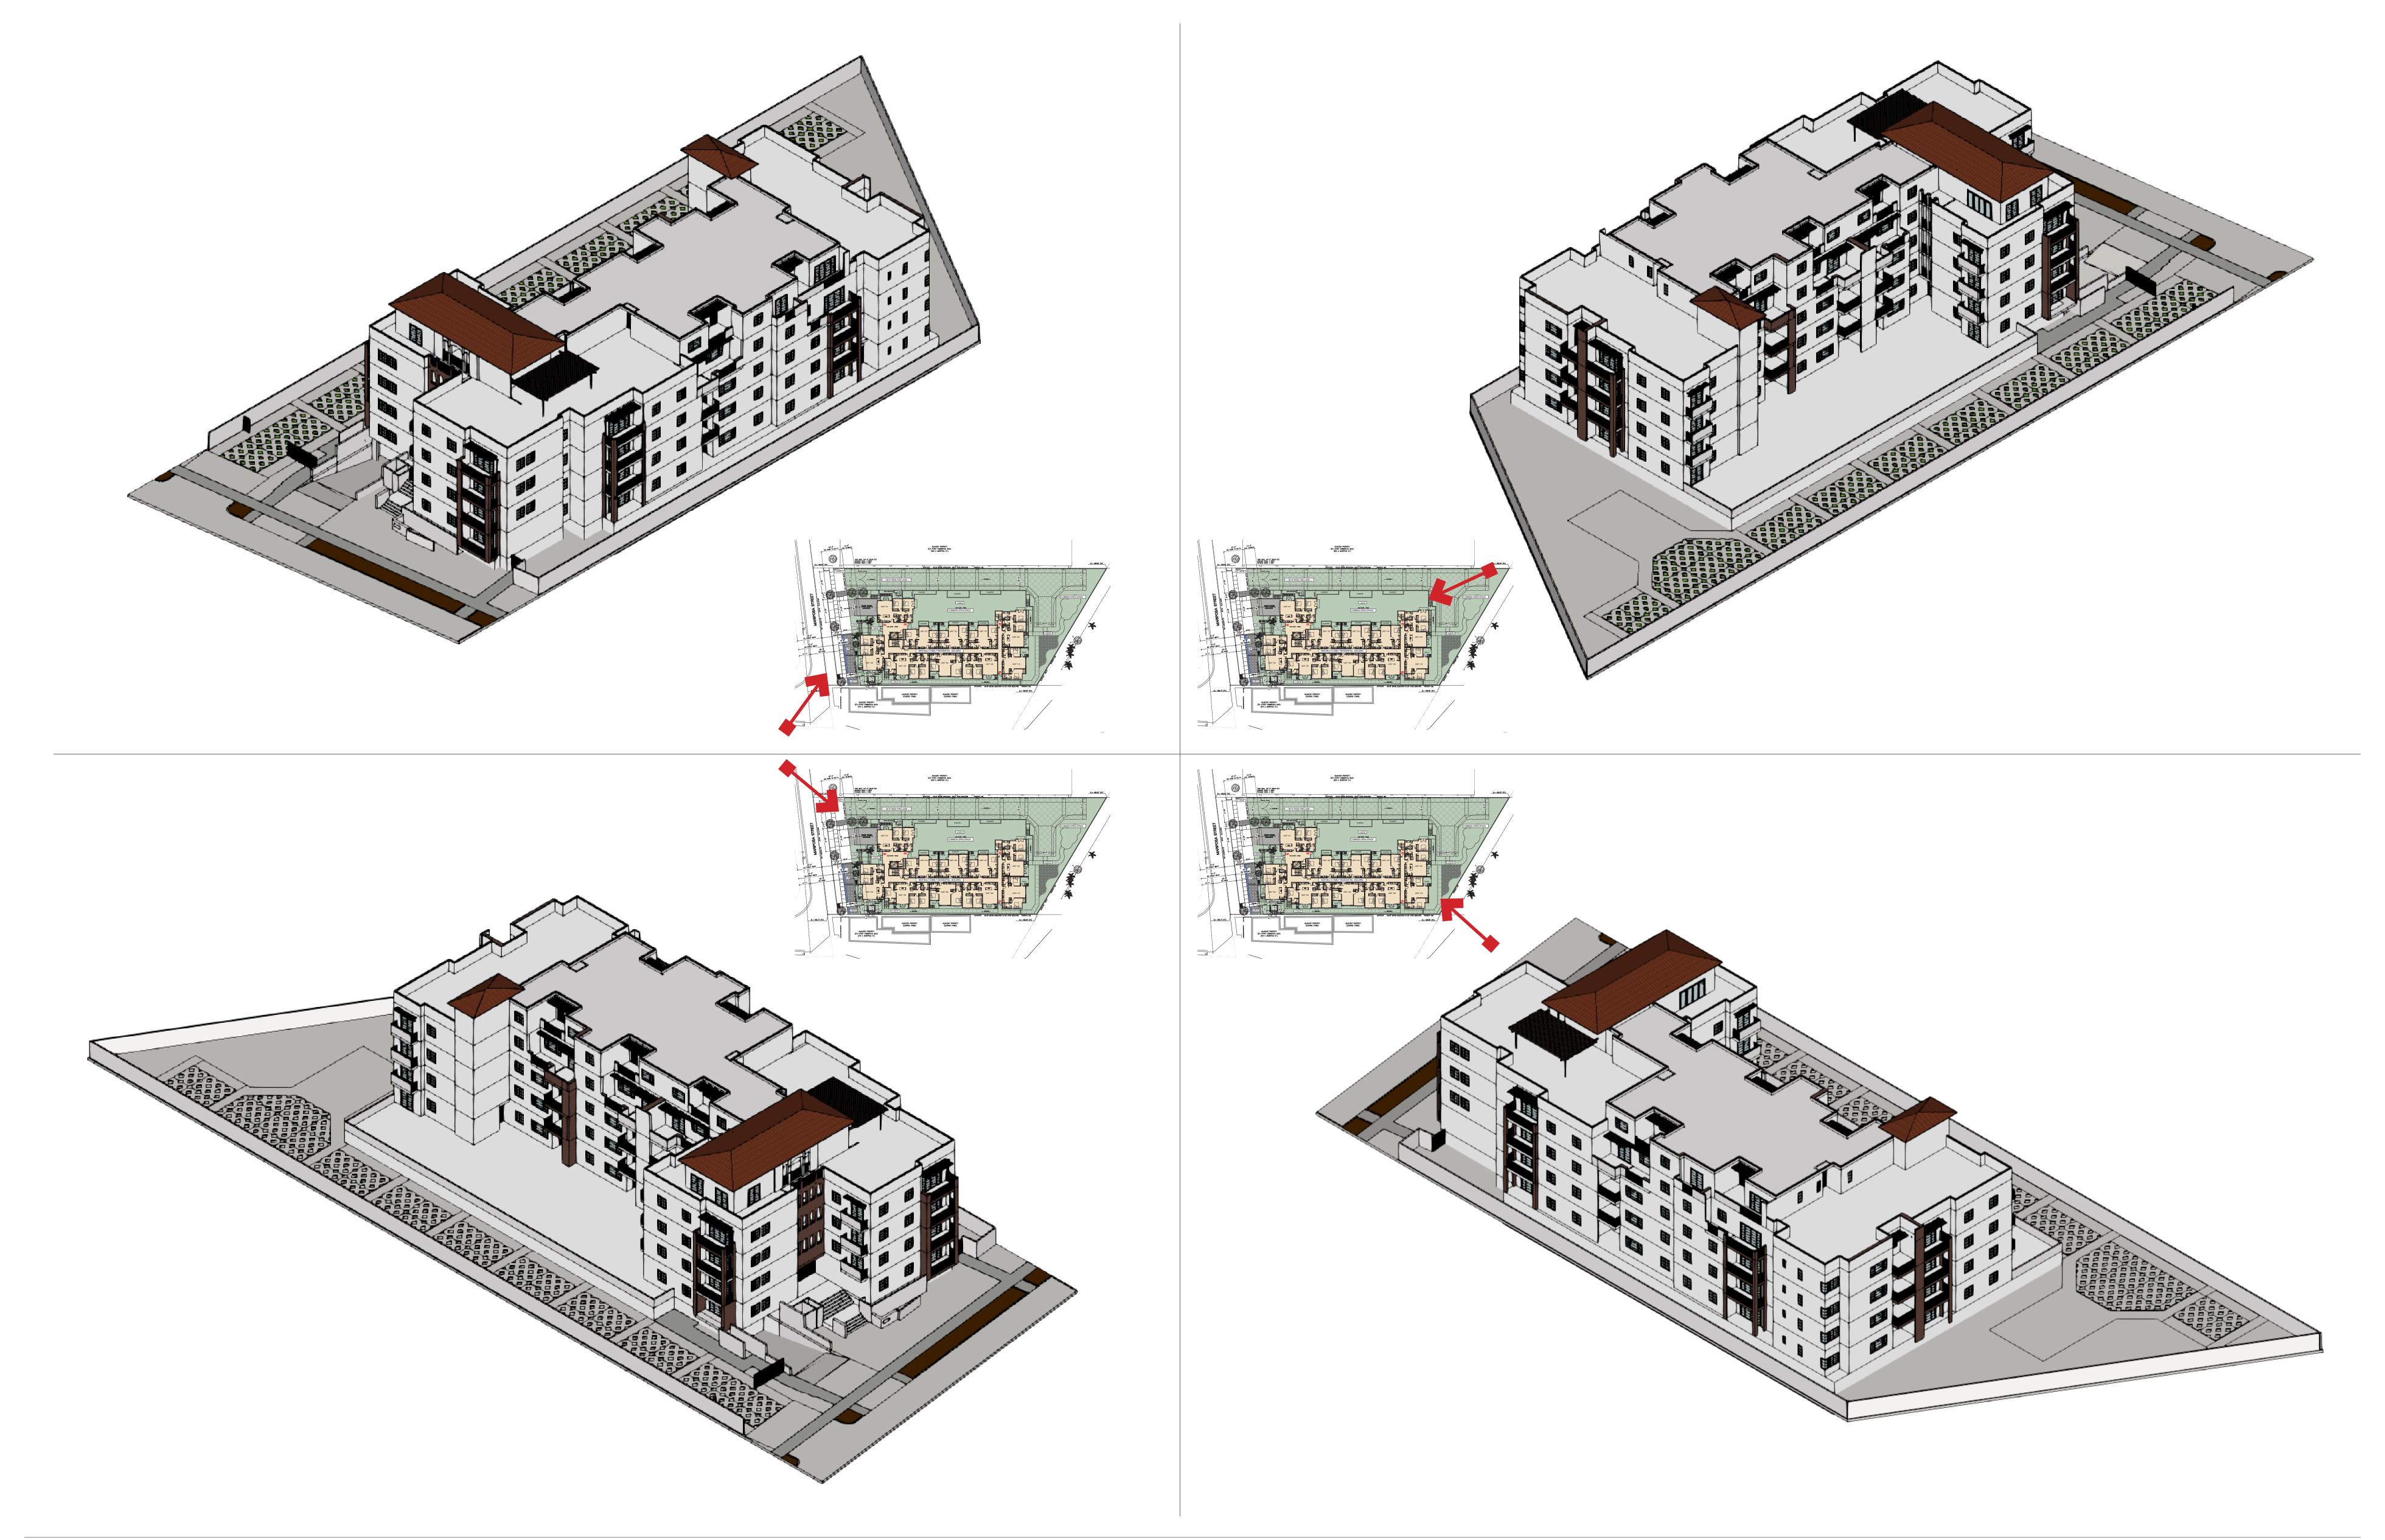

3D VIEWS: MASSING STUDIES

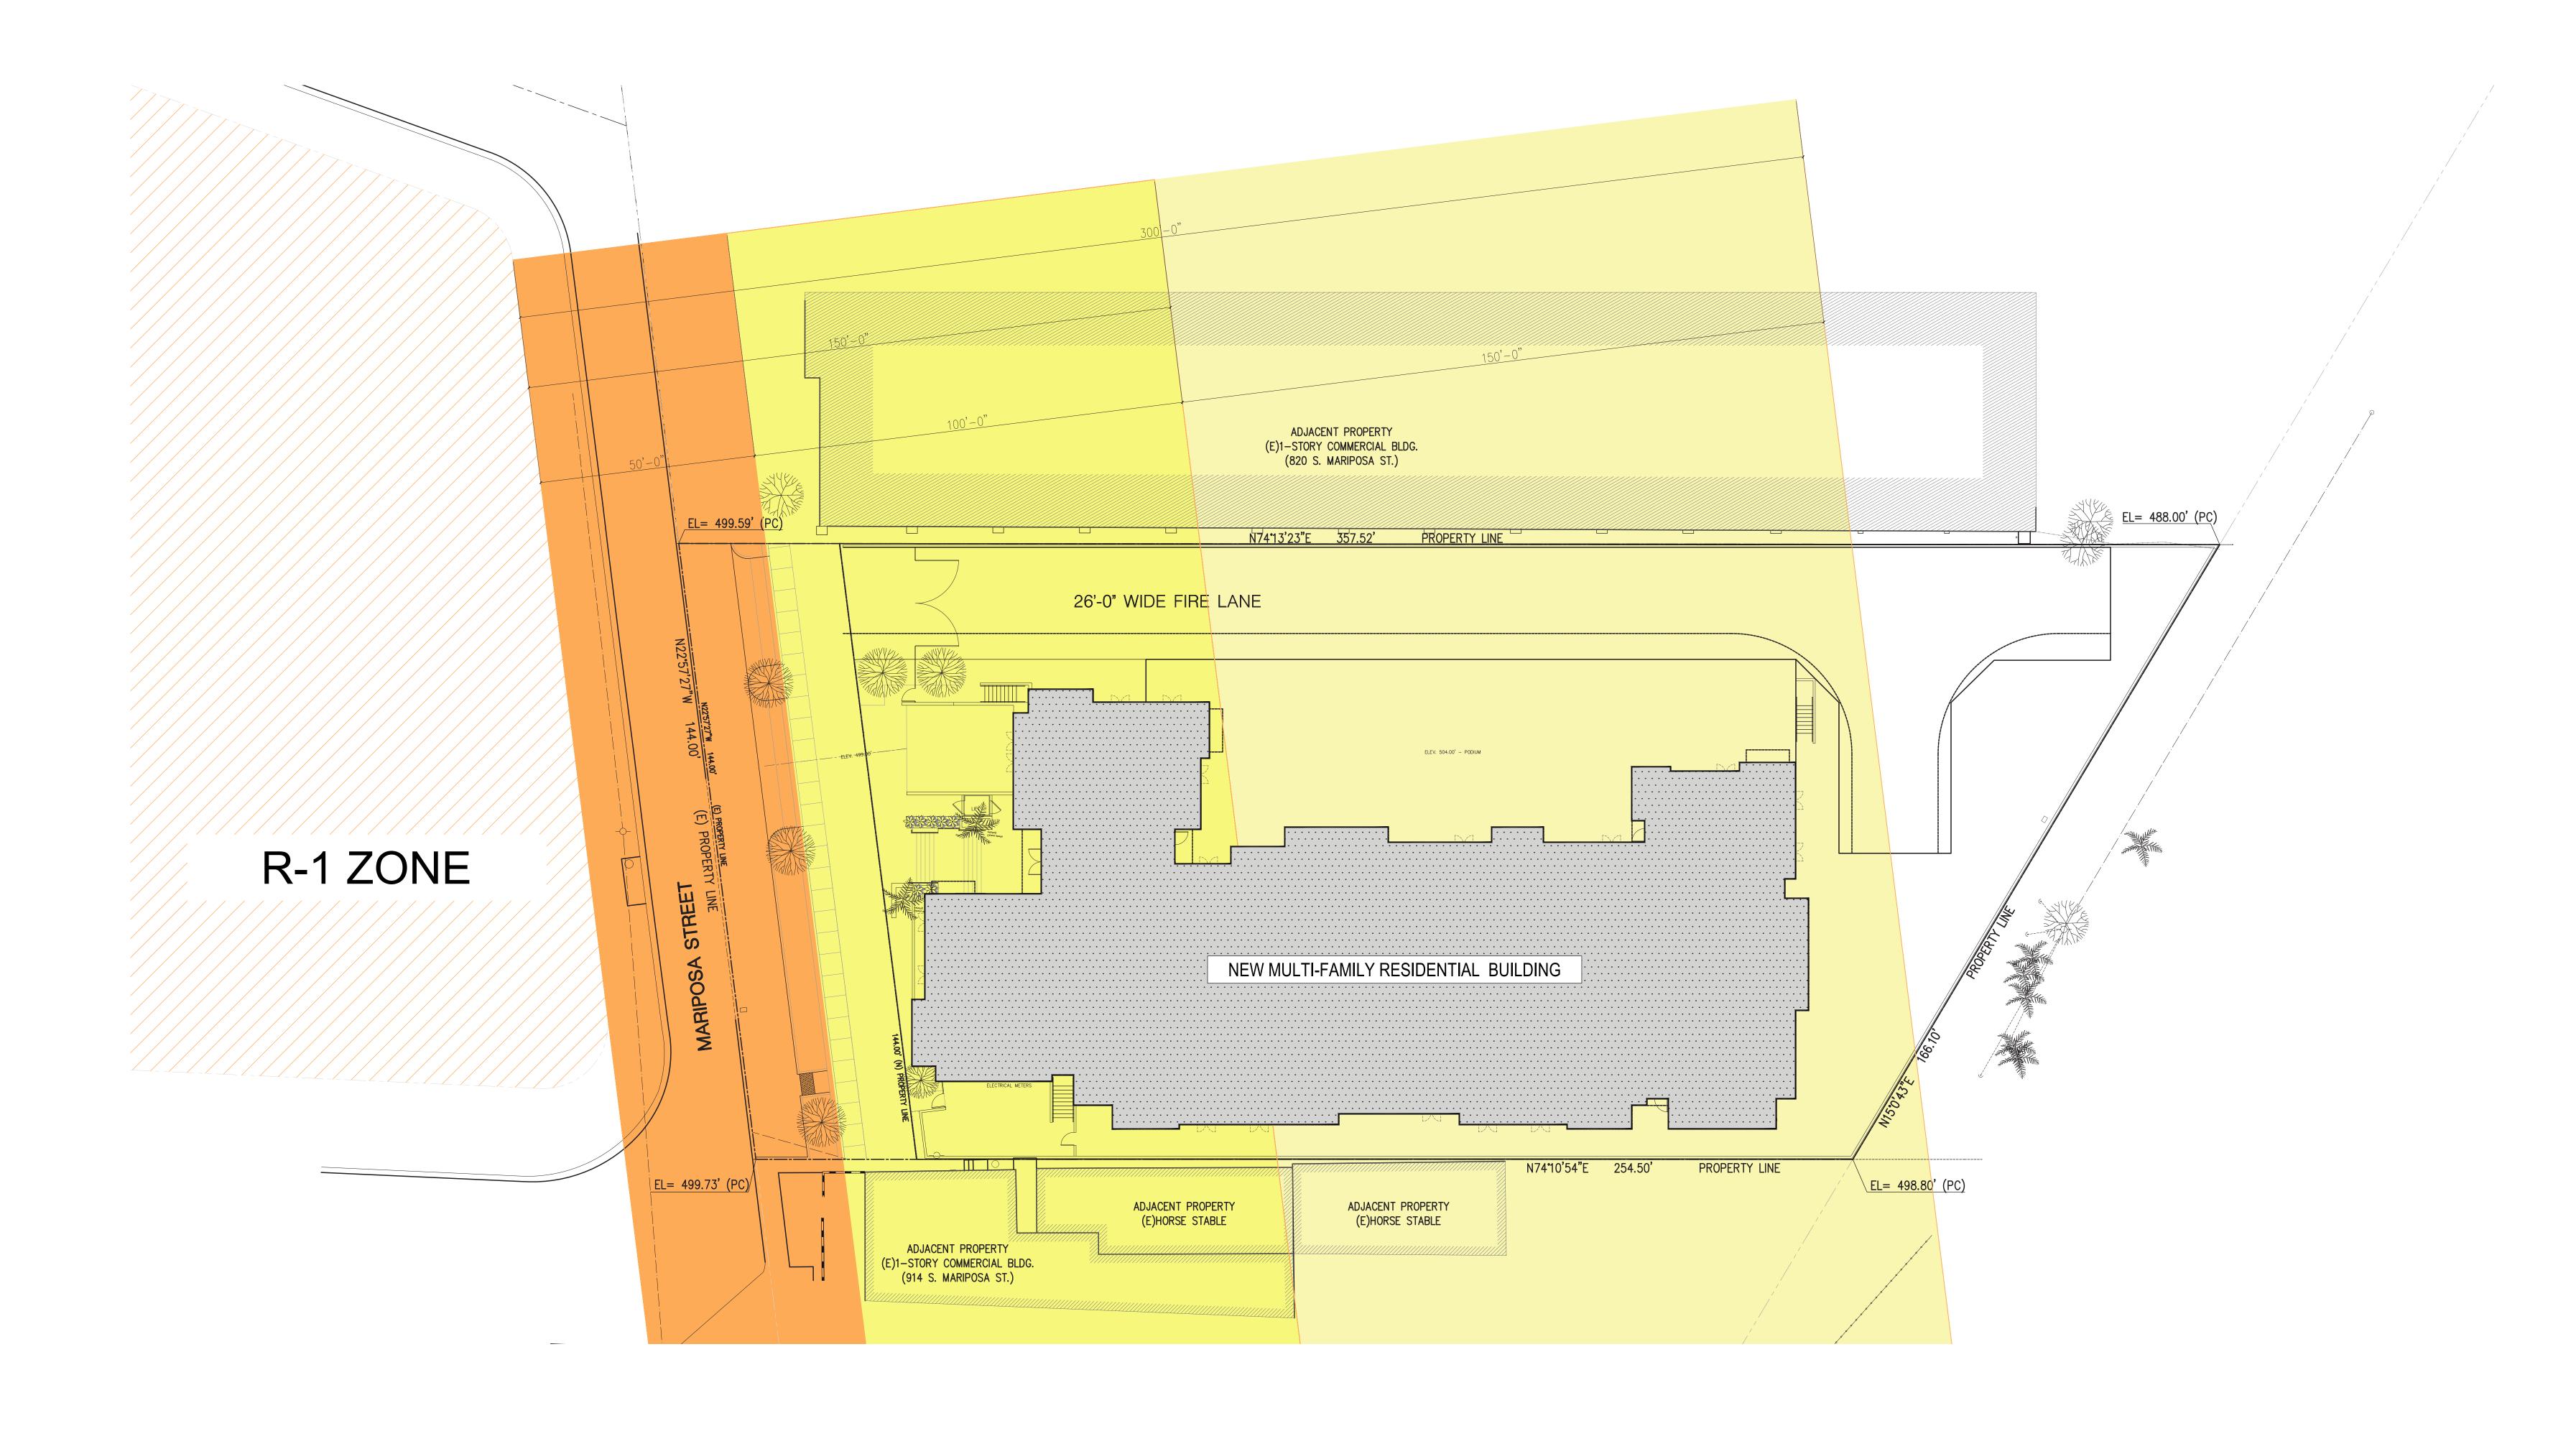


NOTE: DISTANCES FROM CLOSEST RESIDENTIAL LOT LINE PER BMC 10-1-806.A.1.

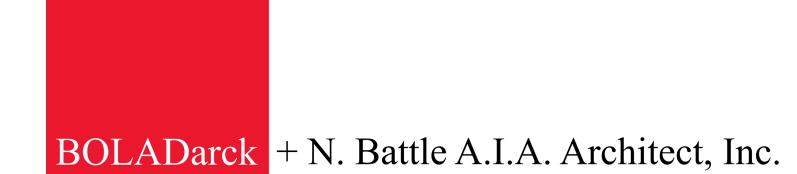


408 S. Pasadena Ave. #6, Pasadena CA 91105 - 626.381.9677


SUPPLEMENTAL DIAGRAM #1

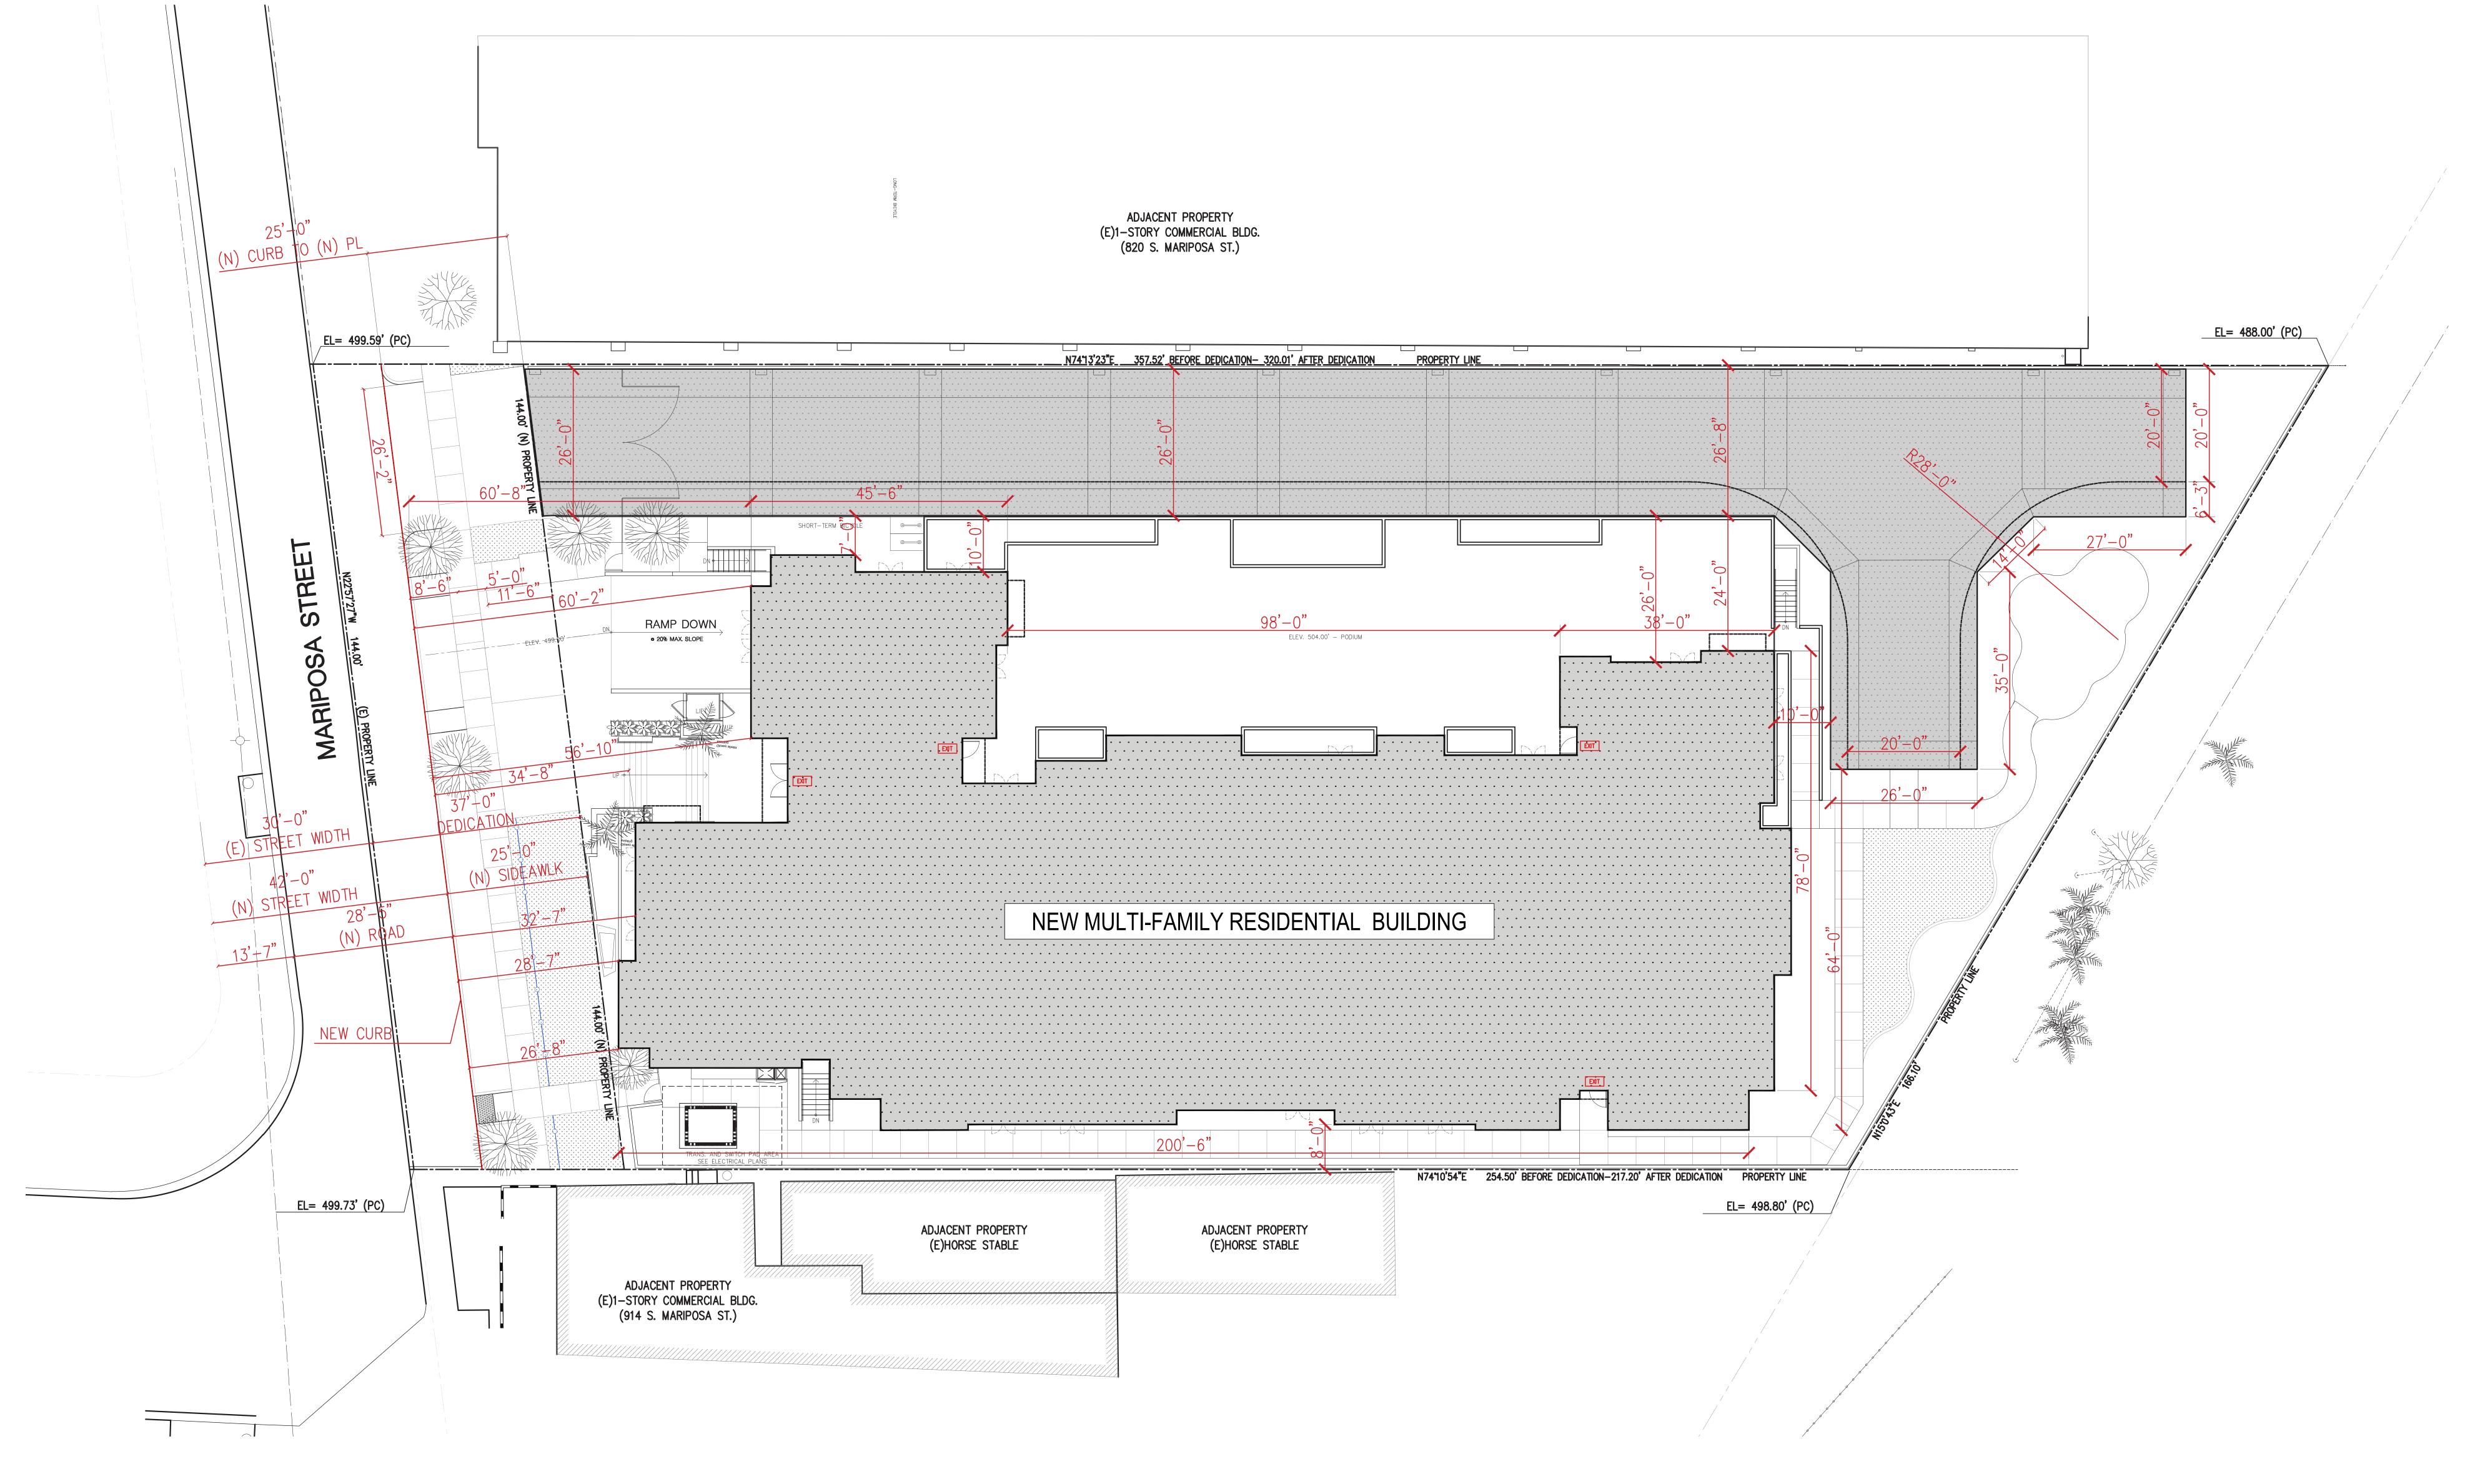

SCALE: N.T.S.


SUPPLEMENTAL DIAGRAM #2

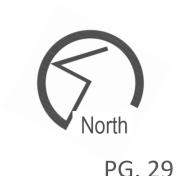

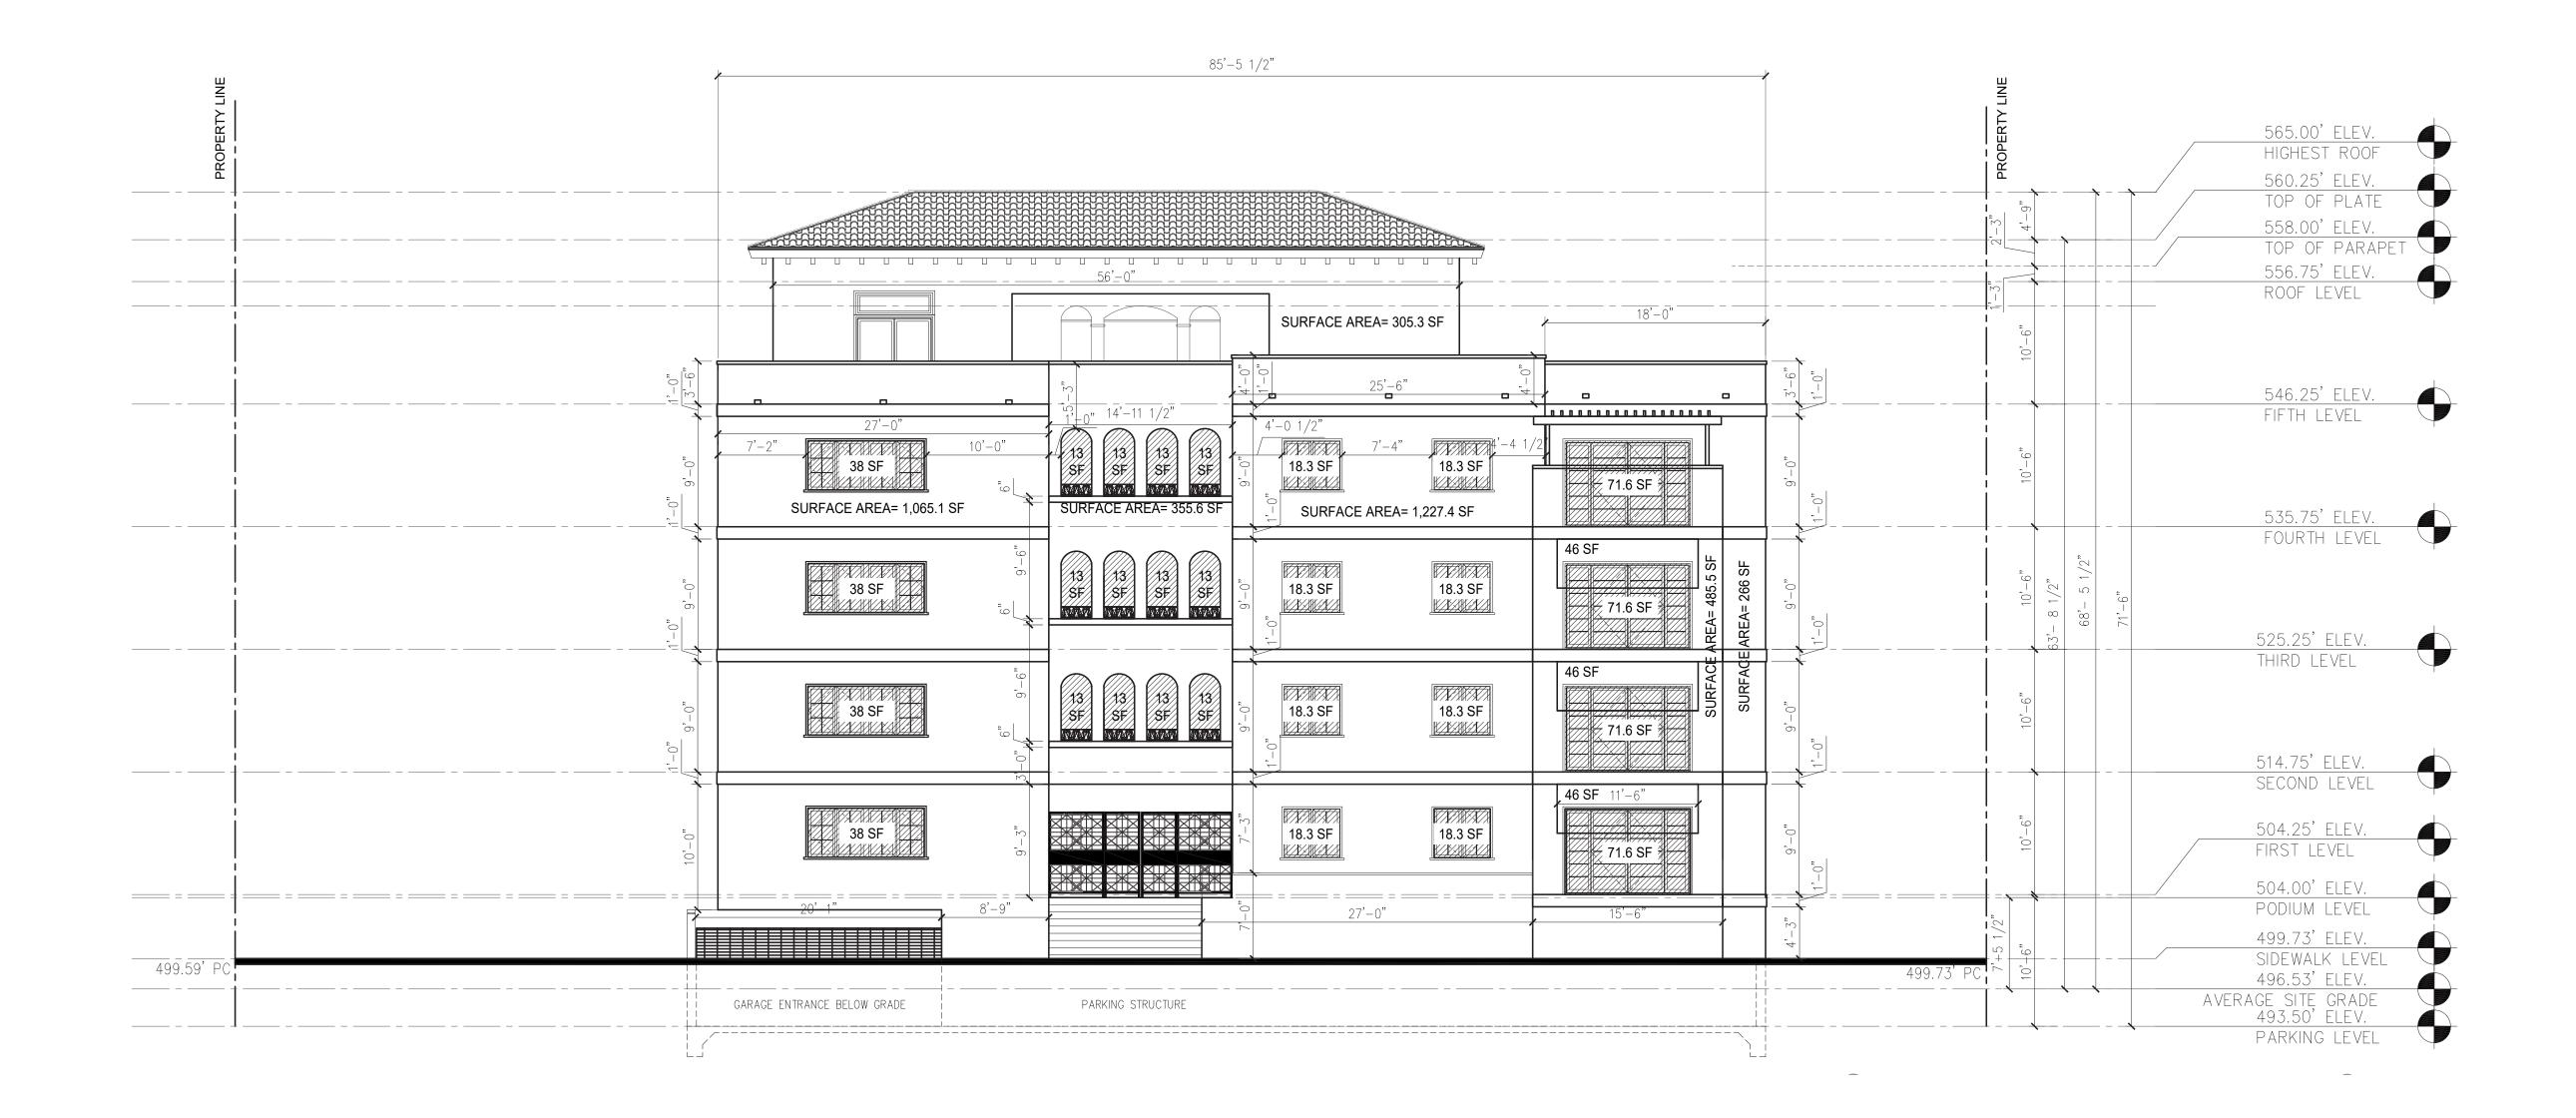

NOTES:

- 1. Windows shall be recessed by a minimum of 3 inches from the facade.
- 2. At least 25 percent of the ground floor area (height and width) of each street-facing facade shall be windows or entrance doors. Those buildings on lots with 75 feet or less of street frontage which are built to the street property line shall have a minimum 35 percent of the building facade on the ground floor devoted to window treatment.
- 3. Street-facing facades shall incorporate glass providing views into the lobby, common area, or amenity areas. The minimum transparency is as follows:
- a. Ground floor: 15%
- b. Overall Facade: 10%
- 4. Ground floor transparency is measured as the percentage of building frontage that consists of transparent openings between a height of 2 feet and 10 feet above sidewalk elevation.
- The following requirements apply to all awnings, if used:

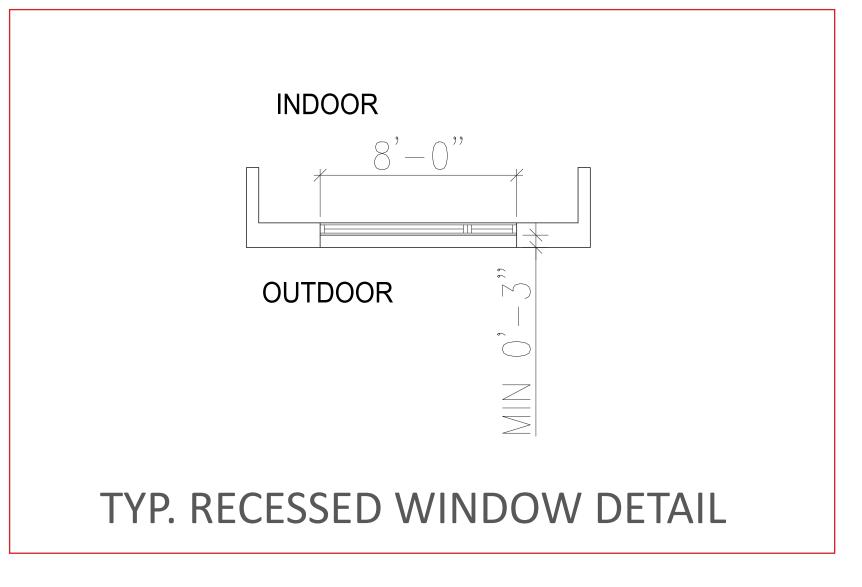

SCALE: 1/8" = 1'-0"

SUPPLEMENTAL DIAGRAM #3



BOLADarck + N. Battle A.I.A. Architect, Inc.




LEGEND

- 1. Community open space area on Podium with BBQ Island, Shade Structure, Fire tables, Dining furniture for small social events and group gatherings. See sheet Enlargement L-2.
- 2. Water Garden with water fountain, specimen tree with circular bench seating, and adirondack
- 3. Putting green.
- Proposed wall, pilaster, gate or fence, per Wall & Fence Plan L-3.
- Enhanced stamped paving at main project entry.
- 6. Proposed tree, per Planting Plan L-4.
- 5' wide community natural colored concrete sidewalk, with light top-cast finish and saw-cut joints.
- 8. Vehicular ramp for parking parking area, per Civil plans.
- ADA lift per local codes.
- 10. Transformer & switch pad area by others.
- Private patio / homeowner maintained.
- 12. Common area landscape, builder installed and HOA maintained.
- 13. Underground utility device by others.
- 14. Property line.
- 15. Public street R.O.W.
- Proposed public street sidewalk, per Civil plans.
- 17. Pedestrian metal gates (ADA compliant).
- 18. Proposed street parkway.
- 19. Proposed decomposed granite equestrian trail.
- 20. Natural Gas Fire pit with raised planter and built-in bench.
- 21. Large Umbrella area with seating.
- 22. Potential public Art feature, per separate future submittal.








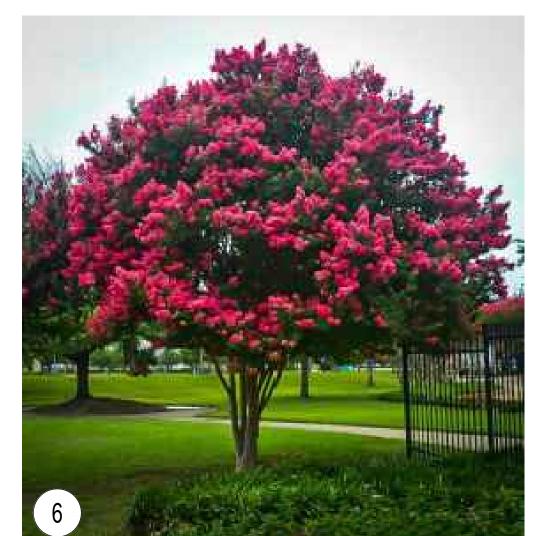




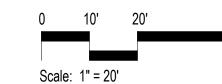


Butterfly Gardens LLC



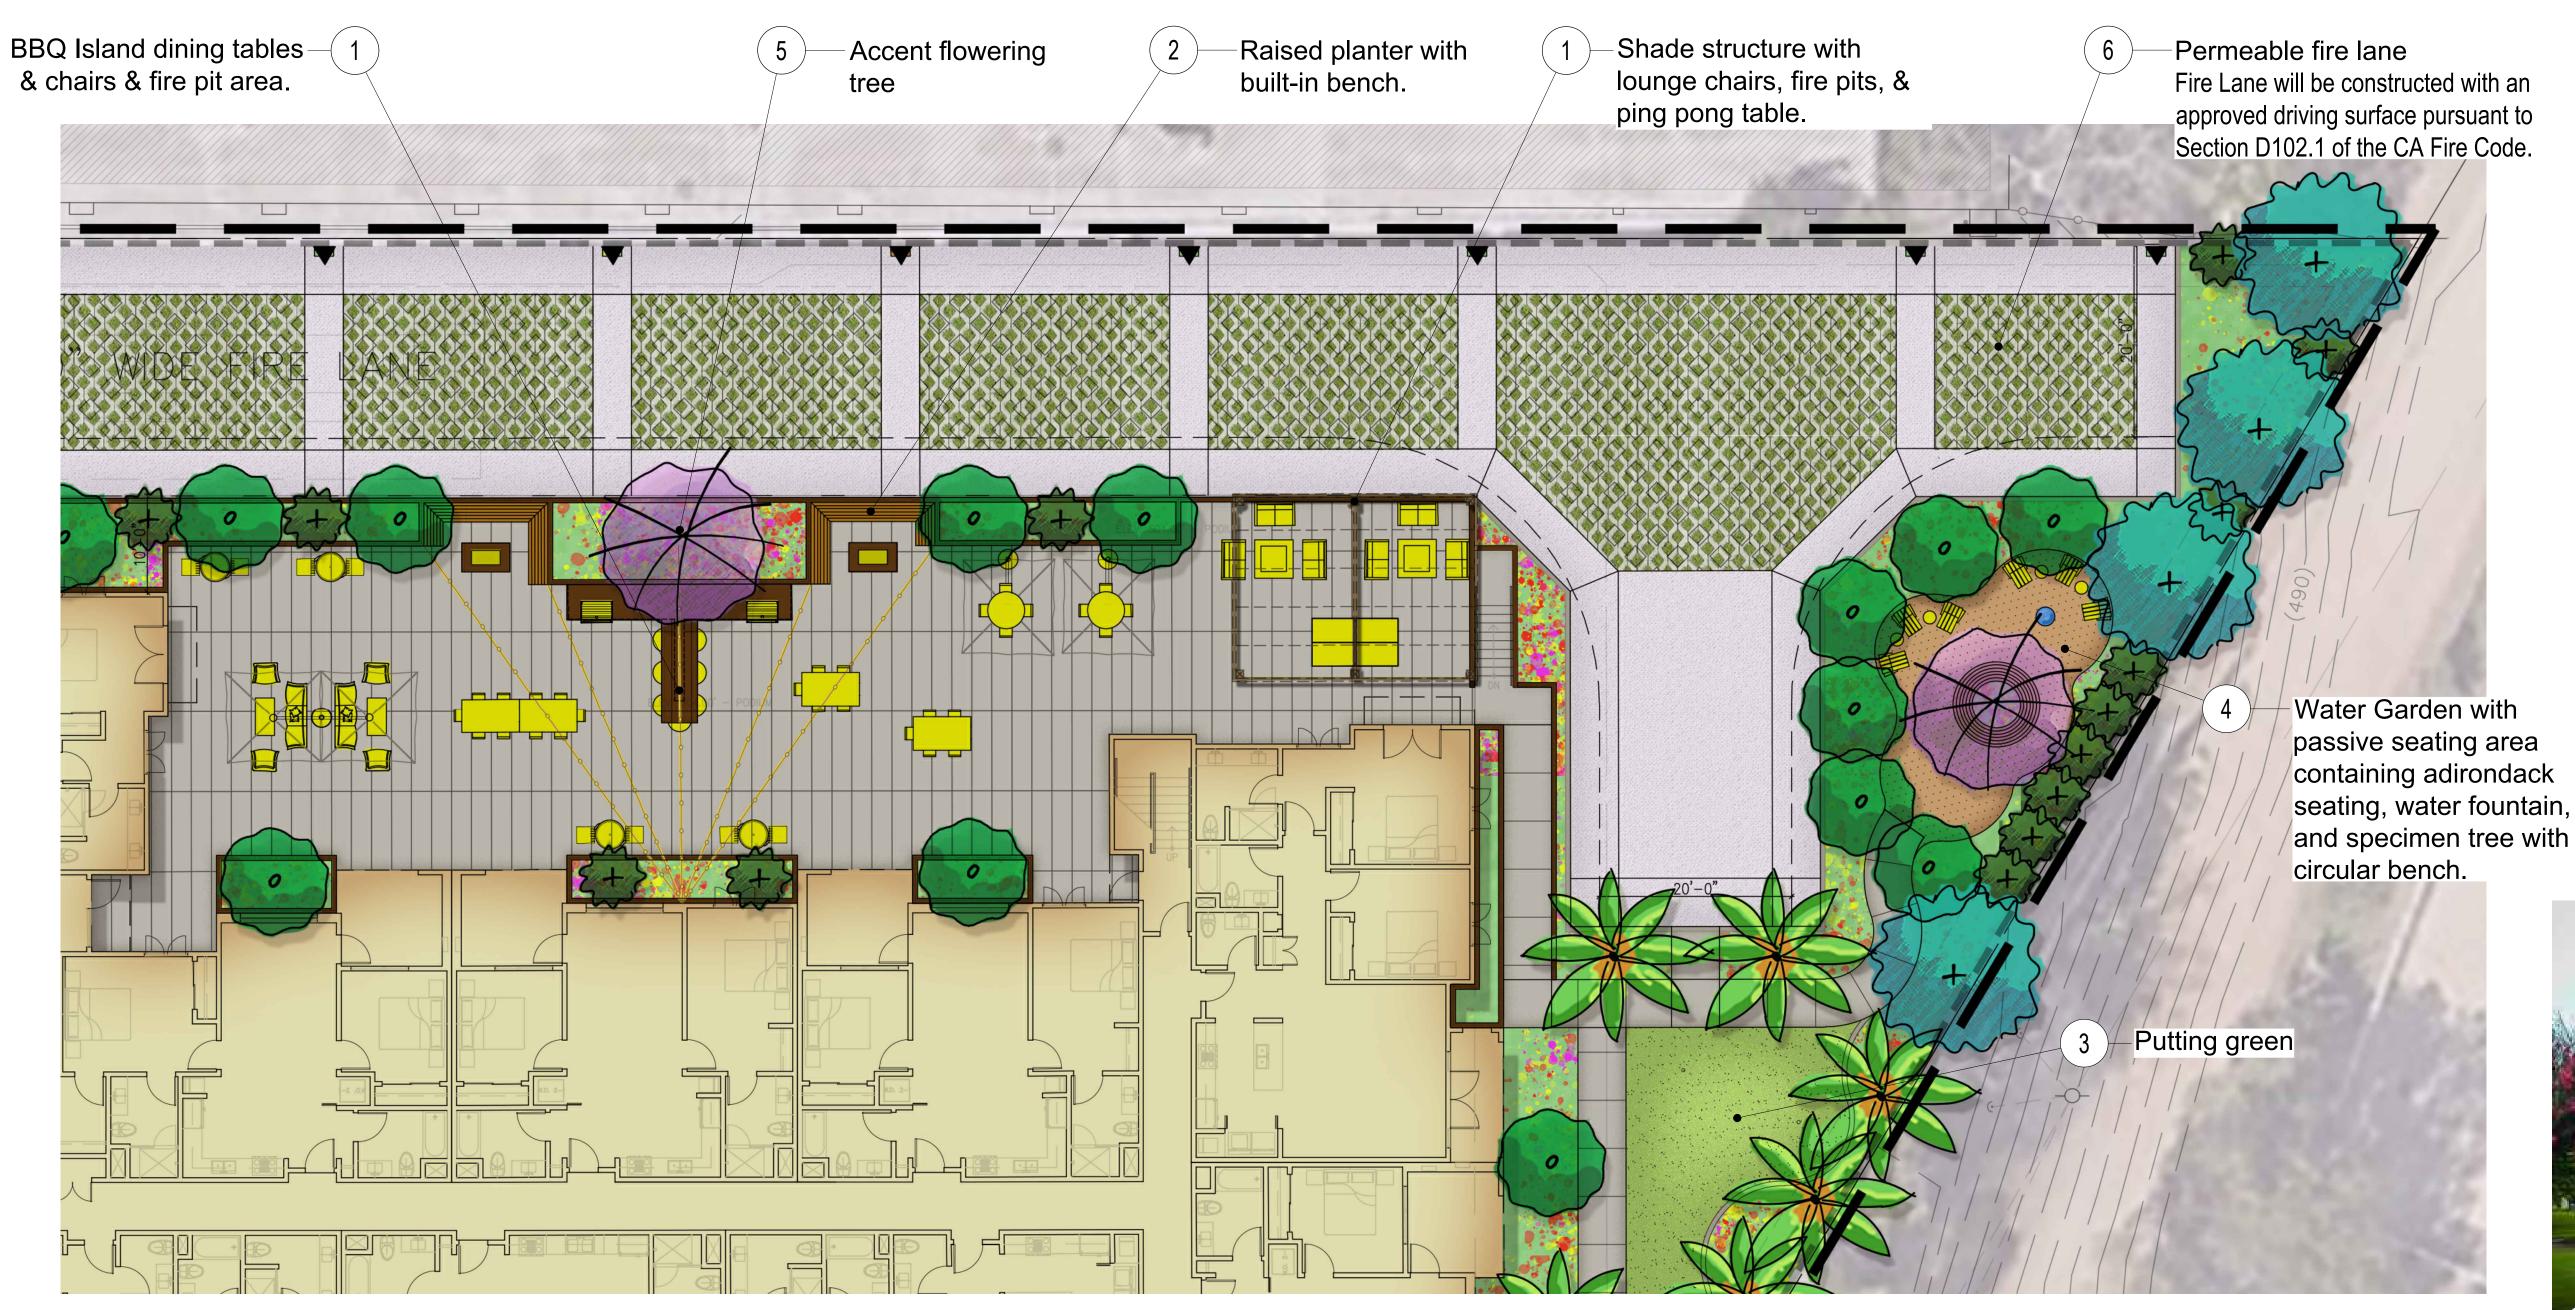






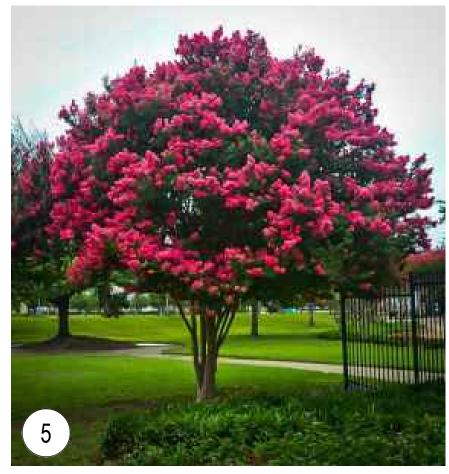



ENLARGEMENT A: COMMUNITY OPEN SPACE AREA



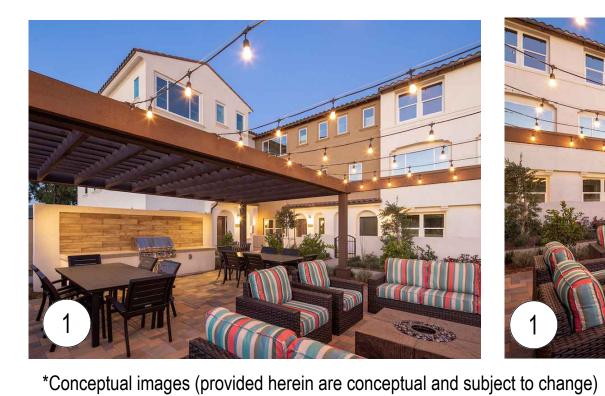











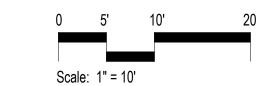



Schematic Enlargement Plan


Butterfly Gardens LLC

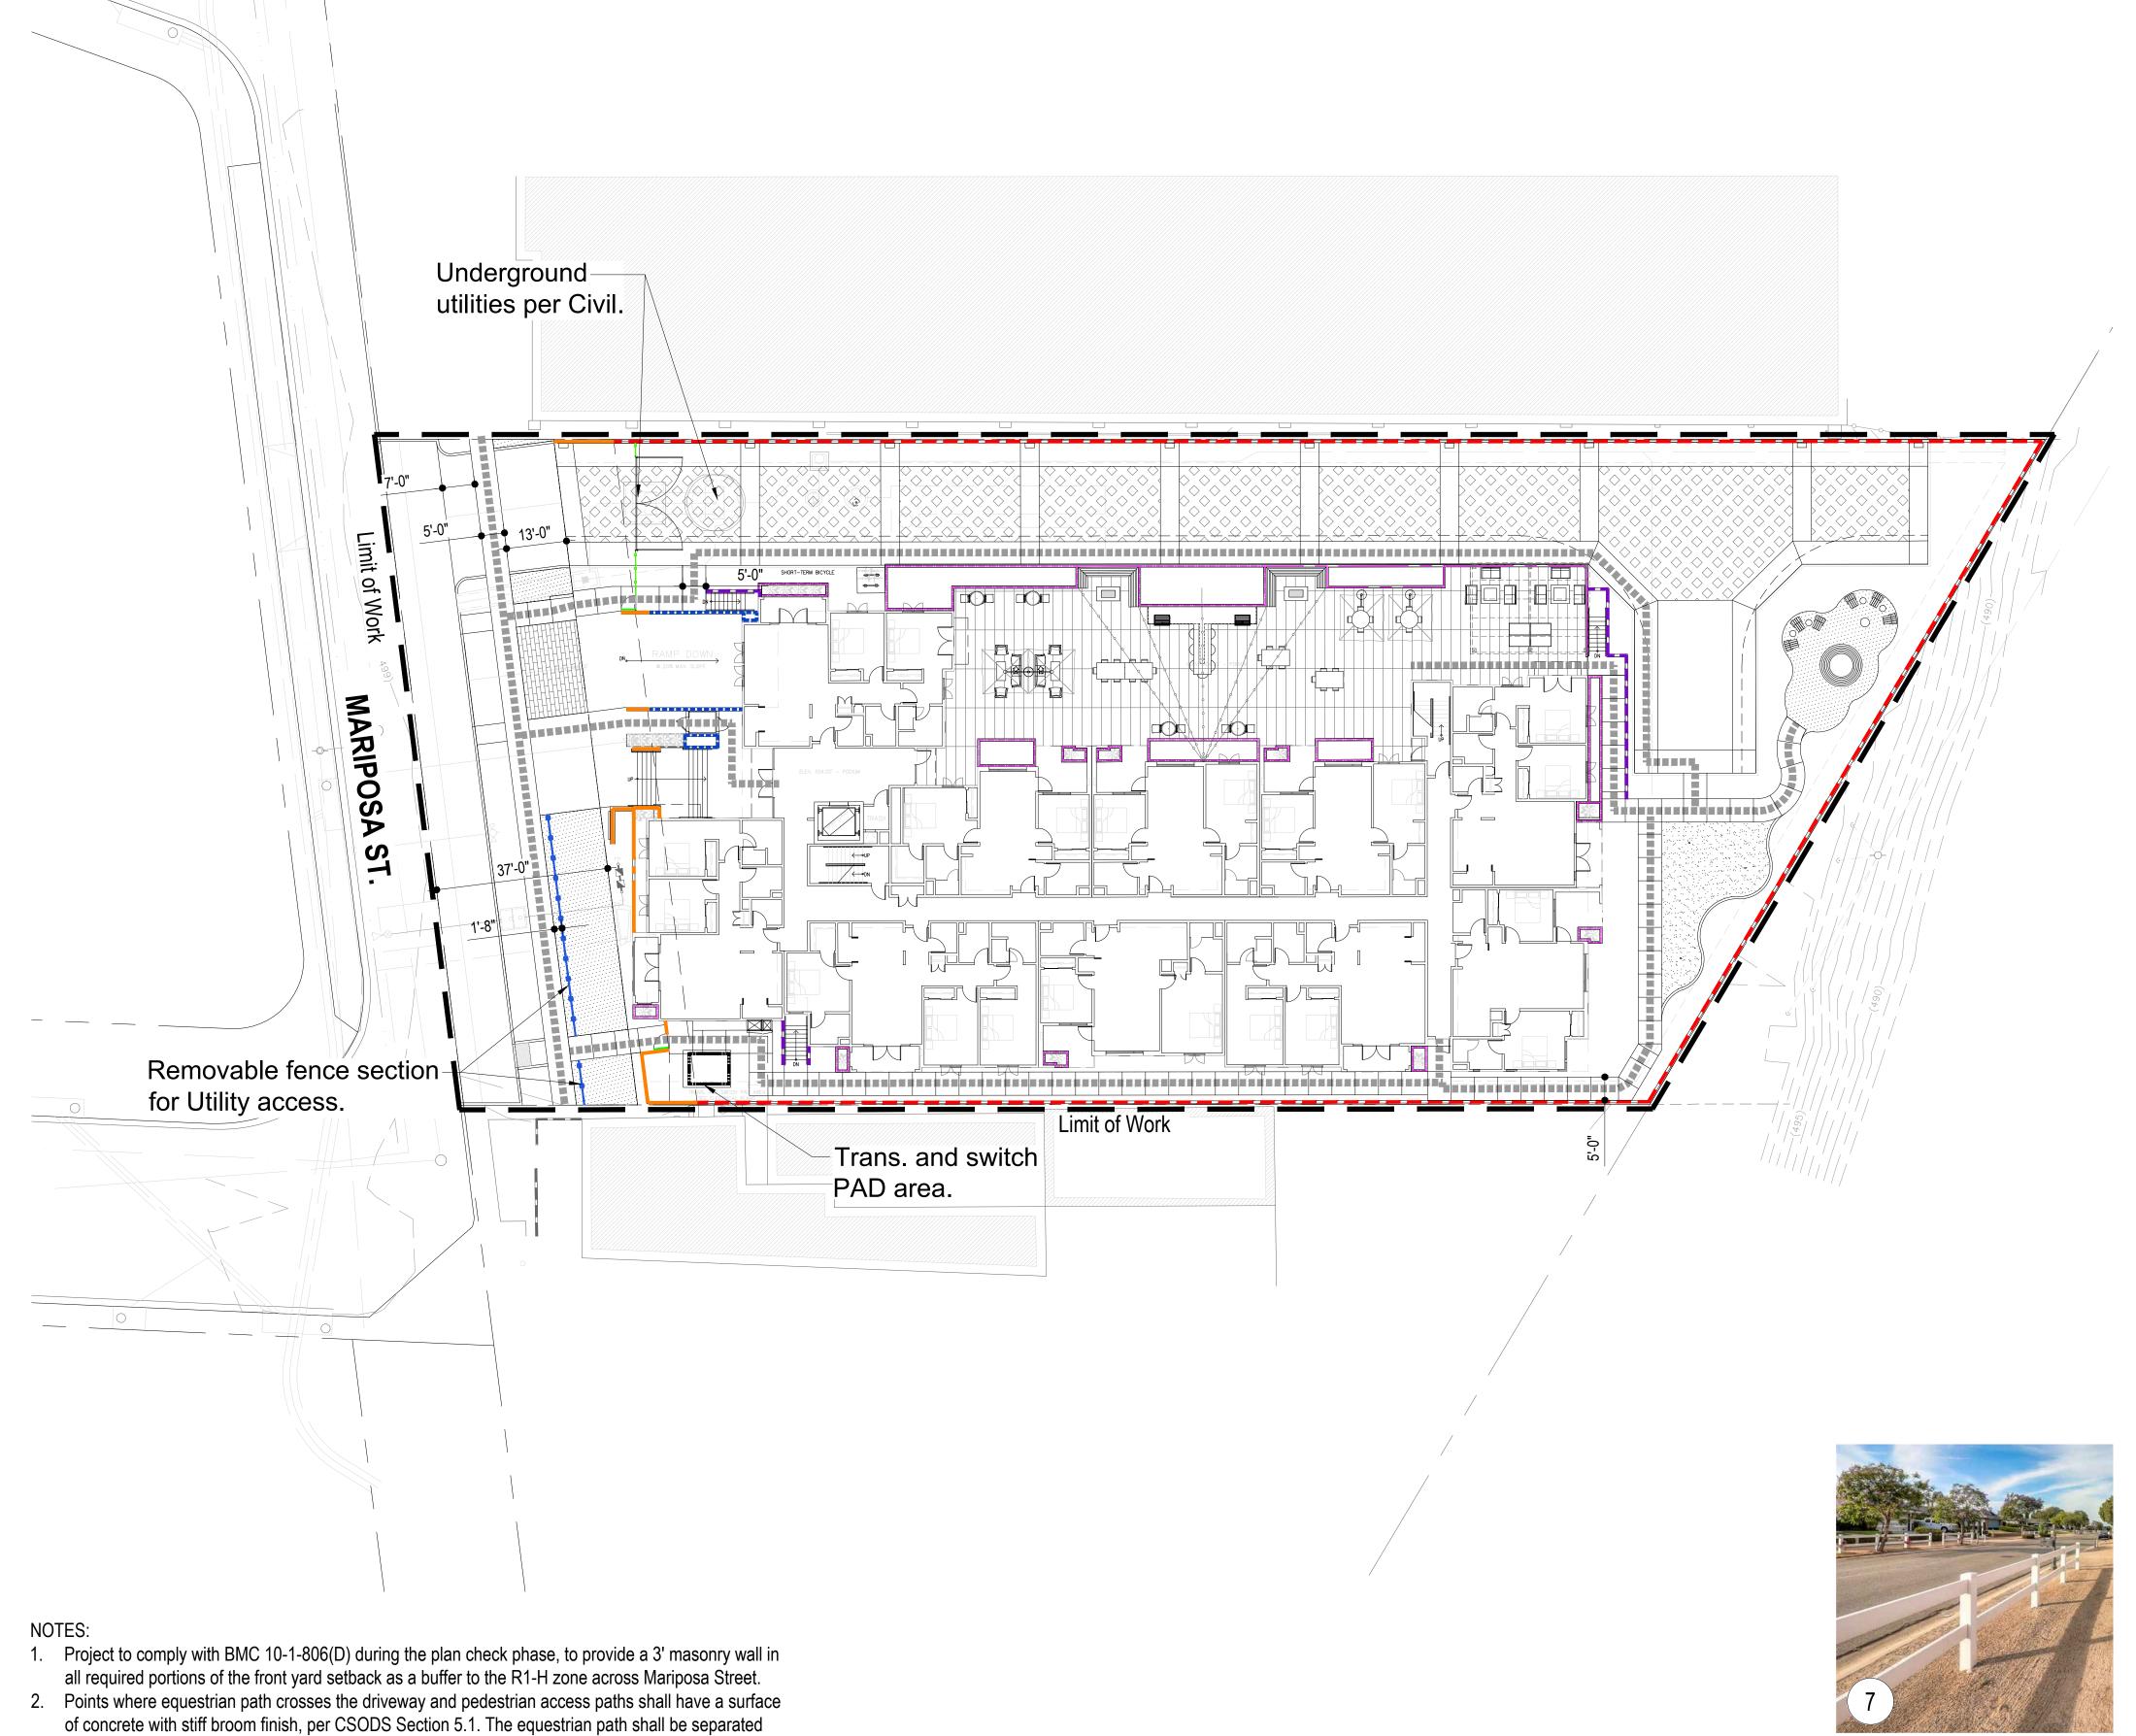



from the Pedestrian Zone of the Sidewalk area by a 4-foot lodgepole fence, per CSODS Section 5.1.

WALL LEGEND

8'-0" High stone veneer finished wall, with flat stone cap. 7'-0" High stone veneer finished wall, with flat stone cap. -- - 4'-0" High stone veneer finished wall, with flat stone cap. 42" High smooth stucco over CMU wall, with flat stucco cap. 4'-0" High smooth stucco over CMU wall, with flat stucco cap. 4'-0" High T.S. fence (black color). 4'-0" High equestrian rail fence (wood). 4'-0" High vehicular entry gate. 6'-6" High (18" sq.) stucco over CMU pilaster, with stucco cap. 4'-0" High metal gates. ADA Path of Travel

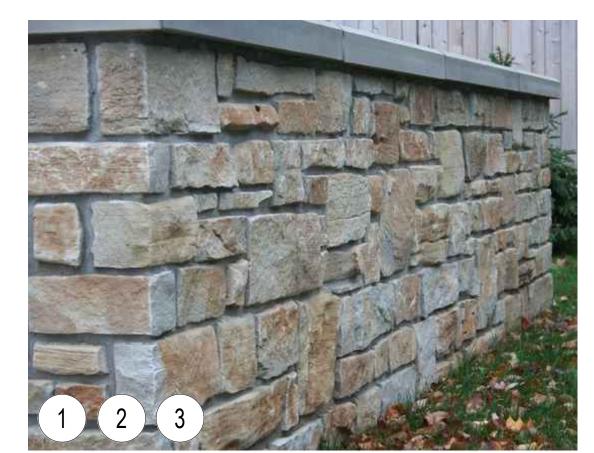

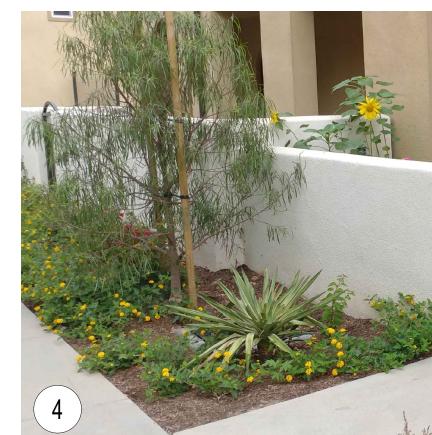

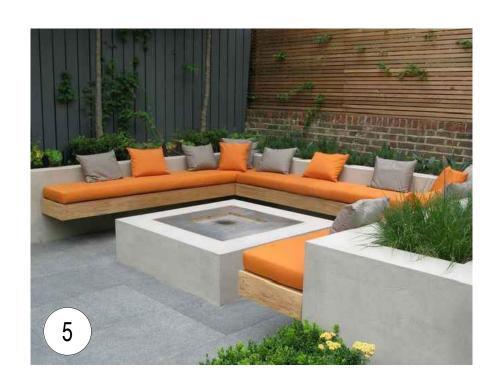











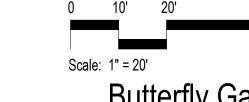

Schematic Walls & Fence Plan





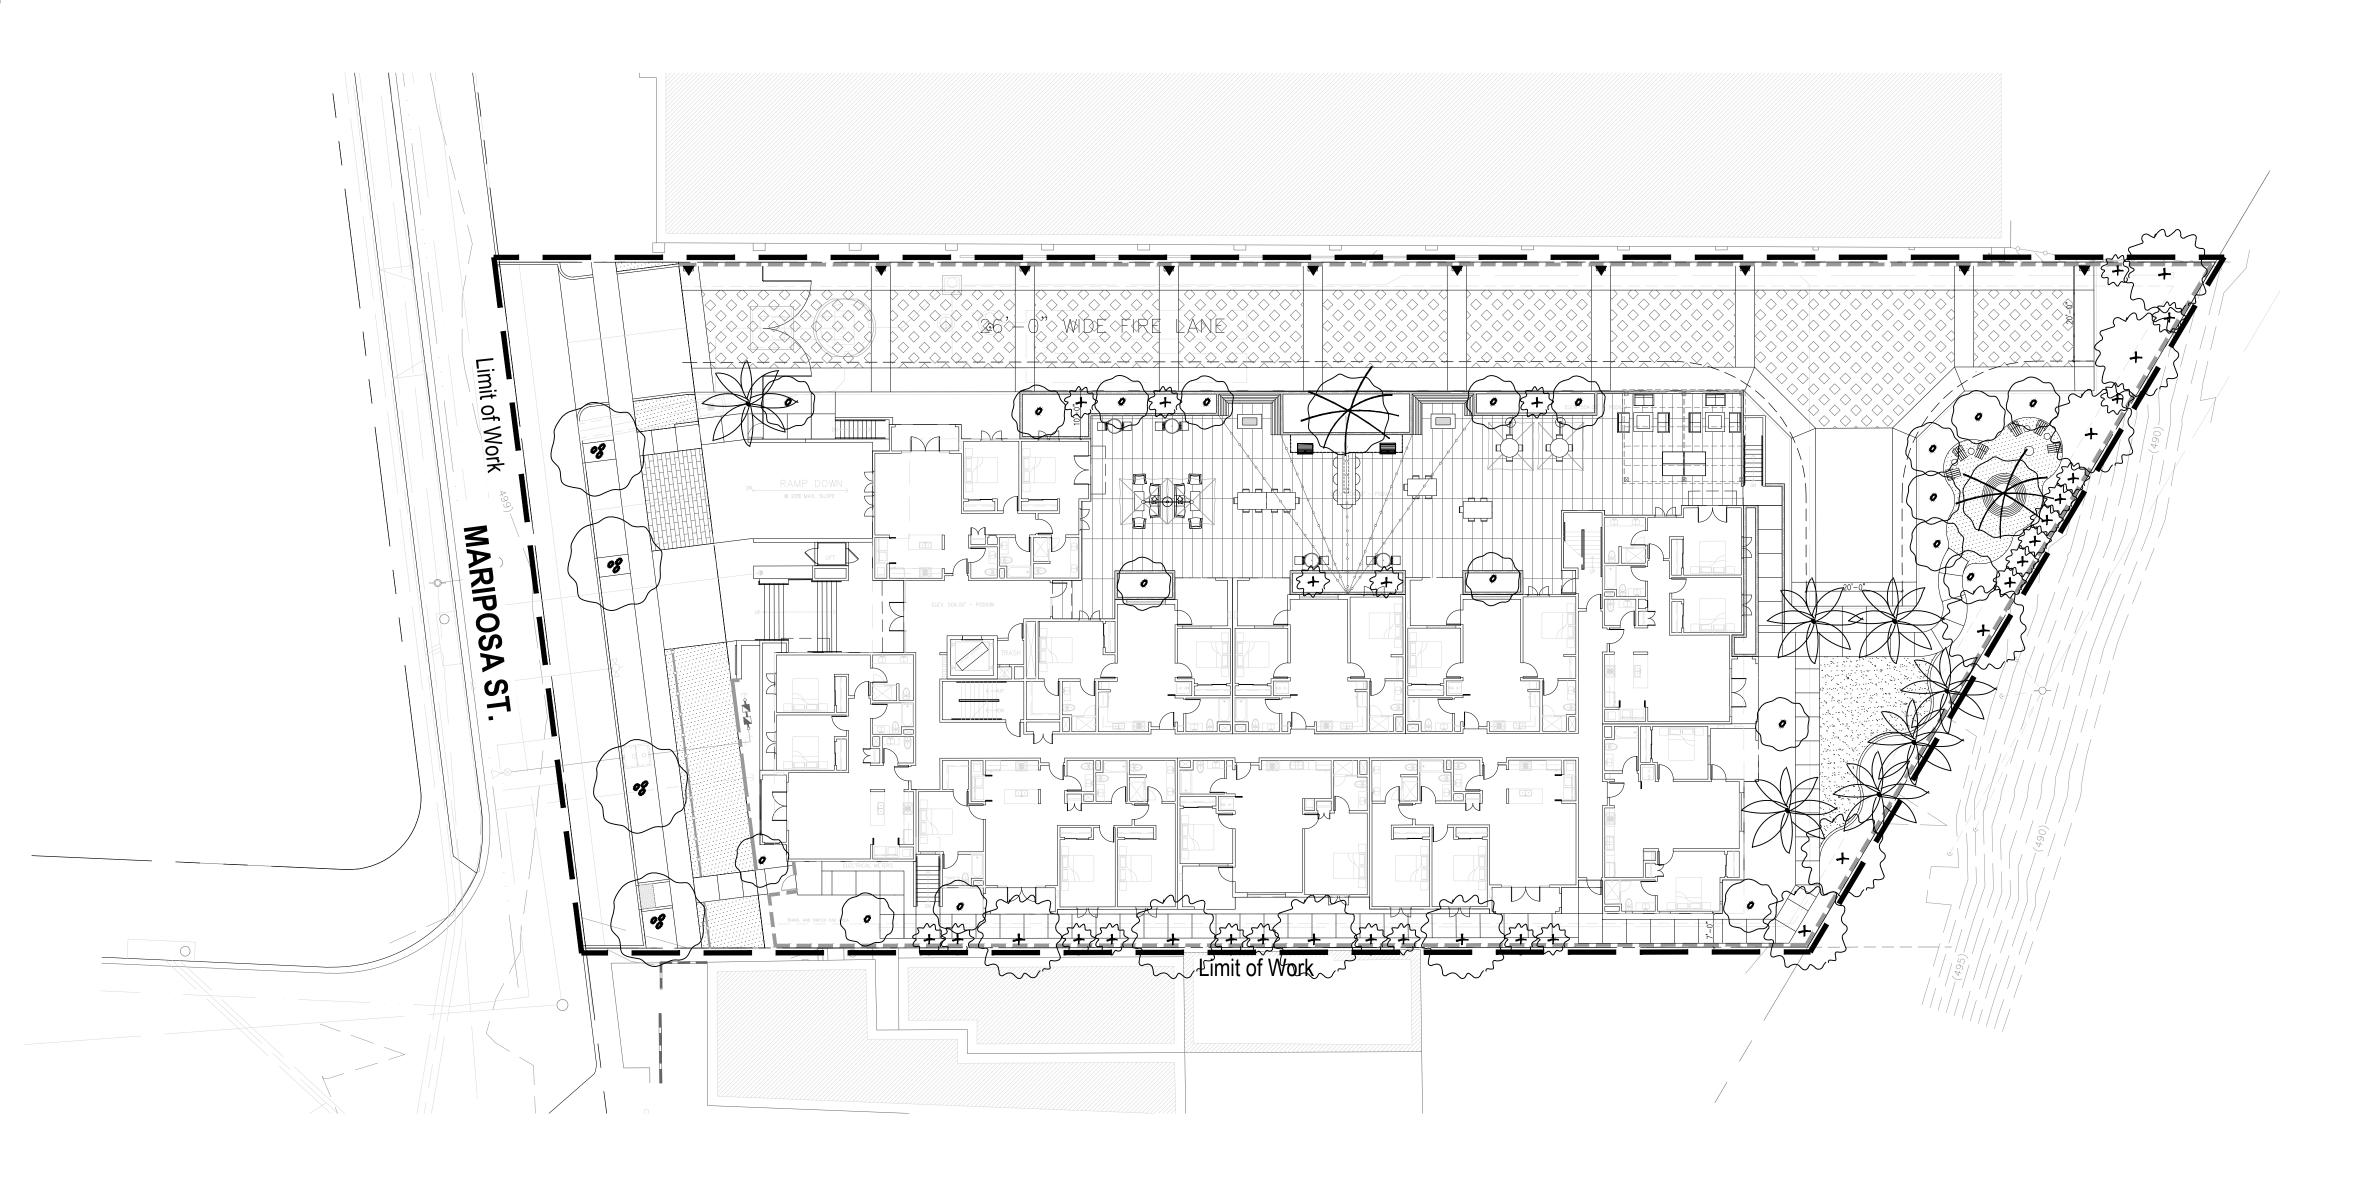

CITY OF BURBANK MUNICIPAL CODE:

- Refer to BMC 10-1-624 (H), (K), (L), and (N).
- Refer to BMC M-1 light industrial zone, established to provide for and encourage the grouping together of light industrial uses capable of being operated under such standards as to location and appearance of buildings and treatment of land about them, that they will be unobtrusive and not detrimental to surrounding commercial or residential uses. (Ord. 487, 7-23-2002)

Preliminary Shrubs Quanitity:

Overall Landscape Area: 23,605 sf

- Shrubs (15 gallon, 20% of SF Area @ 48" o.c. spacing) = 70 each
- Shrubs (5 gallon, 60% of SF Area @ 36" o.c. spacing) = 36 each
- Shrubs (1 gallon, 20% of SF Area @ 30" o.c. spacing) = 15 each

- 1. Irrigation (including spray and/or drip) will be provided, in the Construction Document phase, and to be installed per local California water regulations (AB1881).
- 2. Transformers, back-flow preventers & other above-ground utilities to be screened with landscape as permitted per local codes & regulations.
- 3. Landscape lighting (landscape up-lights, path lights/bollards, etc.) to be coordinated with Electrical Engineer in future phase.
- 4. The plant palette listed provides a list of plant material to select from when preparing final landscape construction documents for this project. However, substitutions may be required due to availability, soils tests, or other conditions.
- 5. All trees within 5' of hardscape to be installed with deep root barriers.


Schematic Planting Plan

PLANTING LEGEND

Symbol	Type/Form	Suggestions	Trunk	Size	WUCOLS (R3)	Qty
- 7	TREES	Botanical Name (Common Name)				,
	Palm	Syagrus romanzoffiana (Queen Palm)	Single	36" Box	Mod.	7
	Focal	Magnolia grandiflora 'Little Gem (Southern Magnolia)	Single	36" Box	Mod.	2
•8	Canopy Deciduous	Sycamore racemosa (California Sycamore)	Single	36" Box	Mod.	4
+	Street / Screen	Tristania conferta (Brisbane Box)	Single	24" Box	Mod.	10
	Evergreen Flowering	Arbutus u. 'Marina' (Marina Strawberry Tree) Geijera parvilflora (Australian Willow)	Single	36"/24" Box	Low Low	19
{ + }	Columnar	Cupressus sempervirens (Italian Cypress) Podocarpus gracillior (Fern Pine)	Single	24" Box	Low Mod.	24
	VINES				Total =	66
A	Screening	Bougainvillea 'Monka'		5 Gal	Low	10
		(Oo-La La Bougainvilla)			Total =	10

SHRUBS and GROUND COVER		WUCOLS (R3)
Anigozanthos	Kangaroo Paw	Low
Agave sp.	Agave	Low
Aloe sp.	Aloe	Low
Bougainvillea sp.	Bougainvillea	Low
Callistemon citrinus 'Little John'	Dwarf Bottlebrush	Low
Carex divulsa	Berkeley Sedges	Low
Carissa m. 'Green Carpet'	Dwarf Natal Plum	Low
Chamaerops humilis	Mediterranean Fan Palm	Low
Cordyline 'Pink Passion'	Pink Passion Dracaena Palm	Low
Dasylirion longissimum	Mexican Grass Tree	Low
Delosperma cooperi	Trailing Ice Plant	Low
Dianella revoluta 'Little Rev'	Little Rev™ Flax Lily	Low
Iris sp.	Iris	Low
Kalanchoe thyrsiflora	Flapjack Paddle Plant	Low
Lavandula stoechas 'Larkman Hazel'	Hazel™ Spanish Lavender	Low
Ligustrum japonicum "Texanum"	Japanese Privet	Low
Nassella pulchra	Purple Needlegrass	Low
Muhlenbergia rigens	Deer Grass	Low
Rhaphiolepis indica 'Clara"	India Hawthorn	Low
Rosmarinus p. 'Huntington Carpet'	Groundcover Rosemary	Low
Strelitzia reginae	Bird of Paradise	Low
Trachelospermum jasminoides	Star Jasmine	Low
Westringia sp.	Westringia	Low
Xylosma congestum 'Compact'	Compact Xylosma	Low
Yucca gloriosa	Spanish Dagger	Low
VINES & ESPALIERS		
Antigonon leptopus	Coral Vine	
Bougainvillea 'Monka' (Oo-La-La® Bougainvillea)	Bougainvillea	
Macfadyena unguis-cati	Cat's Claw Vine	
Pandorea jasminoides 'Lady Di'	White Bower Vine	

Star Jasmine

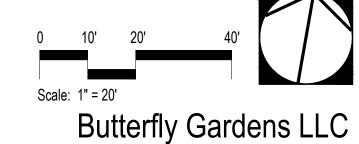



Trachelospermum jasminoides




2,746 sf 13,528 sf 1,520 sf

> PROGRAMMED O.S. LANDSCAPE = 2,746 sf (+5250 sf at Podium) TOTAL ON-SITE COMMON O.S. LANDSCAPE = 21,525 sf


ROOF TOP= 5,532.1 sf

TOTAL PROVIDED COMMON O. S.= 27,057.1 sf

Schematic Open Space Exhibit

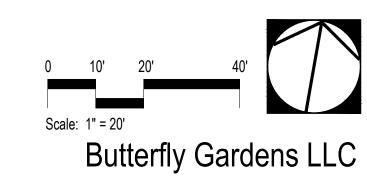



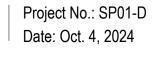






PERMEABLE AREA SCHEDULE

PERMEABLE LANDSCAPE AREAS Takeoff: 10,111 sf


SETBACK PERMEABLE LANDSCAPE AREAS


Takeoff: 1,569 sf


Schematic Permeable Area Exhibit

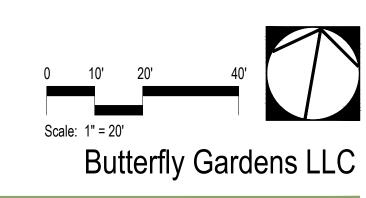




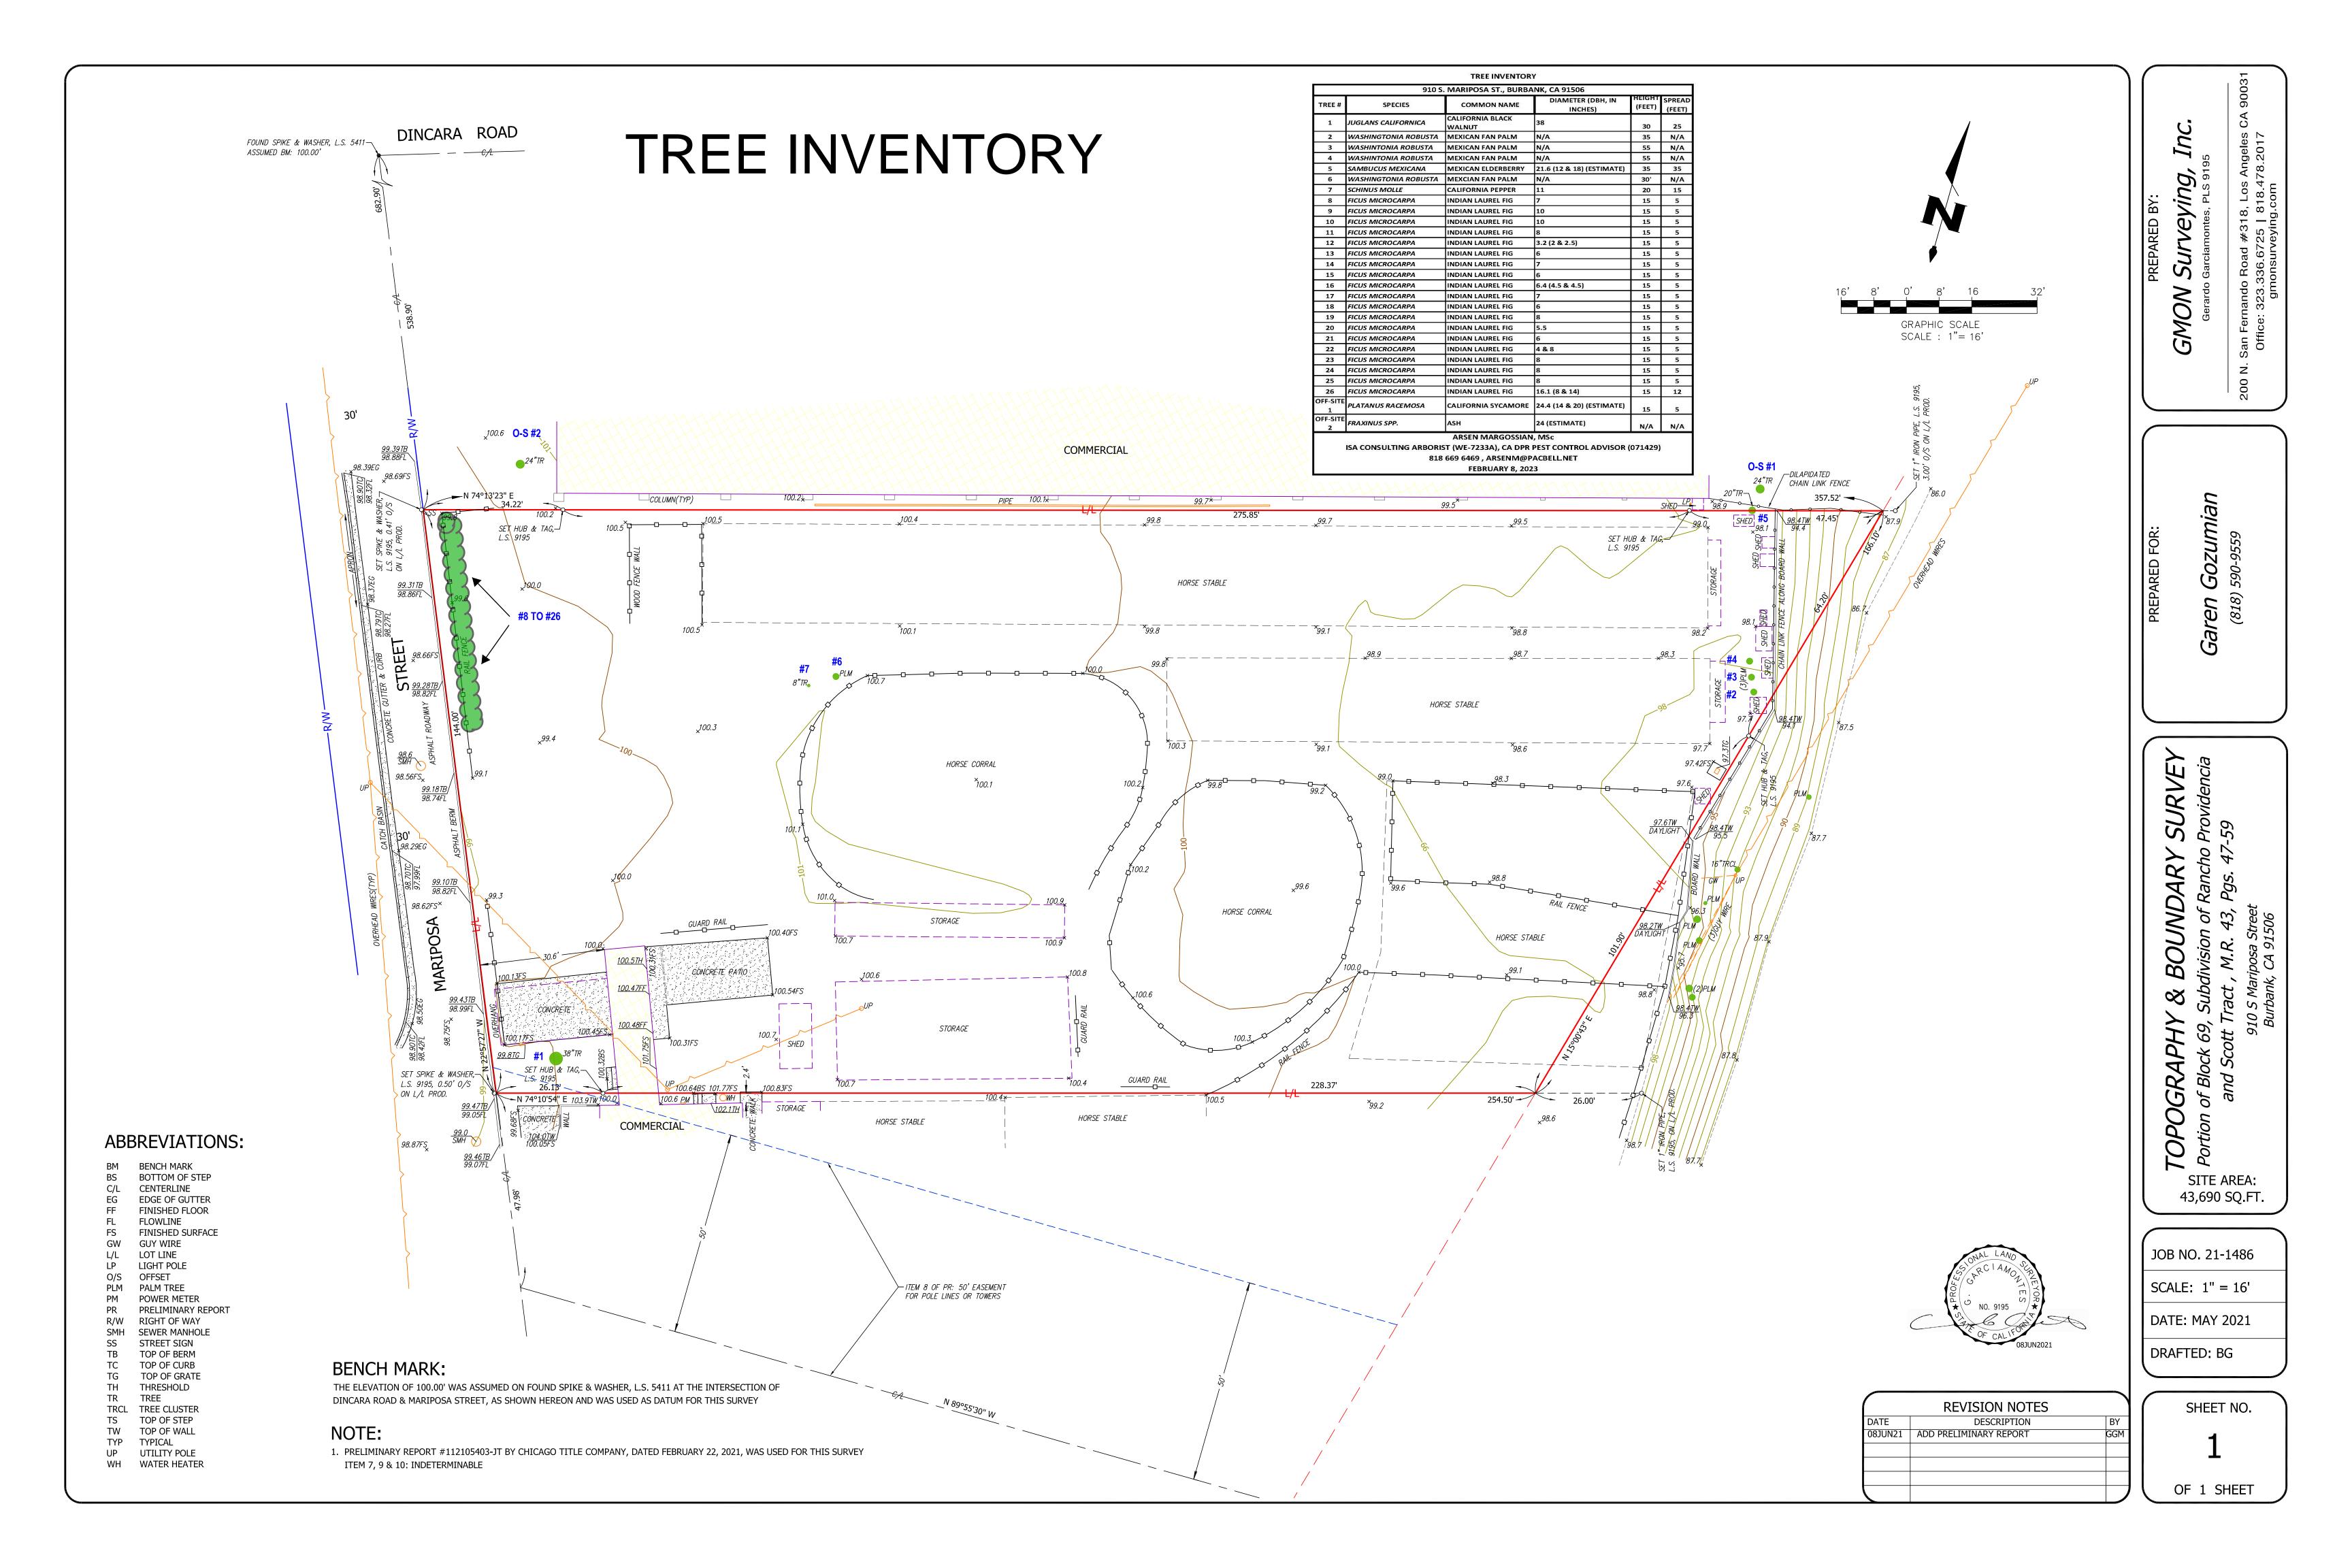


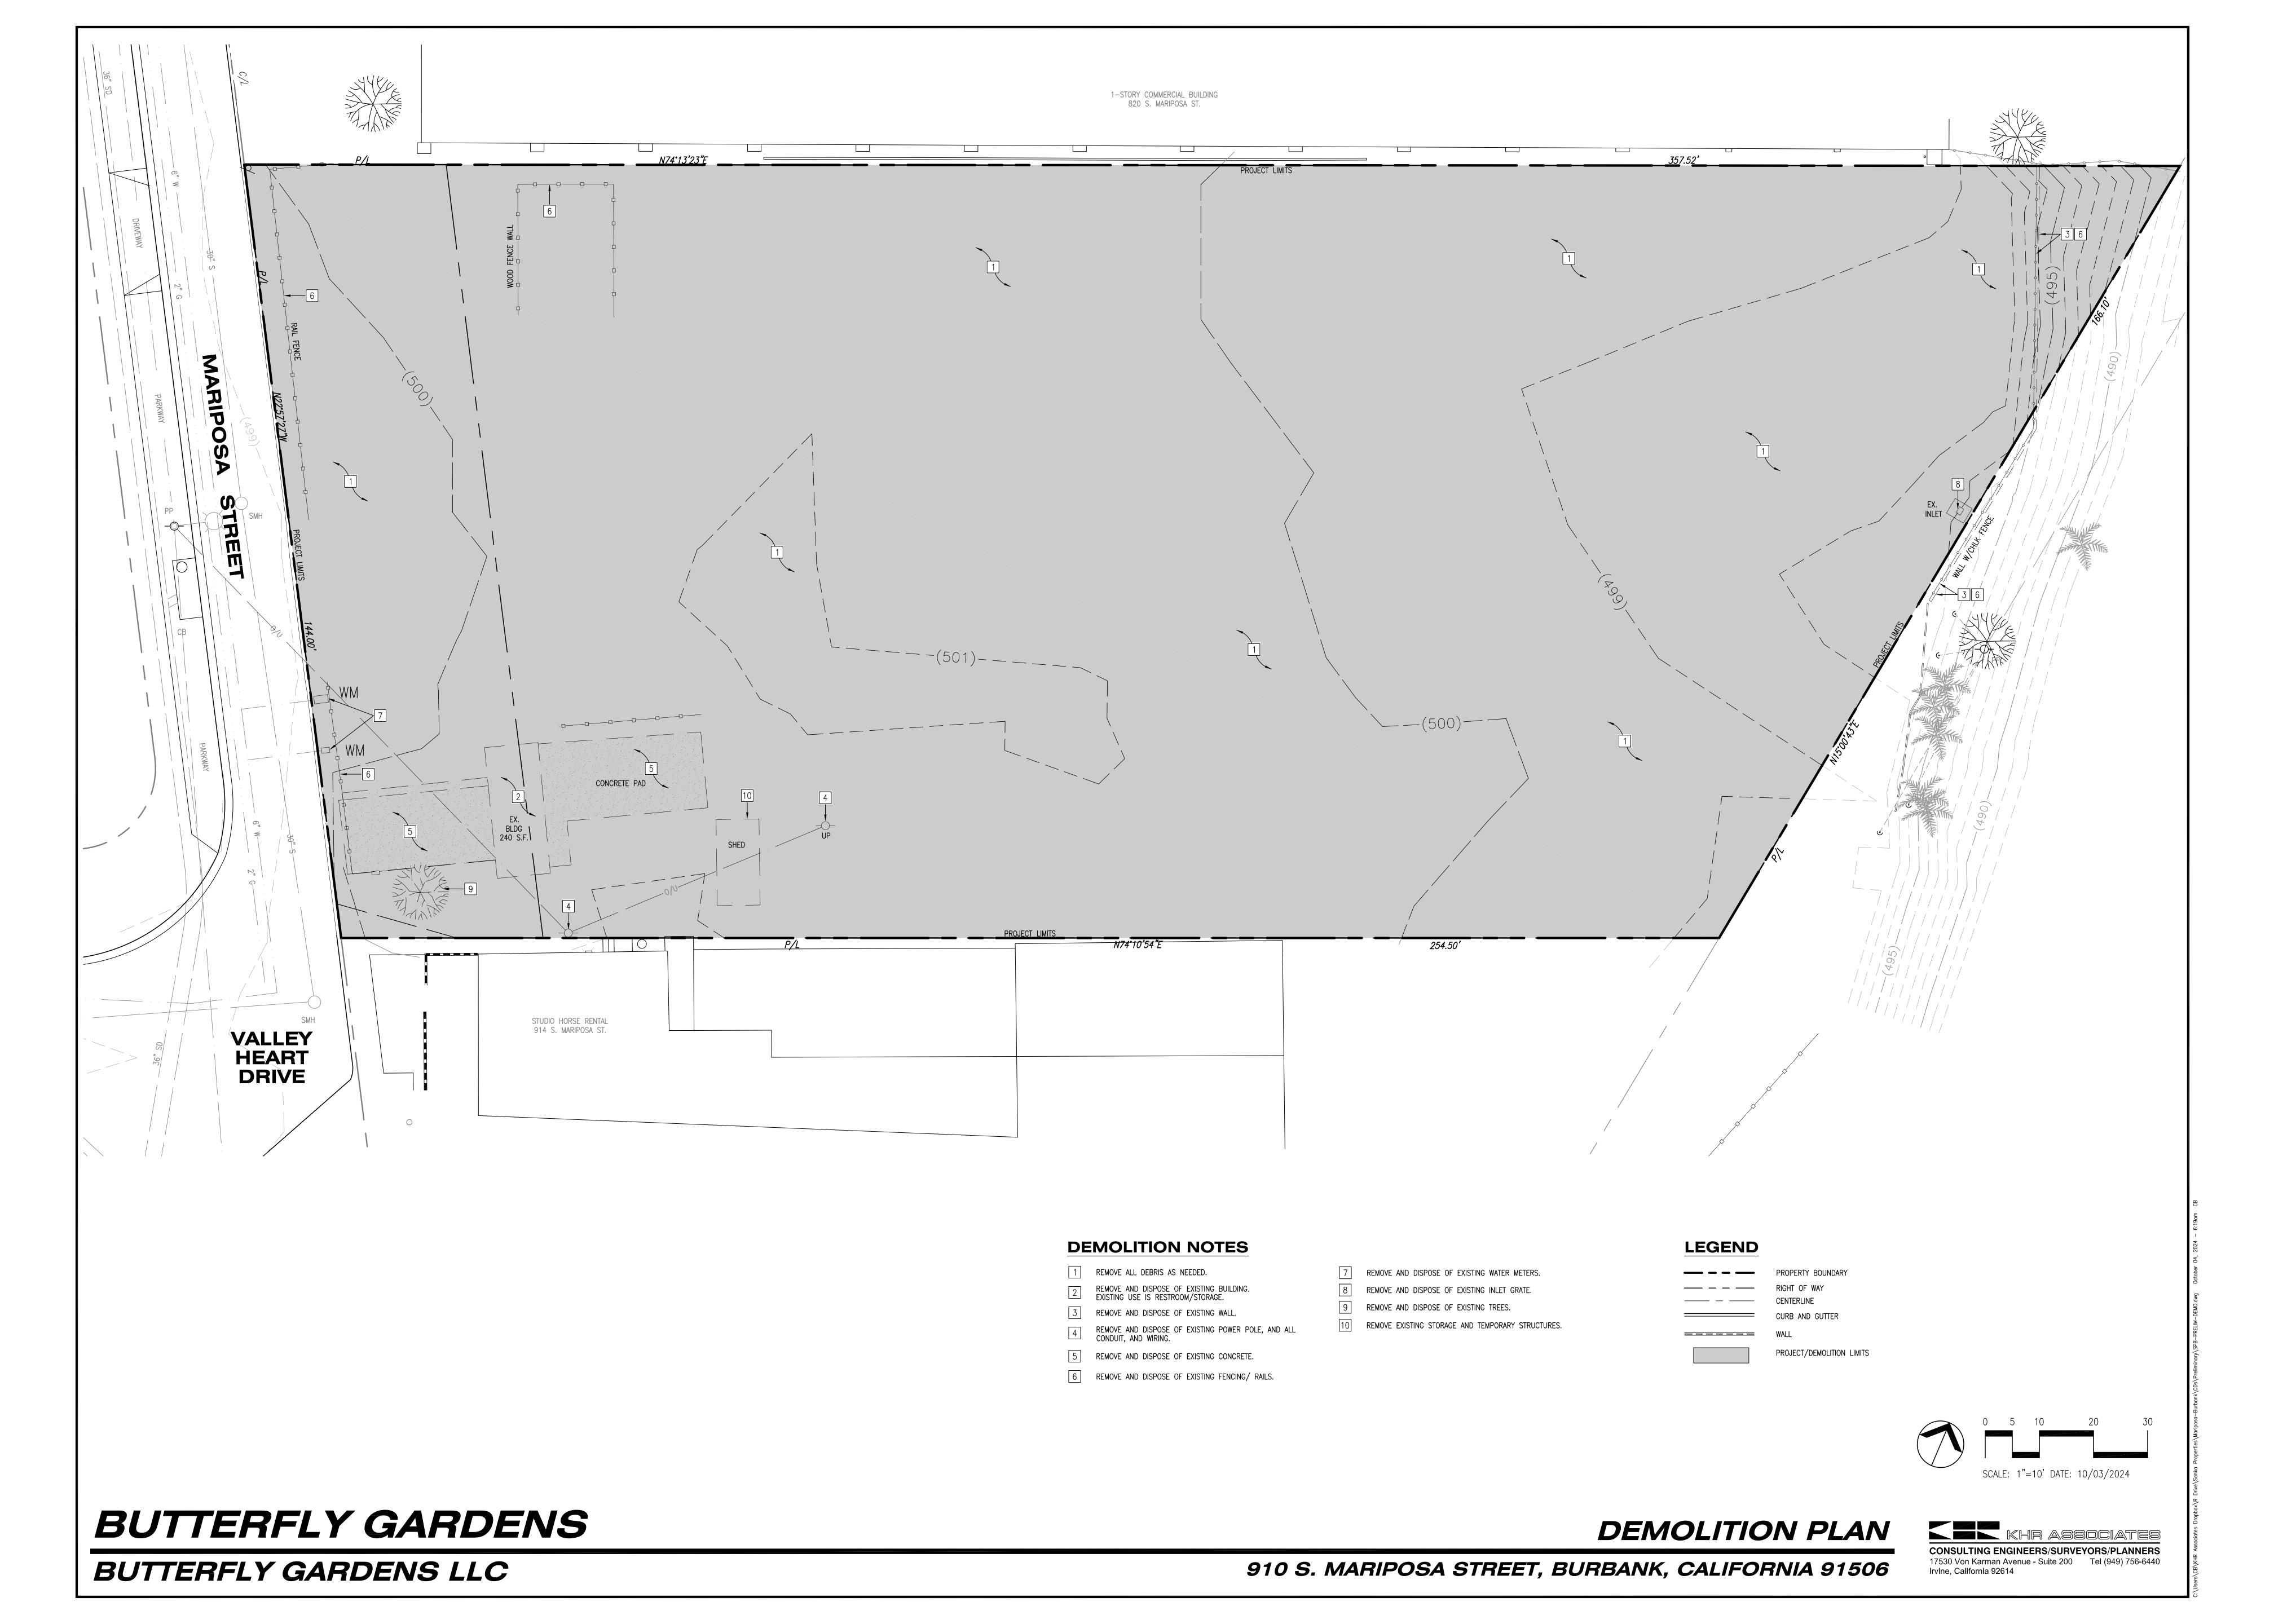


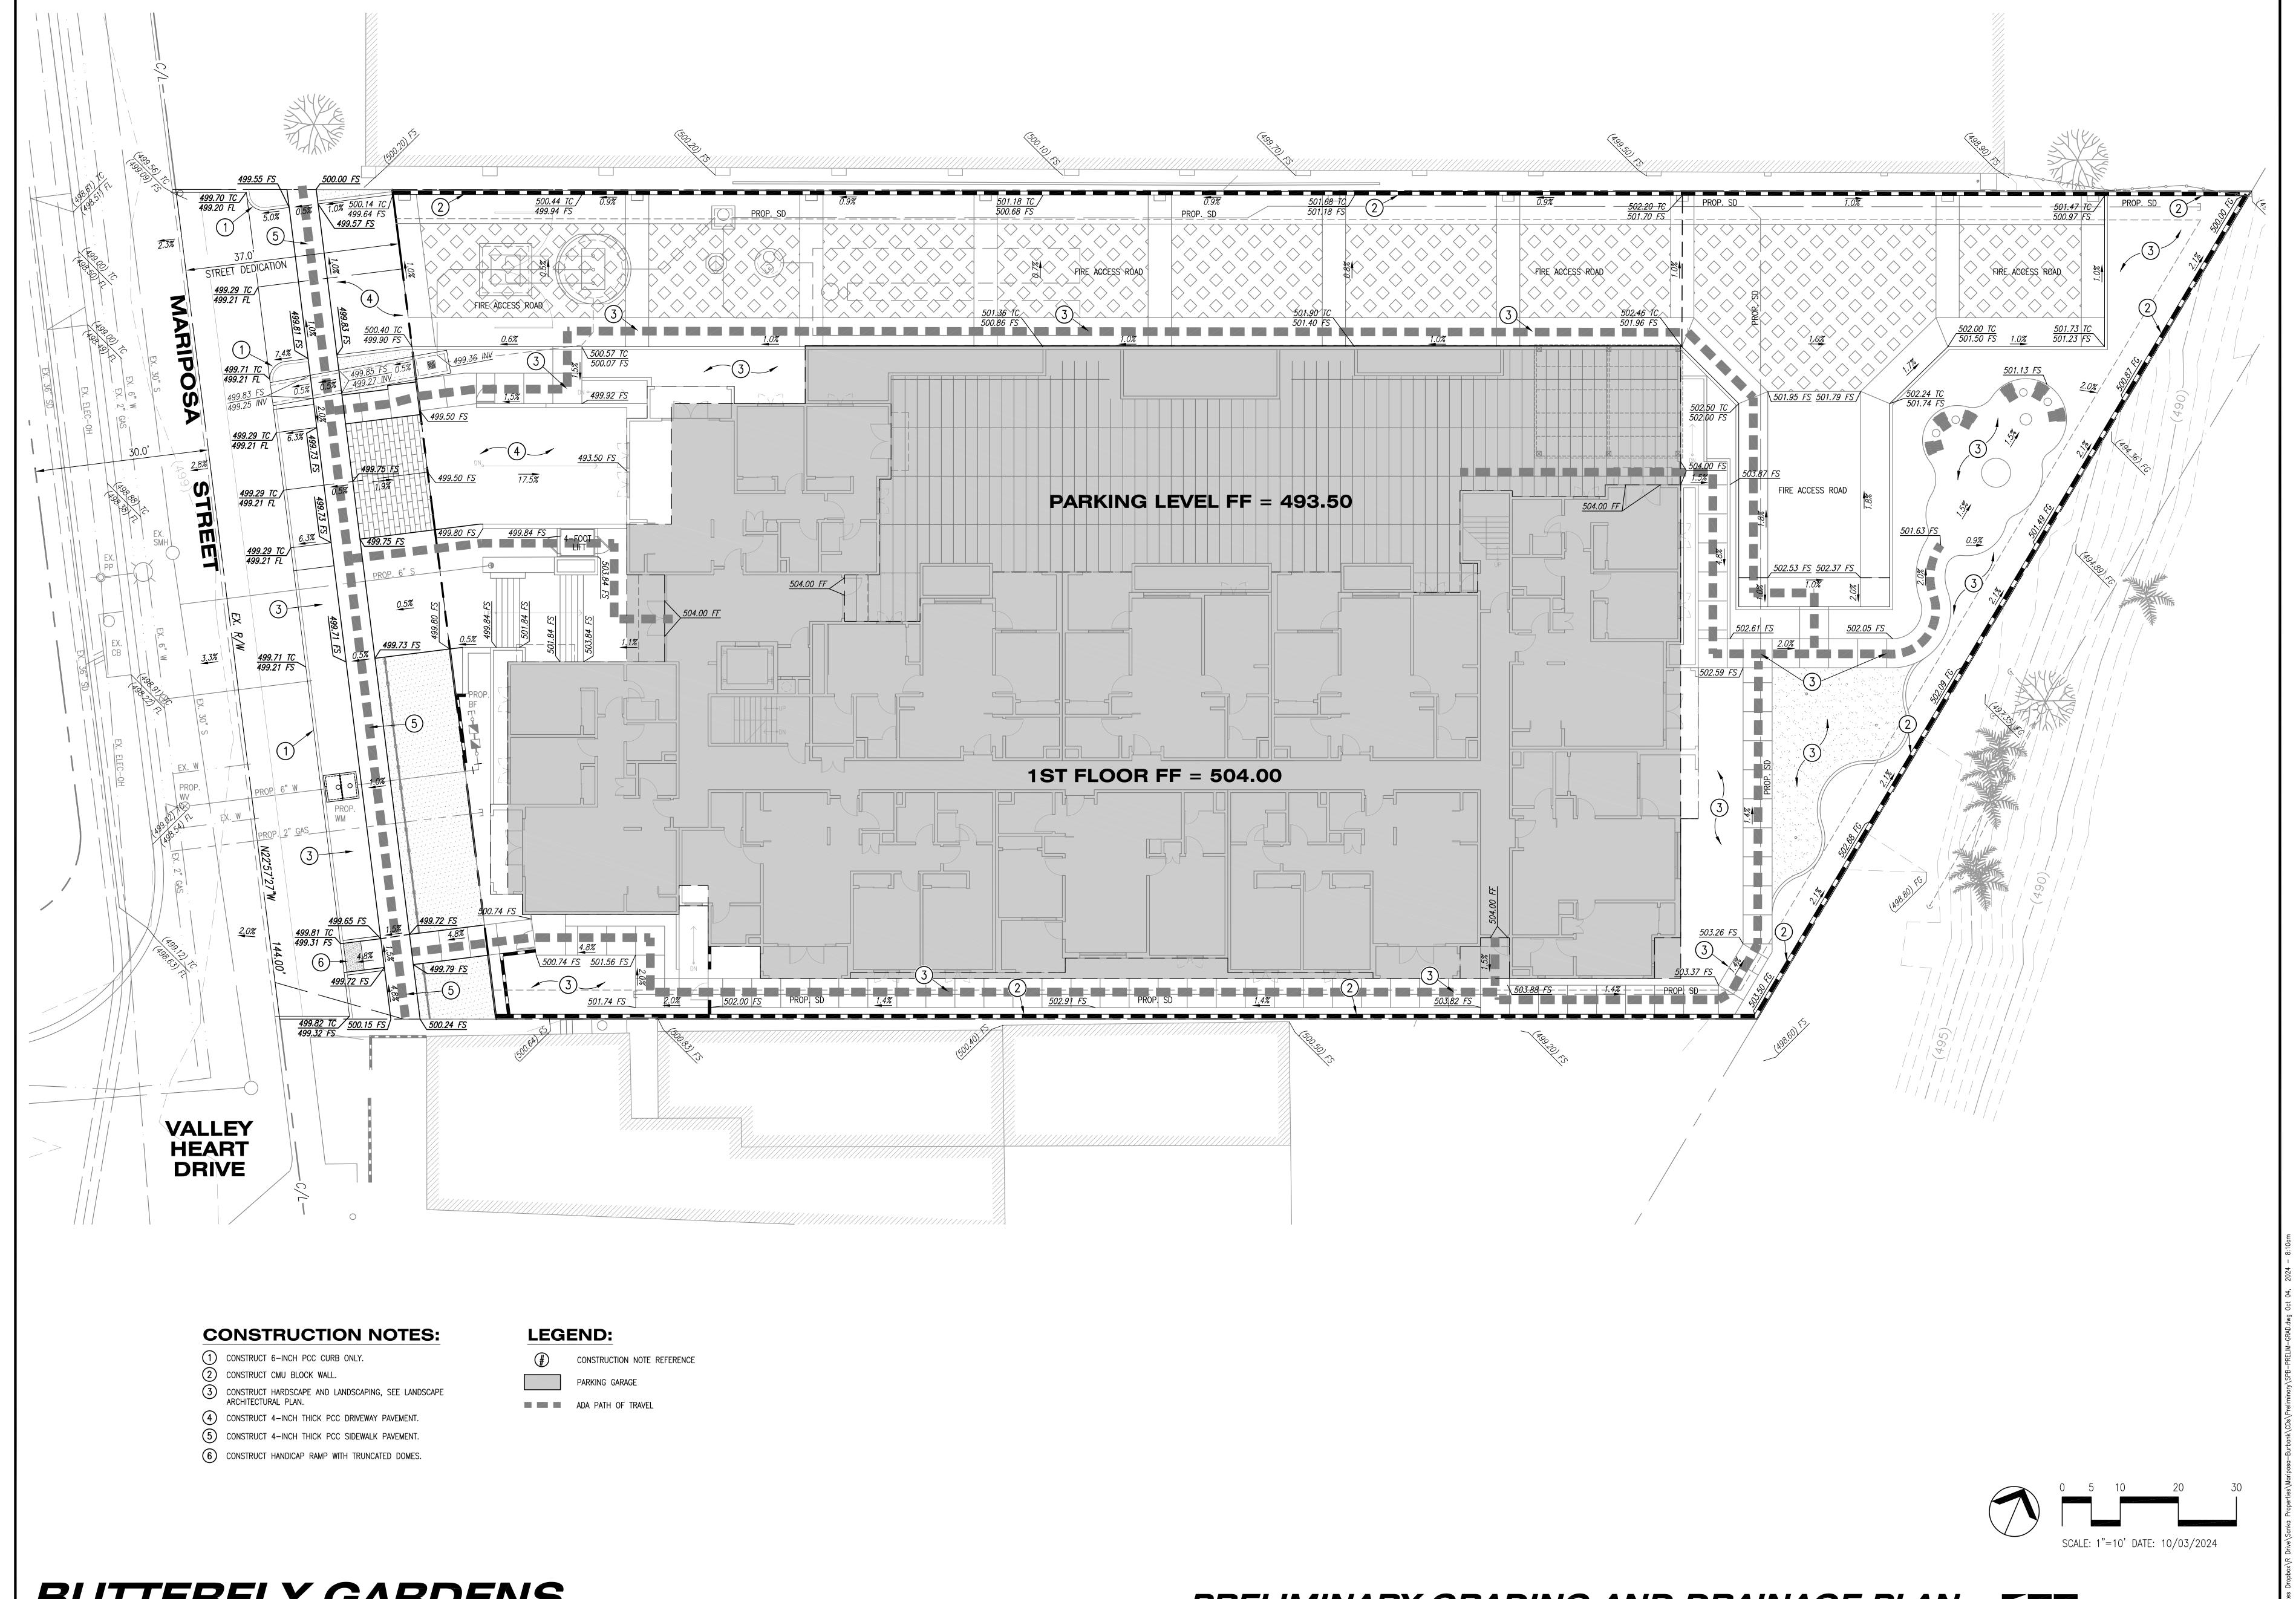


910 S. MARIPOSA STREET, BURBANK, CALIFORNIA 91506

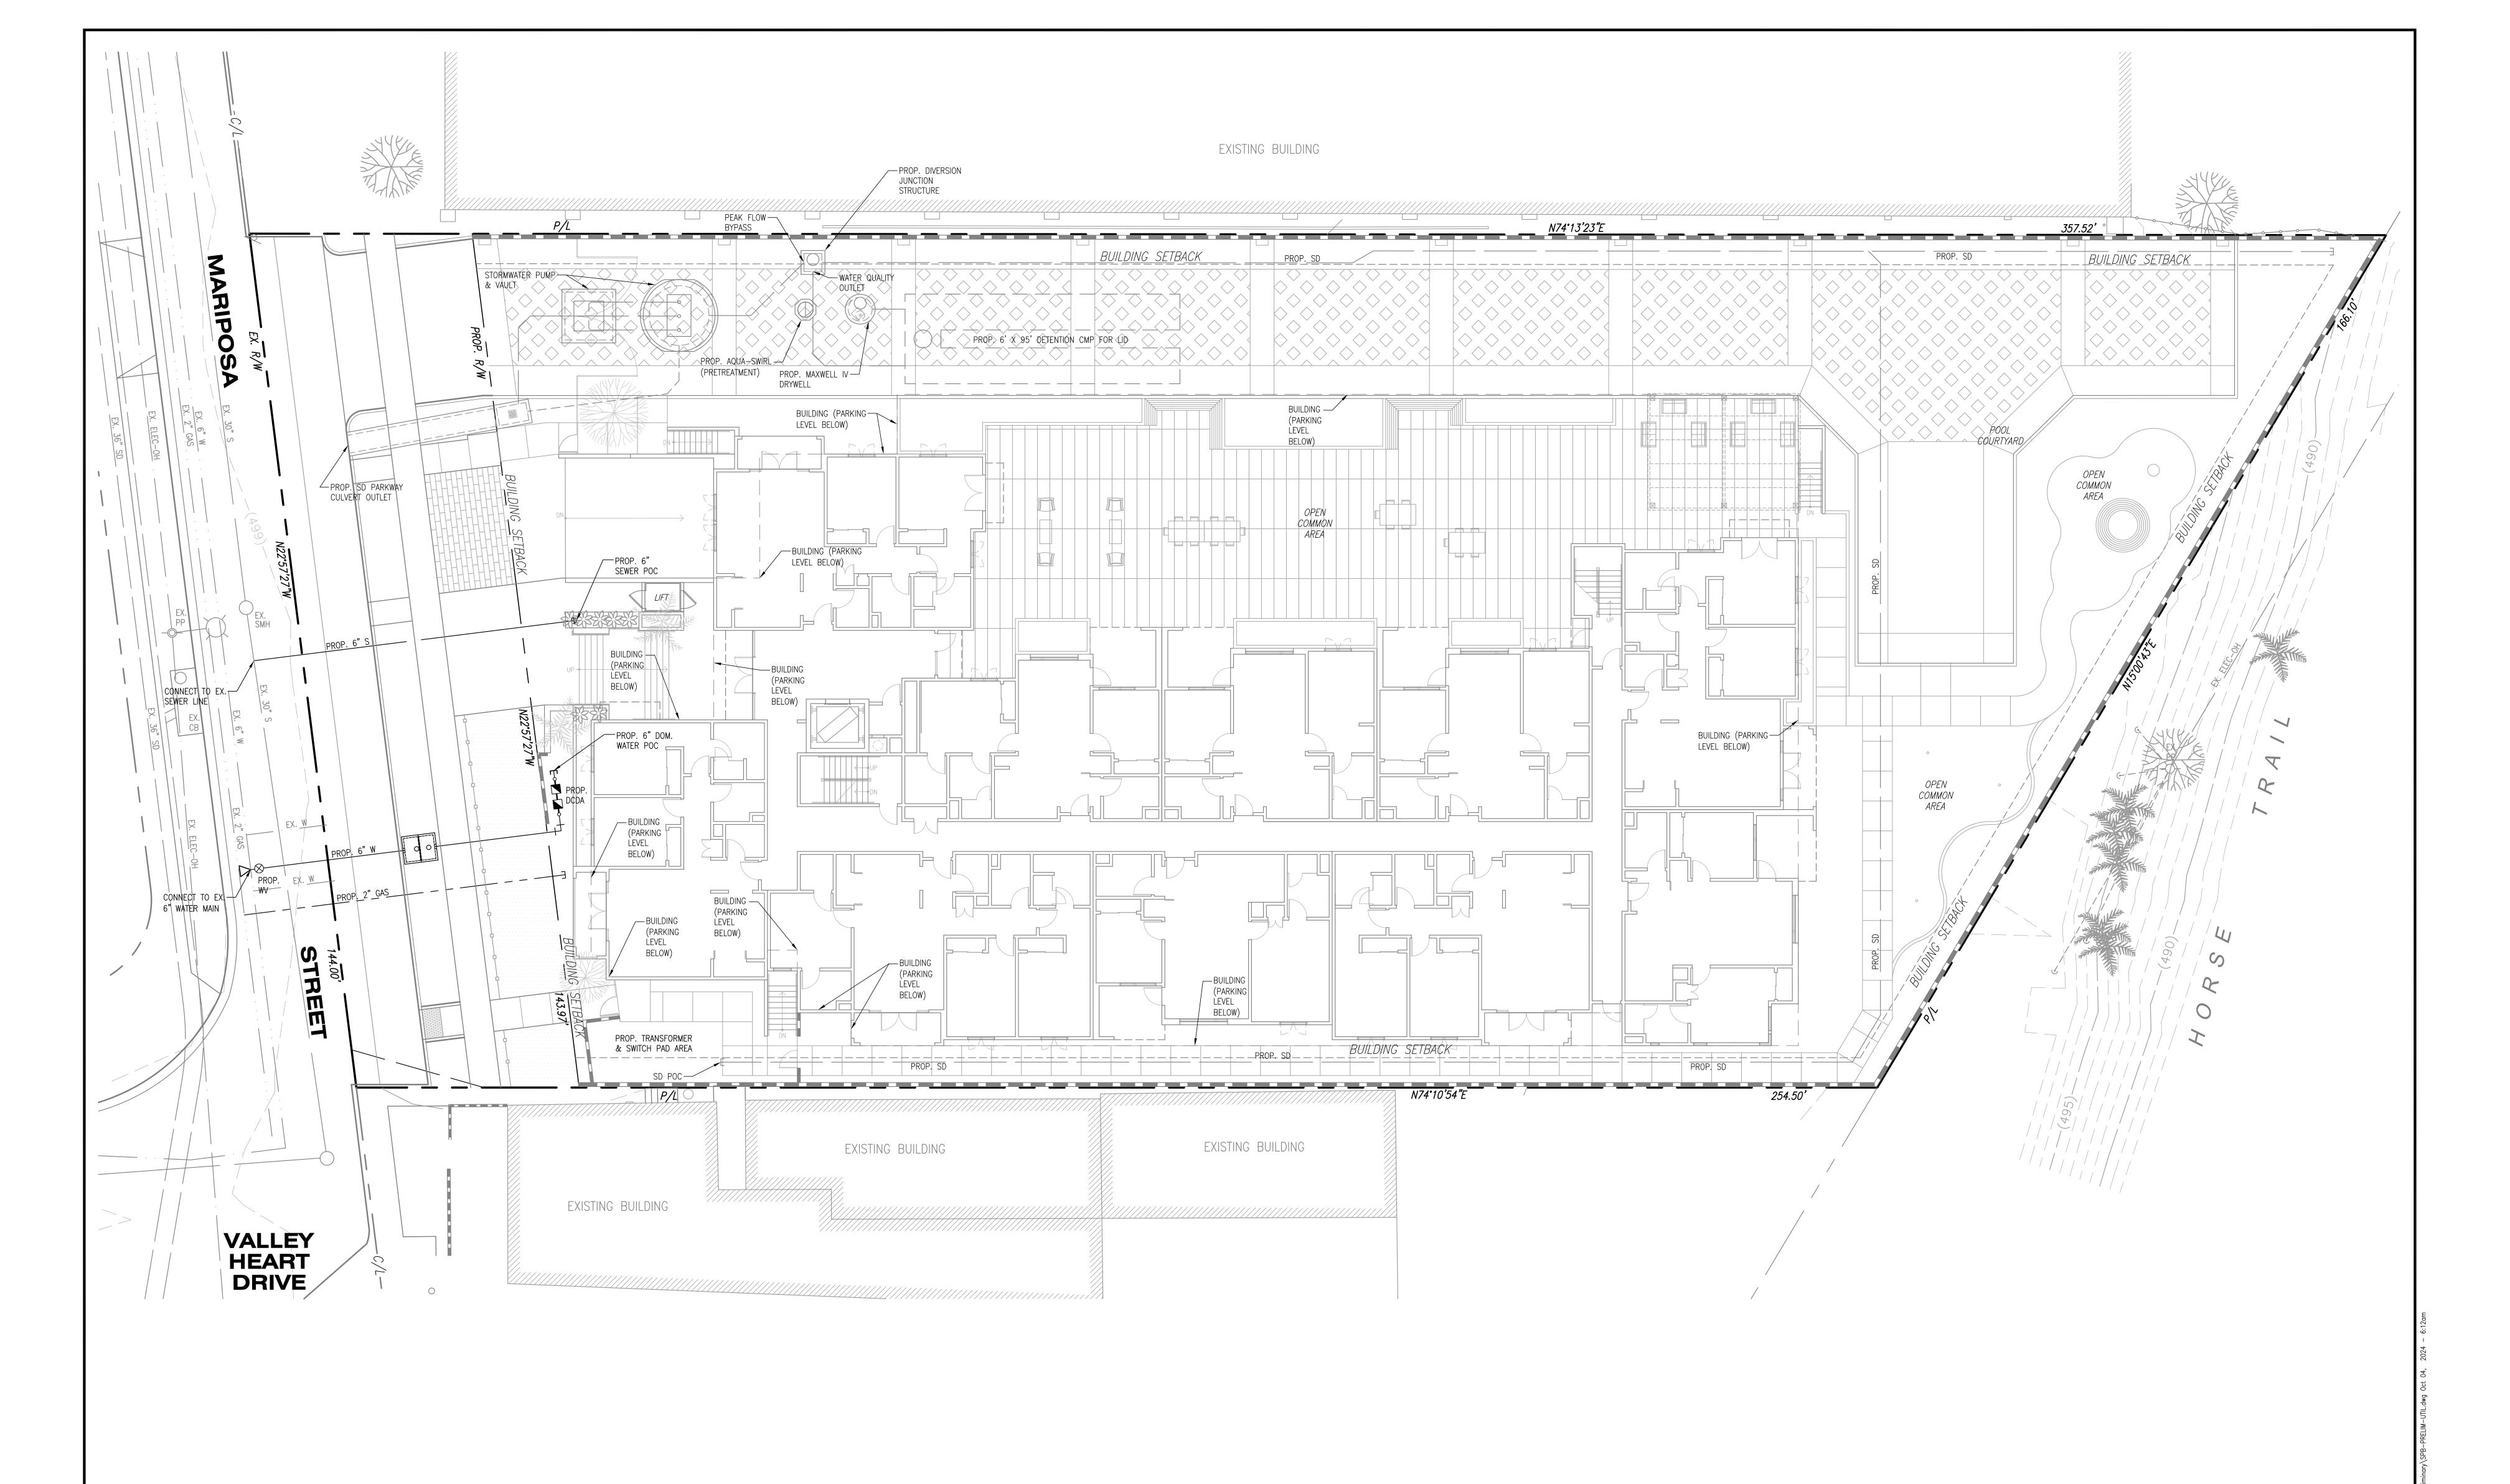

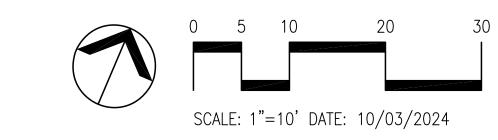

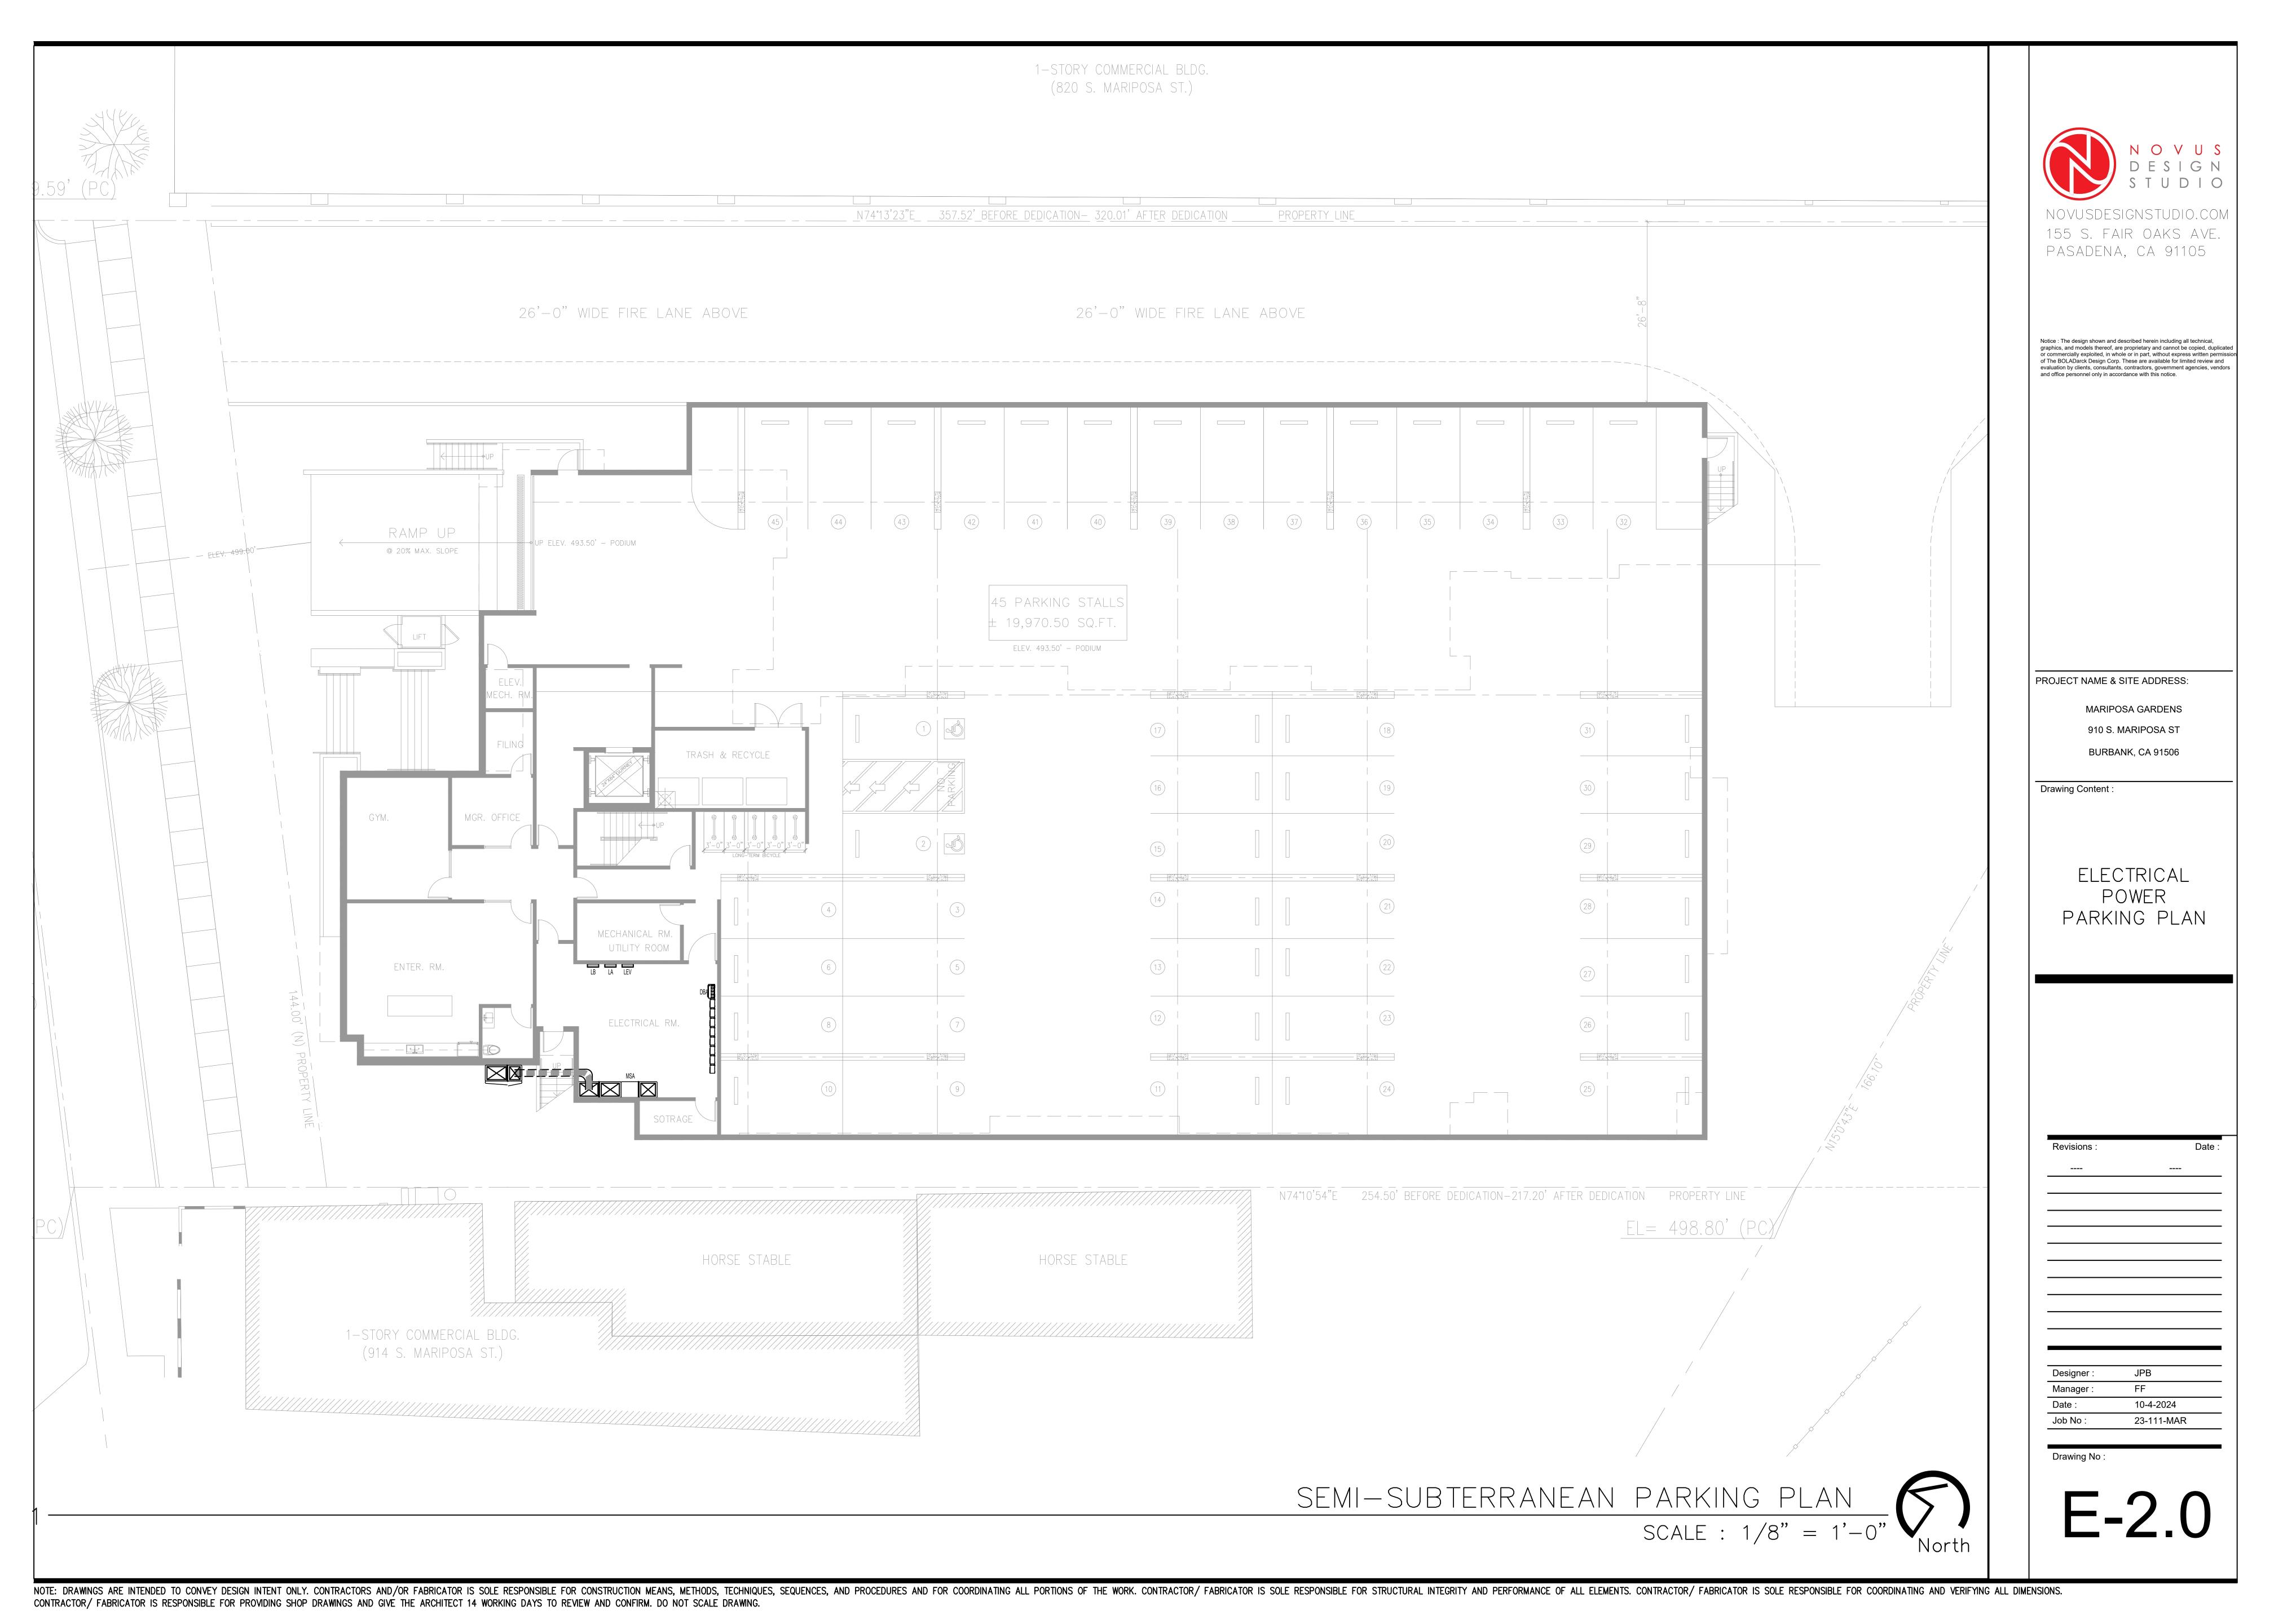

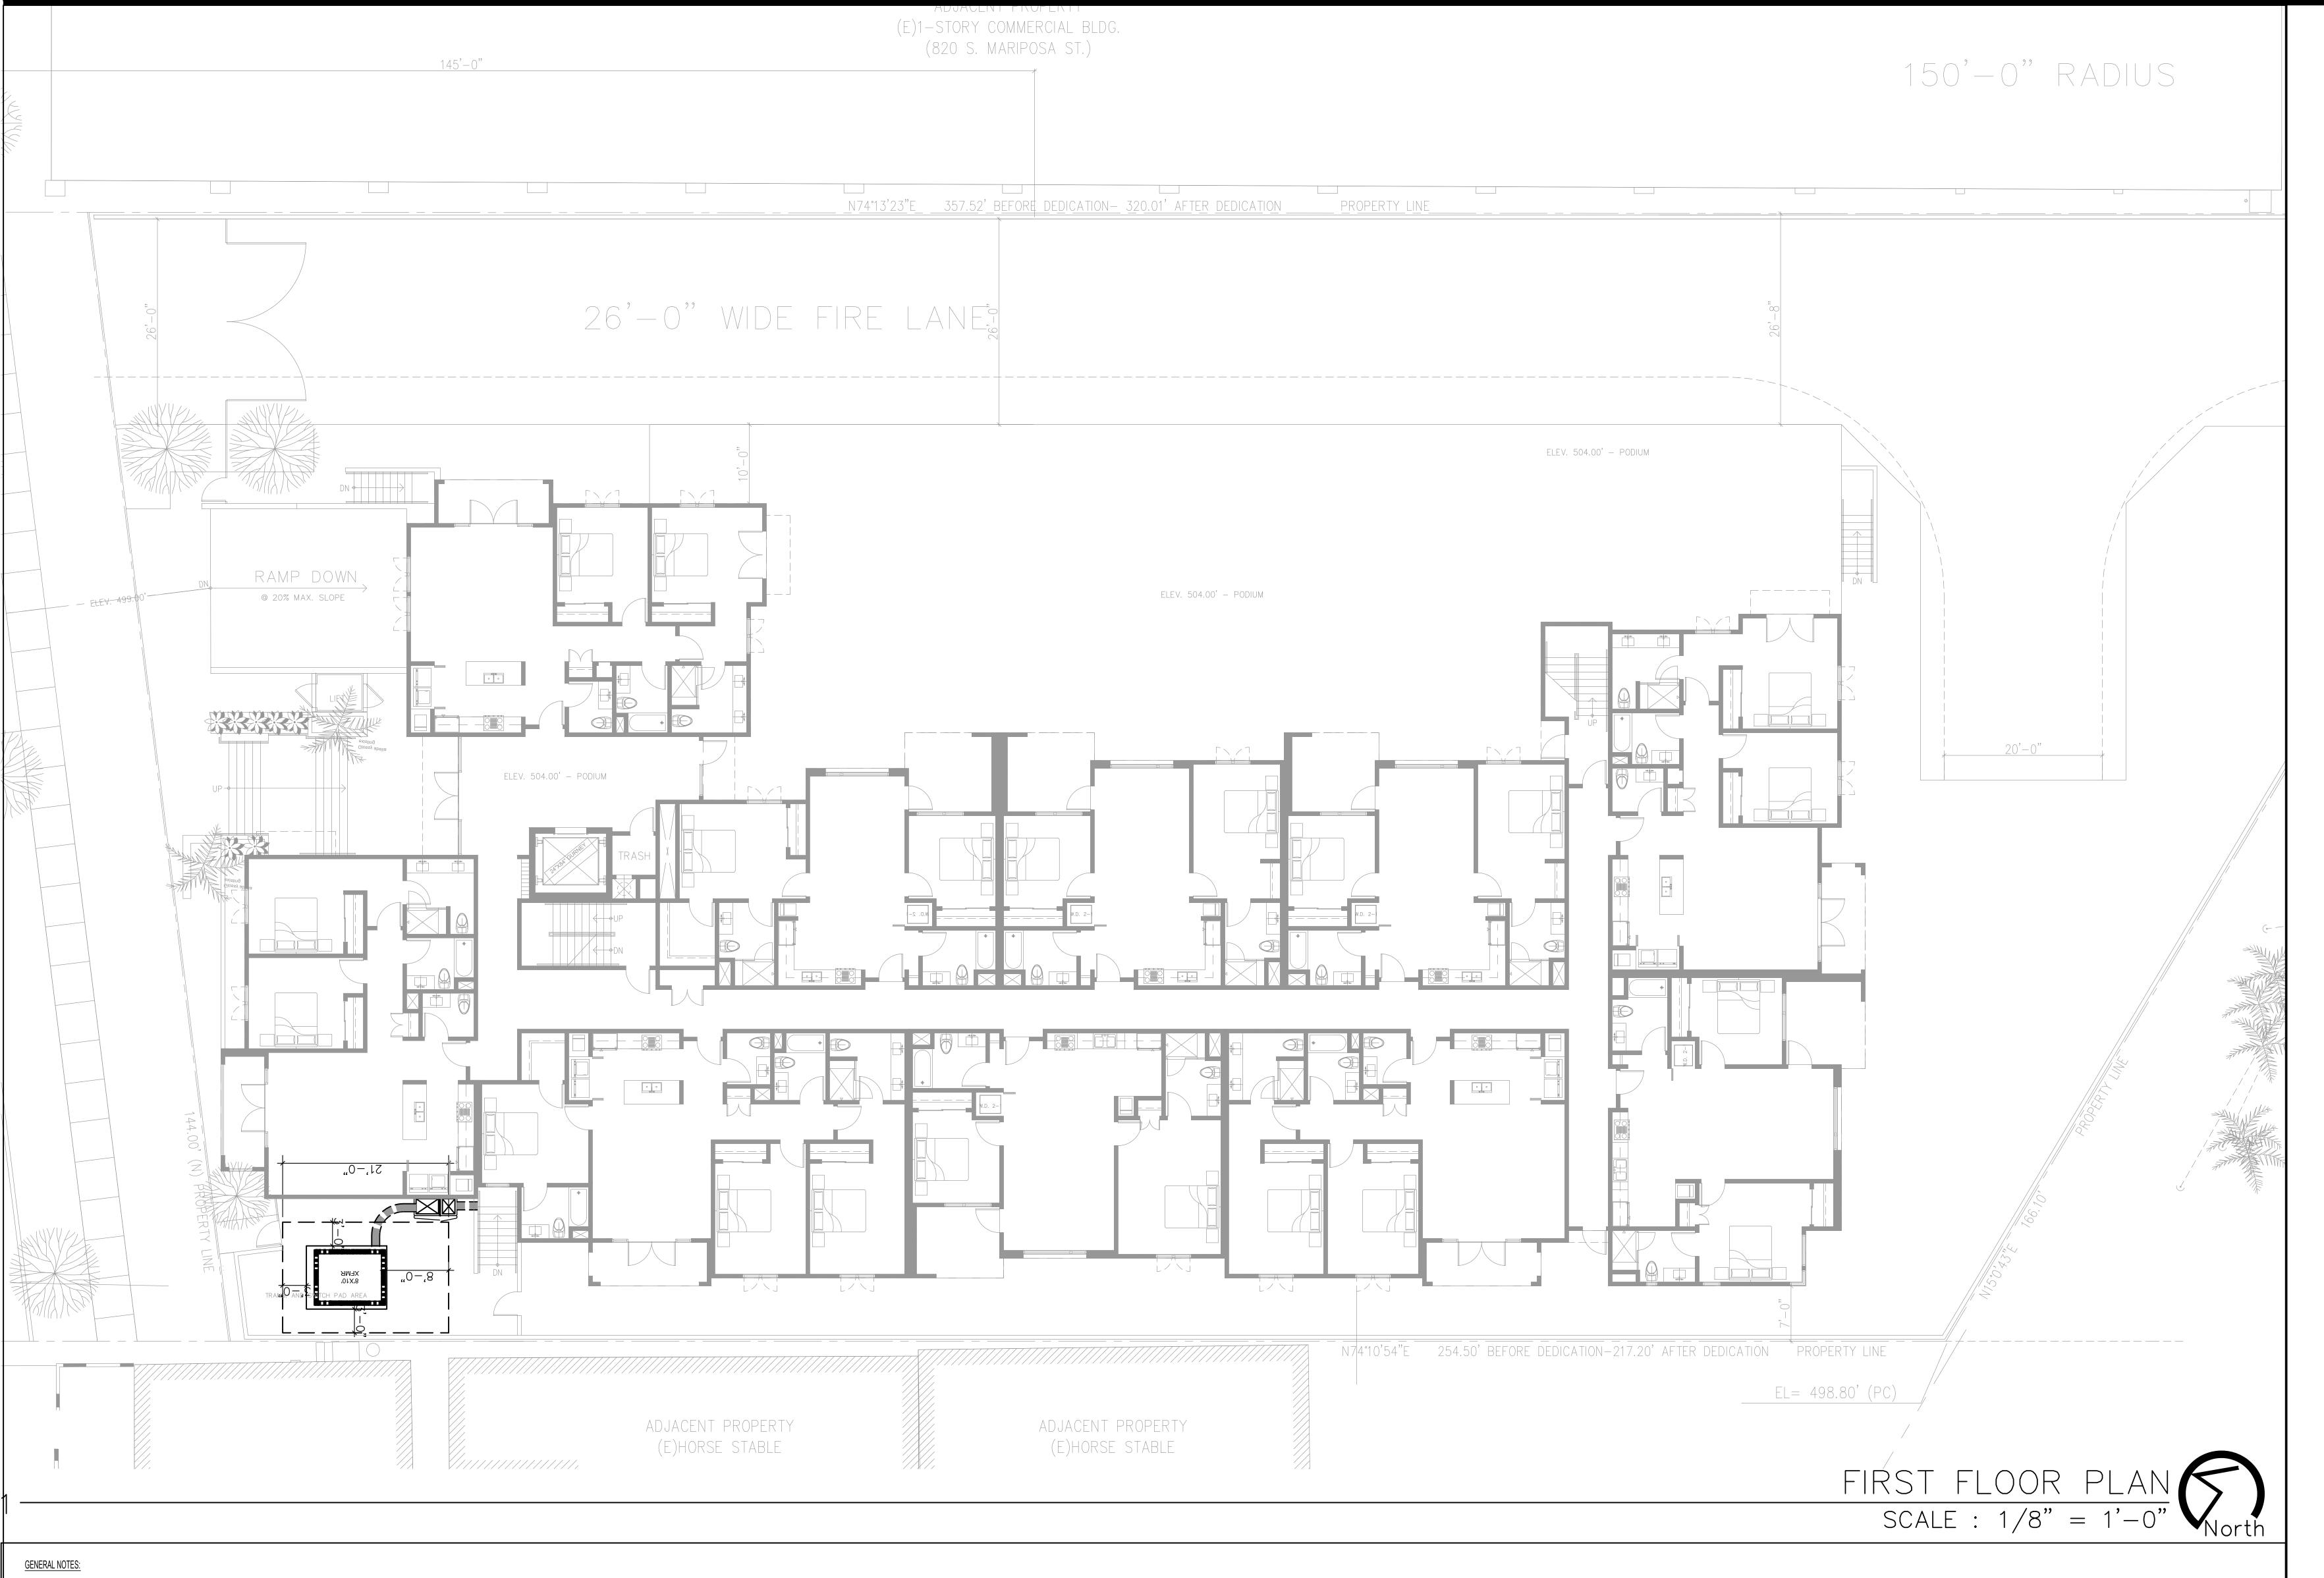

- 1. MAXIMUM VOLTAGE DROP FOR BRANCH CIRCUITING SHALL BE LESS THAN 3%. CONTRACTOR TO UPSIZE CONDUCTORS AND FEEDERS ACCORDINGLY.
- 2. ALL RECEPTACLES, F.A. DEVICES, ETC. THROUGHOUT (OTHER THAN ELECTRICAL AND MECHANICAL ROOMS) SHALL BE COORDINATED WITH ARCHITECT'S DRAWINGS PRIOR TO ROUTING ANY CONDUITS.
- 3. VERIFY EXACT LOCATION AND MOUNTING HEIGHT OF ALL EQUIPMENT, DEVICES, OUTLETS AND RECEPTACLES PER ARCHITECTURAL DRAWINGS PRIOR TO ROUTING THE CONDUITS.
- 4. VERIFY RECEPTACLE NEMA CONFIGURATION FOR OWNER FURNISHED EQUIPMENT.
- 5. VERIFY EXACT LOCATION OF J-BOXES (POINT OF CONNECTION) FOR DIRECT CONNECTED EQUIPMENT WITH EQUIPMENT MANUFACTURER. VERIFY THEIR REQUIREMENTS PRIOR TO ROUTING ANY CONDUIT.
- 6. PROVIDE SHOP DRAWINGS FOR ALL ELECTRICAL ROOMS EQUIPMENT LAYOUTS.
- 7. PROVIDE LARGER CUBIC-INCH CAPACITY J-BOX DUE TO THE QUANTITY OF WIRES. CONDUIT-TO-BOX CONNECTIONS, DEVICES, ETC. IN THE BOX PER CEC. 314.16.
- 8. ALL MULTI-WIRE BRANCH CIRCUITS TO HAVE DEDICATED NEUTRAL CONDUCTORS.
- 9. CONDITIONAL NOTE: ANY SERVICE DROP TRAVERSING THROUGH THE PROJECT SITE AND SERVING A NEIGHBORING PROPERTY IS TO BE UNDERGROUNDED BY BWP AT DEVELOPER'S EXPENSE. ANY BWP FACILITIES INSTALLED ON THE DEVELOPMENT THAT SERVE OTHER CUSTOMERS WILL REQUIRE AN EASEMENT. FURTHER CONSULTATION WITH BWP REQUIRED AT THE BUILDING PERMIT PLAN CHECK PHASE TO DETERMINE APPLICABILITY AND SCOPE.



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PROJECT NAME & SITE ADDRESS:

MARIPOSA GARDENS
910 S. MARIPOSA ST
BURBANK, CA 91506

Drawing Content :

ELECTRICAL
POWER
FIRST FLOOR
PLAN

Revisions: Date:

 Designer :
 JPB


 Manager :
 FF

 Date :
 07-8-2024

 Job No :
 23-111-MAR

Drawing No :

E-2.1

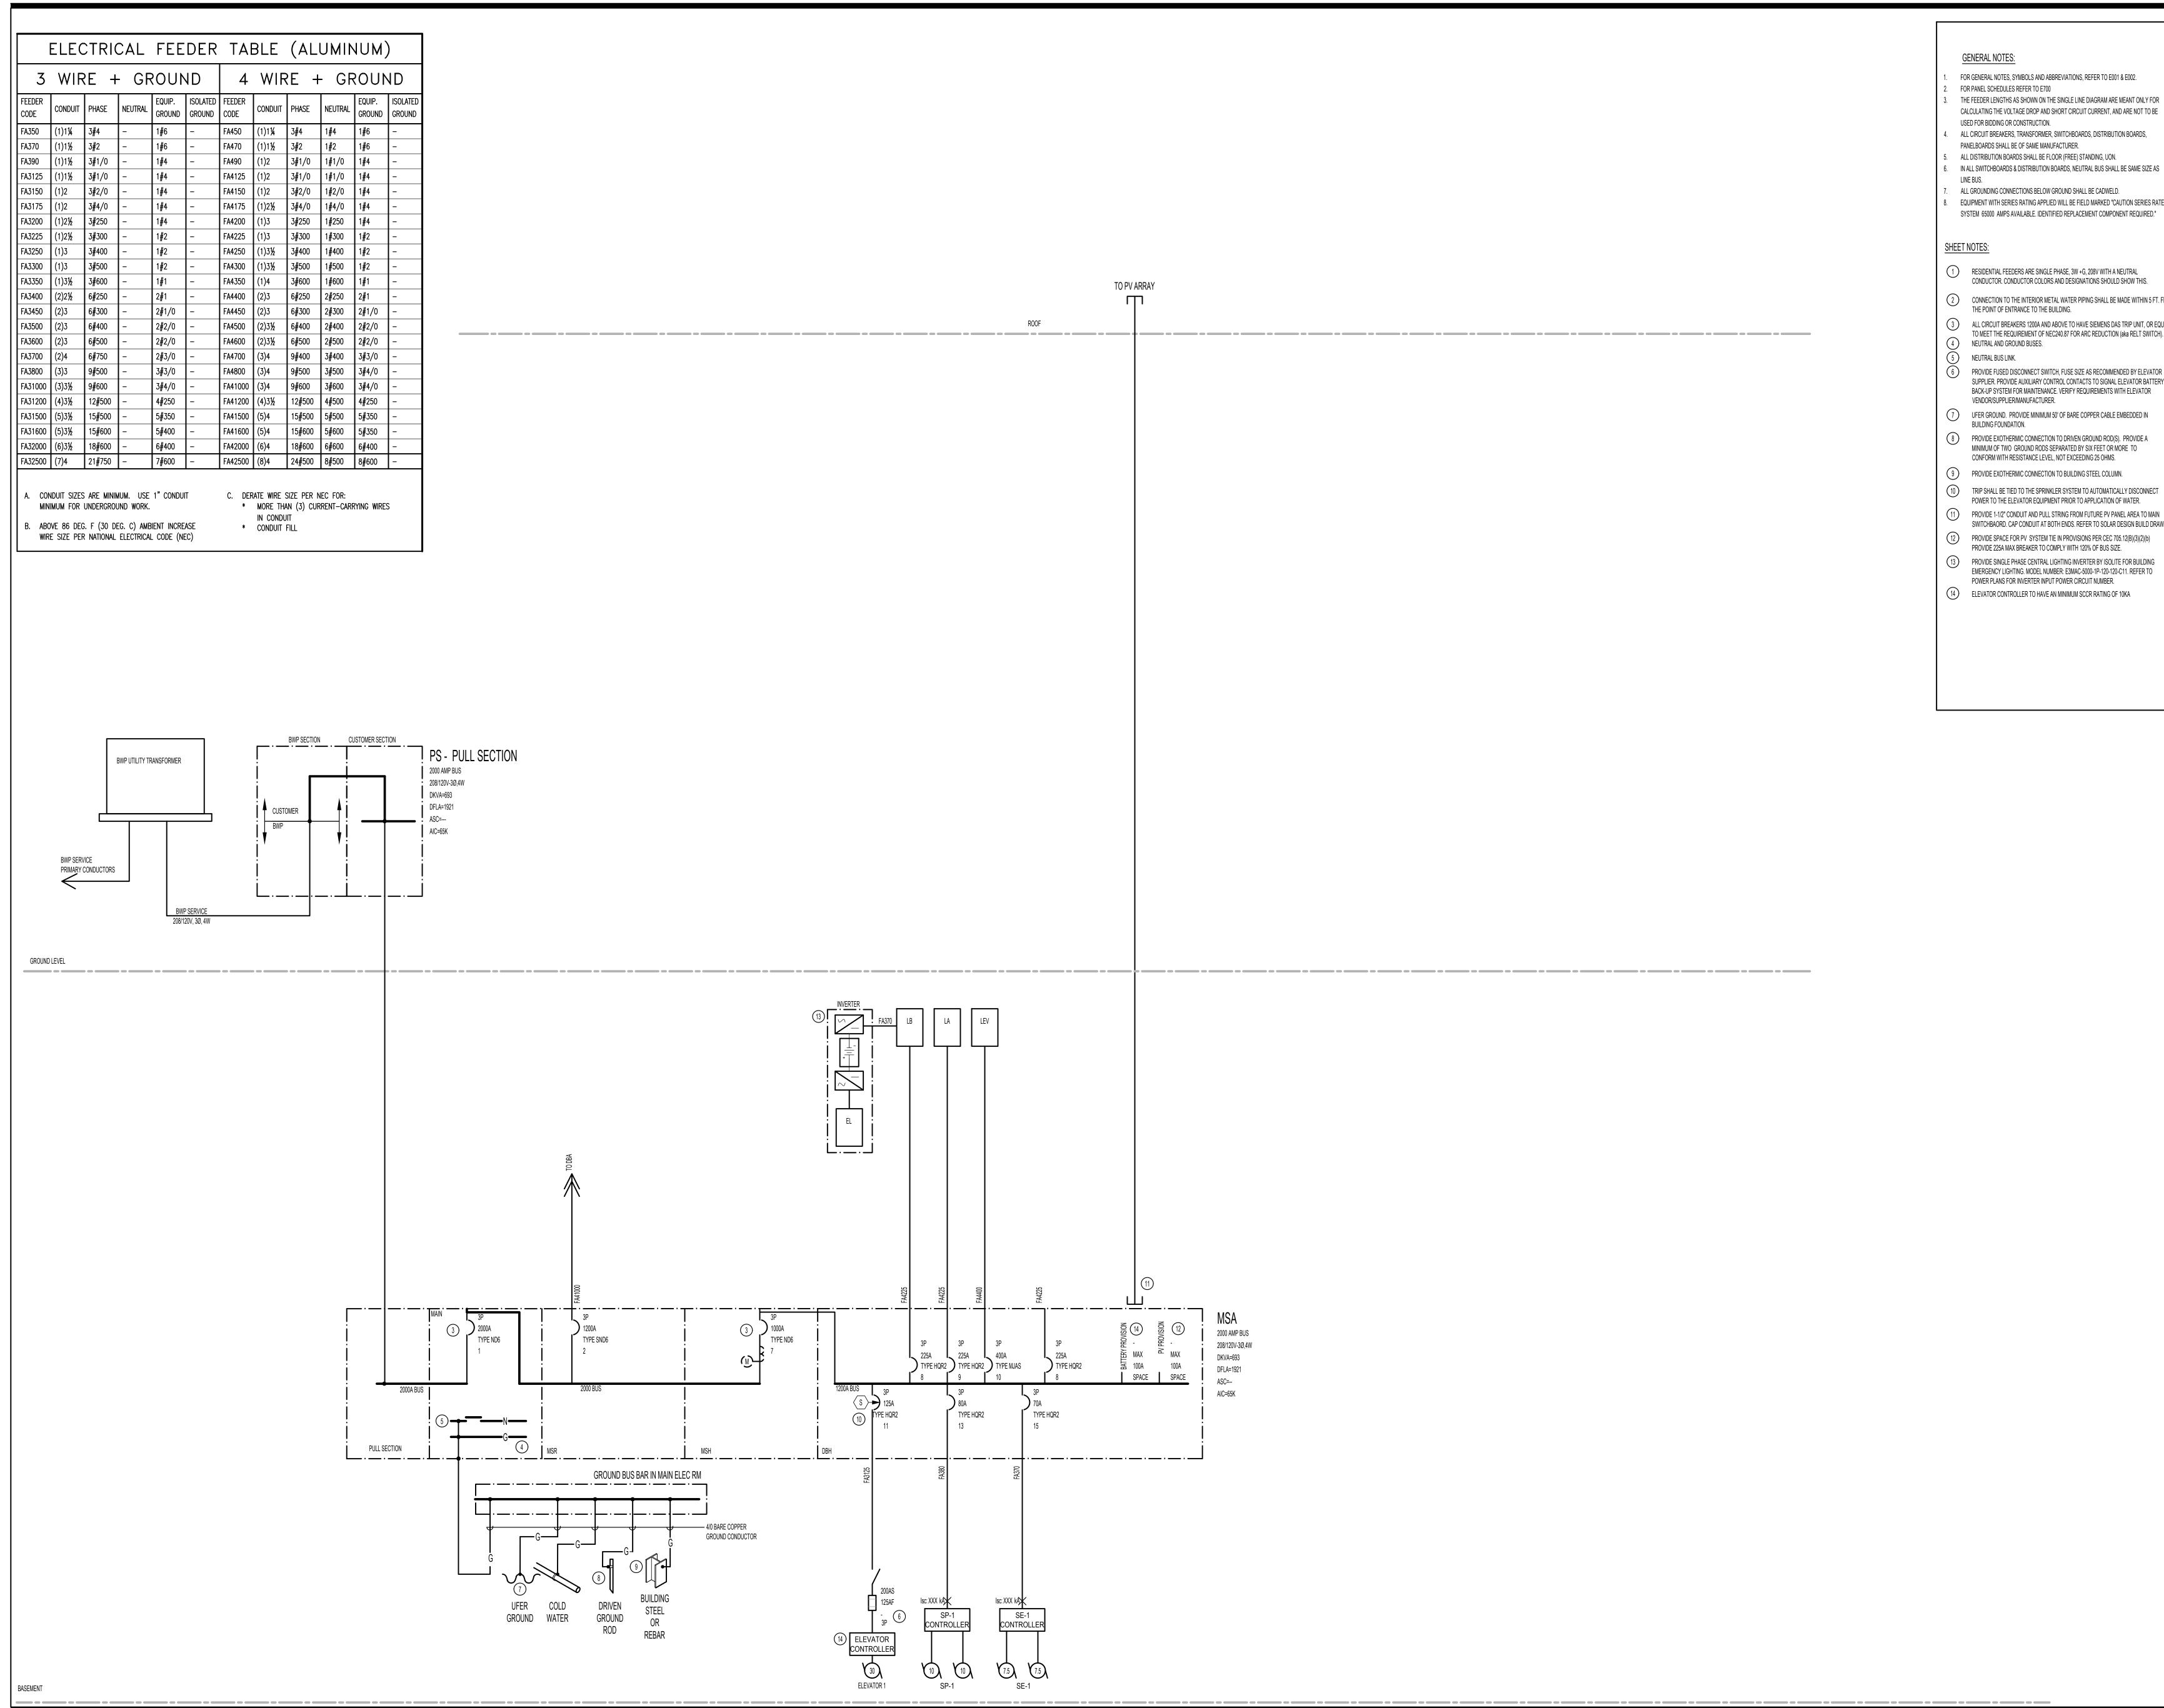

GENERAL NOTES:

- FOR GENERAL NOTES, SYMBOLS AND ABBREVIATIONS, REFER TO E001 & E002. FOR PANEL SCHEDULES REFER TO E700
- THE FEEDER LENGTHS AS SHOWN ON THE SINGLE LINE DIAGRAM ARE MEANT ONLY FOR CALCULATING THE VOLTAGE DROP AND SHORT CIRCUIT CURRENT, AND ARE NOT TO BE USED FOR BIDDING OR CONSTRUCTION.
- ALL CIRCUIT BREAKERS, TRANSFORMER, SWITCHBOARDS, DISTRIBUTION BOARDS, PANELBOARDS SHALL BE OF SAME MANUFACTURER.
- ALL DISTRIBUTION BOARDS SHALL BE FLOOR (FREE) STANDING, UON. IN ALL SWITCHBOARDS & DISTRIBUTION BOARDS, NEUTRAL BUS SHALL BE SAME SIZE AS
- ALL GROUNDING CONNECTIONS BELOW GROUND SHALL BE CADWELD. EQUIPMENT WITH SERIES RATING APPLIED WILL BE FIELD MARKED "CAUTION SERIES RATED

- 1) RESIDENTIAL FEEDERS ARE SINGLE PHASE, 3W +G, 208V WITH A NEUTRAL CONDUCTOR. CONDUCTOR COLORS AND DESIGNATIONS SHOULD SHOW THIS.
- CONNECTION TO THE INTERIOR METAL WATER PIPING SHALL BE MADE WITHIN 5 FT. FROM
- THE POINT OF ENTRANCE TO THE BUILDING. 3 ALL CIRCUIT BREAKERS 1200A AND ABOVE TO HAVE SIEMENS DAS TRIP UNIT, OR EQUAL TO MEET THE REQUIREMENT OF NEC240.87 FOR ARC REDUCTION (aka RELT SWITCH).
- NEUTRAL AND GROUND BUSES. NEUTRAL BUS LINK.
- SUPPLIER. PROVIDE AUXILIARY CONTROL CONTACTS TO SIGNAL ELEVATOR BATTERY BACK-UP SYSTEM FOR MAINTENANCE. VERIFY REQUIREMENTS WITH ELEVATOR VENDOR/SUPPLIER/MANUFACTURER.
- UFER GROUND. PROVIDE MINIMUM 50' OF BARE COPPER CABLE EMBEDDED IN
- BUILDING FOUNDATION. 8 PROVIDE EXOTHERMIC CONNECTION TO DRIVEN GROUND ROD(S). PROVIDE A
- MINIMUM OF TWO GROUND RODS SEPARATED BY SIX FEET OR MORE TO CONFORM WITH RESISTANCE LEVEL, NOT EXCEEDING 25 OHMS.
- 9 PROVIDE EXOTHERMIC CONNECTION TO BUILDING STEEL COLUMN. 10 TRIP SHALL BE TIED TO THE SPRINKLER SYSTEM TO AUTOMATICALLY DISCONNECT
- POWER TO THE ELEVATOR EQUIPMENT PRIOR TO APPLICATION OF WATER.
- 11) PROVIDE 1-1/2" CONDUIT AND PULL STRING FROM FUTURE PV PANEL AREA TO MAIN SWITCHBAORD. CAP CONDUIT AT BOTH ENDS. REFER TO SOLAR DESIGN BUILD DRAWINGS
- PROVIDE SPACE FOR PV SYSTEM TIE IN PROVISIONS PER CEC 705.12(B)(3)(2)(b) PROVIDE 225A MAX BREAKER TO COMPLY WITH 120% OF BUS SIZE.
- (13) PROVIDE SINGLE PHASE CENTRAL LIGHTING INVERTER BY ISOLITE FOR BUILDING EMERGENCY LIGHTING. MODEL NUMBER: E3MAC-5000-1P-120-120-C11. REFER TO
- POWER PLANS FOR INVERTER INPUT POWER CIRCUIT NUMBER. ELEVATOR CONTROLLER TO HAVE AN MINIMUM SCCR RATING OF 10KA

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PROJECT NAME & SITE ADDRESS:

MARIPOSA GARDENS 910 S. MARIPOSA ST

BURBANK, CA 91506


Drawing Content:

ELECTRICAL SINGLE LINE DIAGRAM

ELECTRICAL SINGLE LINE DIAGRAM -MAIN DISTRIBUTION

JPB Designer: Manager 10-4-2024 Job No: 23-111-MAR

Drawing No:

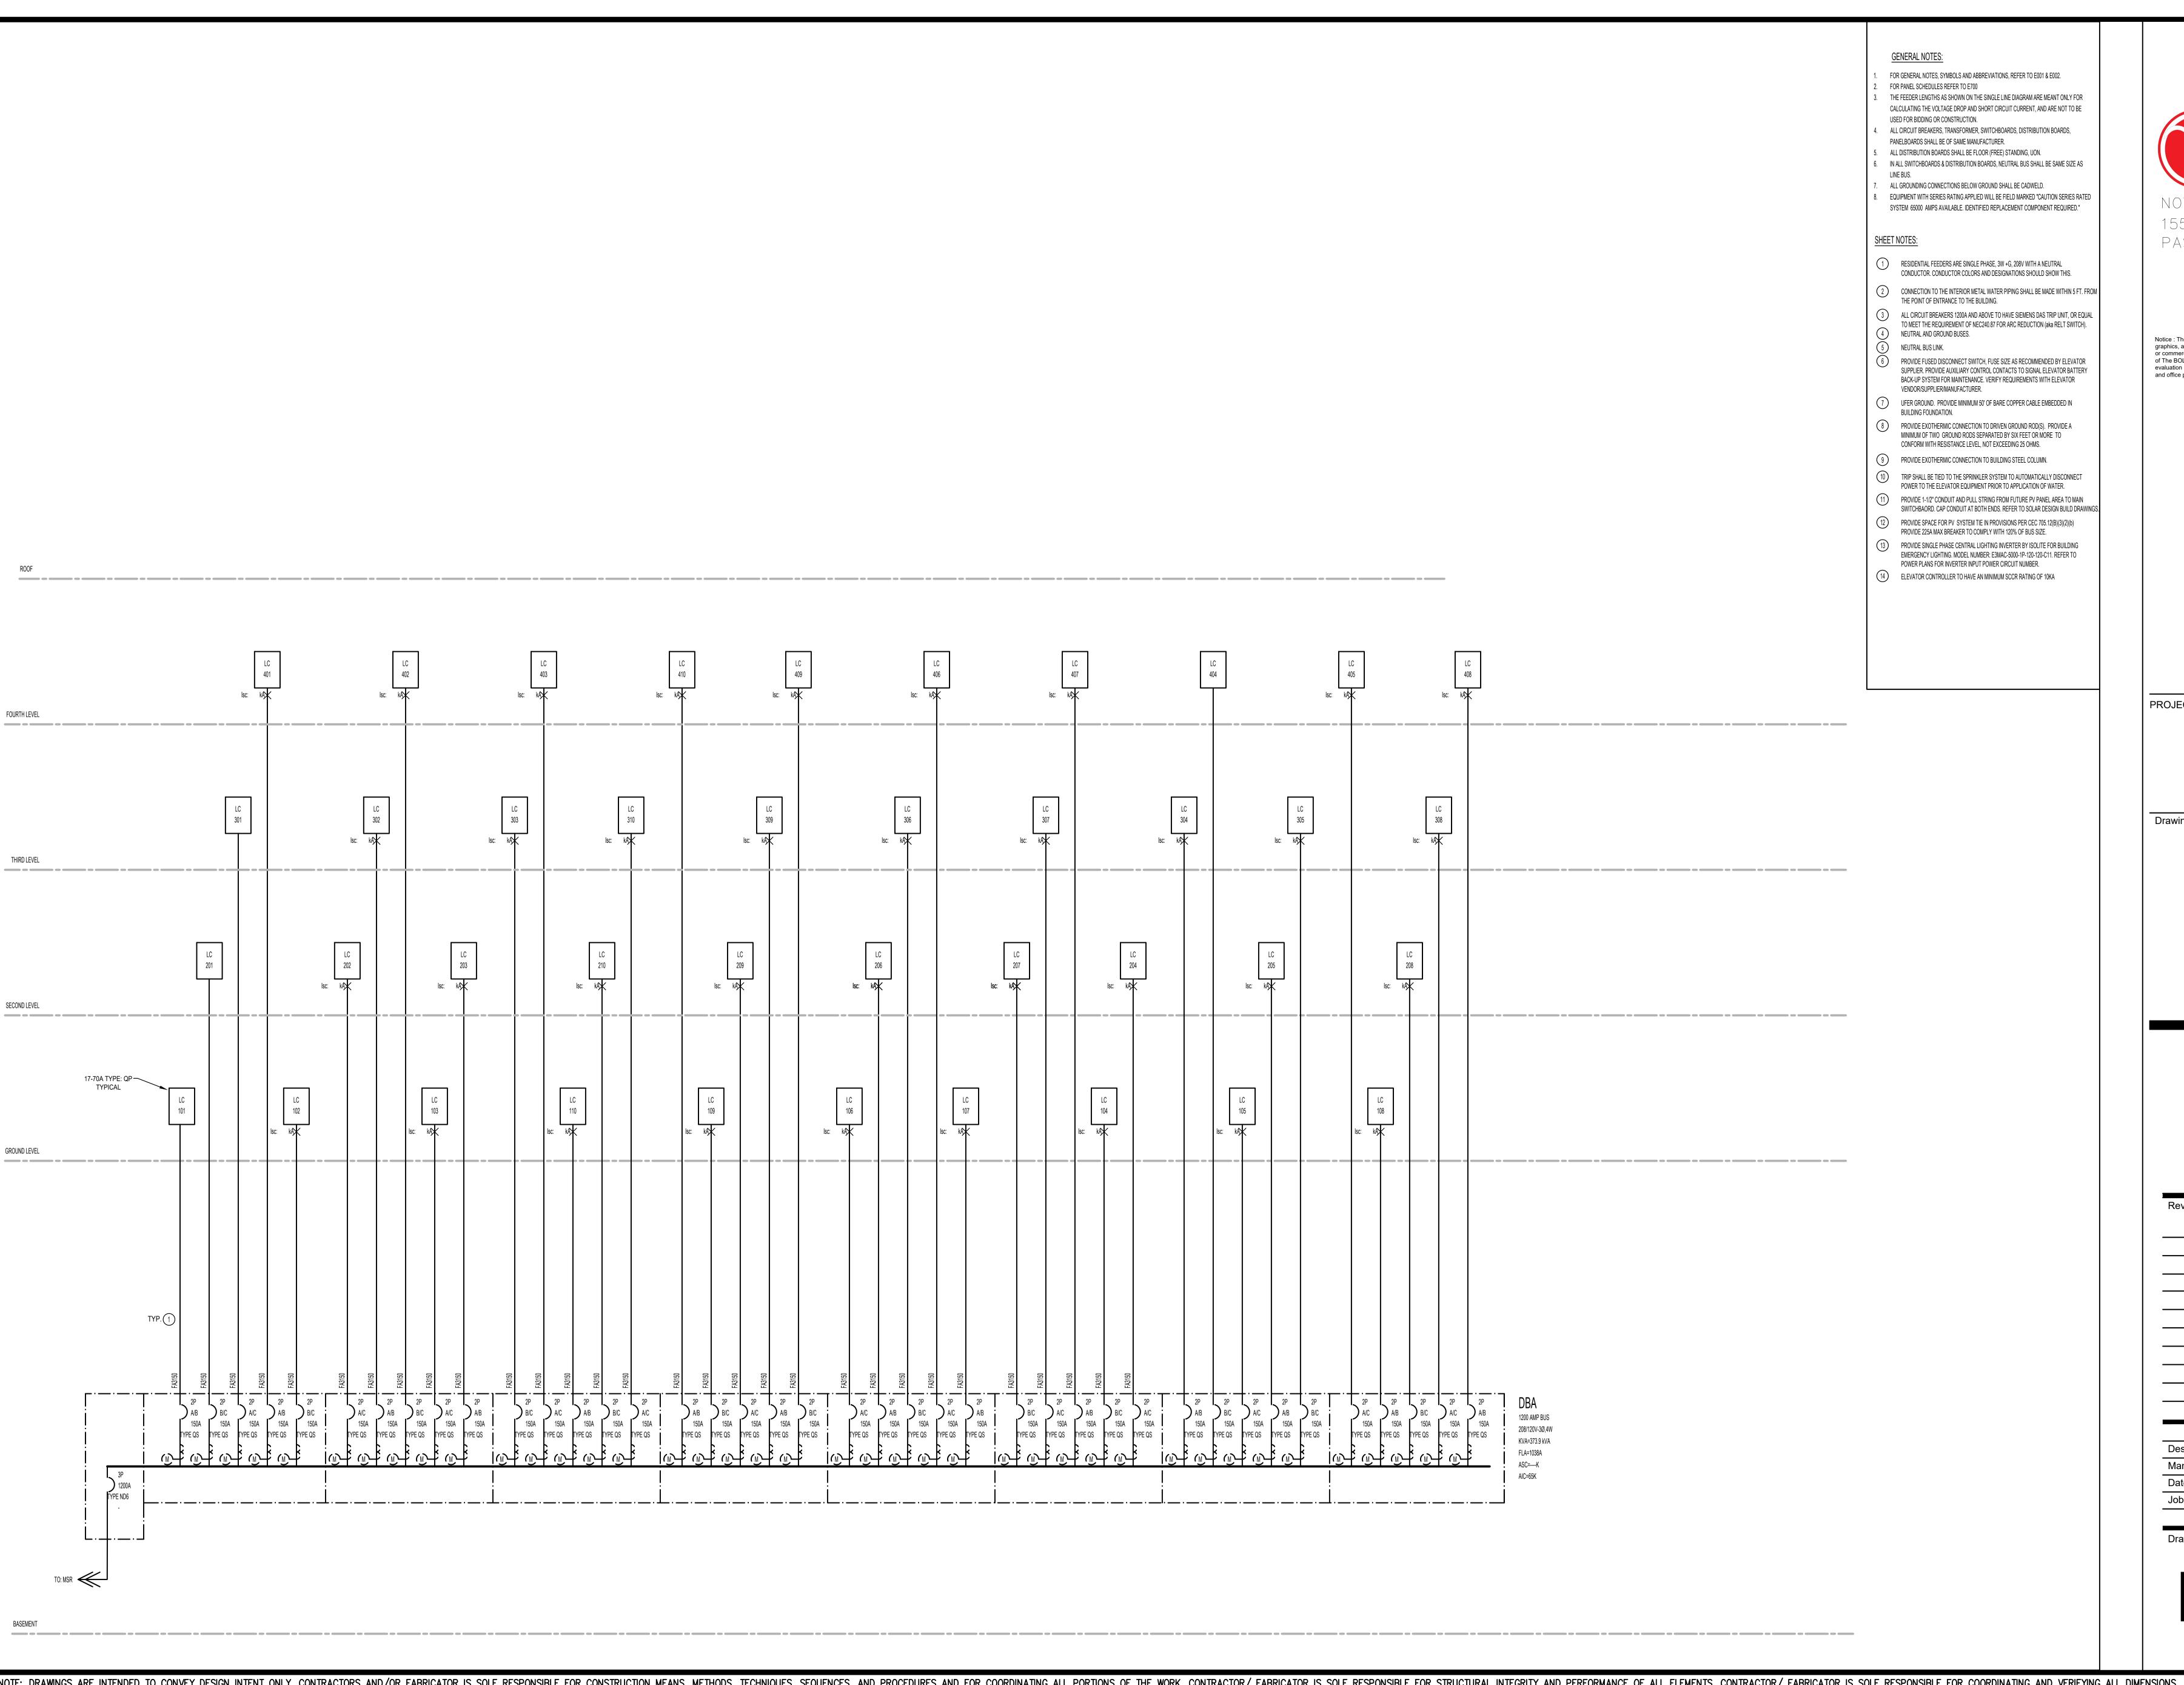

DESIGN STUDIO

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PROJECT NAME & SITE ADDRESS:

MARIPOSA GARDENS 910 S. MARIPOSA ST

BURBANK, CA 91506

Drawing Content:

ELECTRICAL SINGLE LINE DIAGRAM

Revisions: Date:

Designer: JPB


Manager: FF

Date: 10-4-2024

Job No: 23-111-MAR

Drawing No :

E-6.2

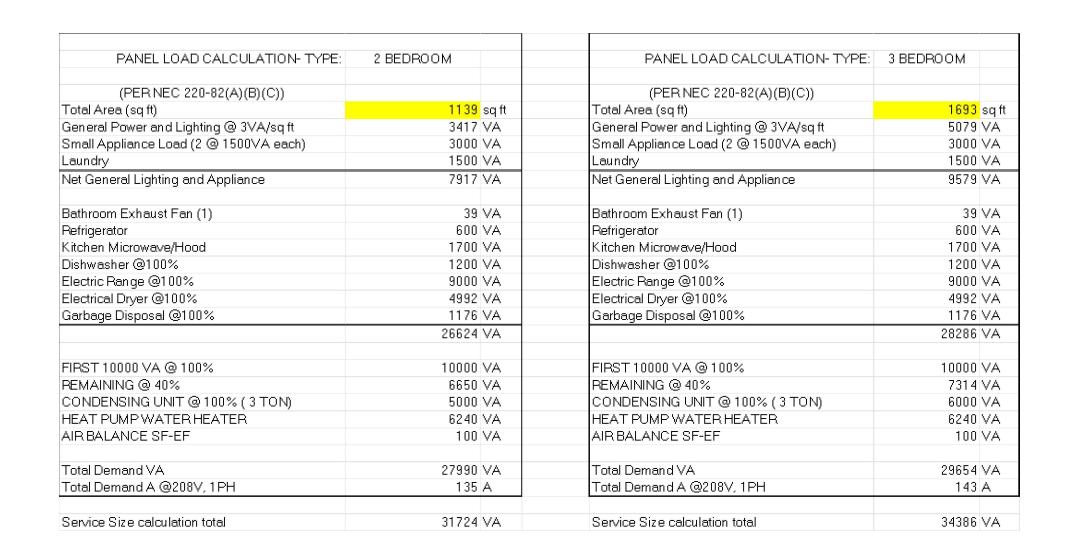


1 RESIDENTIAL DWELLING UNIT LOAD CALCULATIONS

E# SCALE: NOT TO SCALE

MSA	-		-									
	Load	Designation			Total kVA per Unit Type							
DBA (@28% NEC 22	20.84 Demand)				373.2 KVA		RESIDENTIAL EV CHARGING STA	TIONS				
ELEVATOR (@ 20H					22.4 KVA		TOTAL NUMBER OF RESIDENTIAL PAR	KING SPACES:	45	QTY		kVA
HOUSE LOADS					75.0 KVA							
PANEL EV (ELECTR	RIC VEHICLE CHARGING STA	TIONS)			105 KVA		EV CHARGER		15%		7	4:
SP-1 (2@7.5 HP)					18.2 KVA		LOW POWER LEVEL 2 EV READY		40%		18	60
SE-1 (2@ 5 HP)					12.6 KVA		TOTAL:					109
GEF (1@ 5 HP)					6.3 KVA							
GEF (1@ 5 HP)					6.3 KVA							
POOL EQUIPMENT					30.0 KVA							
LID CISTERNS (1@) 5 HP)				6.3 KVA							
Total Conn. Load					655.2 KVA							
25% LCL					26.2 KVA							
25% LML					5.6 KVA							
TOTAL DEMAND LO					687 KVA							
TOTAL DEMAND LO	OAD (AMPS @ 208V)				1903 A		2000A SERVICE AT120/208V					
DBA												
DB/(1					
	UNIT DESIGNATION	Number of Units LEVEL 1	Number of Units LEVEL 2	Number of Units LEVEL 3	Number of Units LEVEL 4	Number of Units LEVEL 5	kVA Per Unit		kVA All Units			
	2 BEDROOM	9	9	9	4			31.7 KVA	983.4 KVA			
	3 BEDROOM	1	1	1	6			34.4 KVA	309.5 KVA			
Number of Units serv	ed:							40				
Subtotal Residential	Connected Load							1332.9 KVA				
Demand factor (Tabl	e 220.84)							28%				
Subtotal Residential	Demand Load							373.2 KVA				
Total Conn. Load (k\	/A)							373.2 KVA				
Total Conn. Load (Al	MPS @ 208V)							1036 A				

2 RESIDENTIAL SERVICE LOAD CALCULATIONS

E# SCALE: NOT TO SCALE

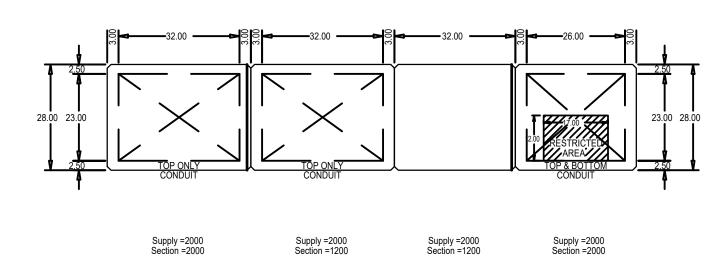

UTILITY CO. : BURBANK WATER POWER

T COMPARTMENT


INE TERMINATION

METER PLATES


SMM METERING

	Section =2000 Neutral =2000 SUSE UL	Section =1200 Neutral =1200 UL	Section =1200 Neutral =1200 UL	Section =2000 Neutral =2000 UL
90.00"	10.0		10.0	SIEMENS 7.5
80.00"	SIEMENS	AUX/METER COMPARTMENT	BURBANK WATER POWER CT COMPARTMENT (PROVISION)	UNIT SPACE
70.00"	20.0	20.0 #5	15.0	UNIT SPACE
60.00"	20.0	20.0 #5	150 SEE TABLE	UNIT SPACE
50.00"		DAS	15.0 SEE TABLE	10.0 UNIT SPACE
40.00"	20.0			10.0 UNIT 5.0 SPACE 3.75
30.00"	DAS FEID			5.0
20.00"		30.0	30.0	6.25
10.00"	30.0	10.0	10.0	5.0 NEUTRAL 75.0 2.5
0.00	10.0	10.0 SECTION# 2	10.0 SECTION# 3	SECTION# 4
	SECTION# 1 EST. WEIGHT: 995.0	EST. WEIGHT: 690.0 38.00 BASIS OF DESIGN	EST. WEIGHT: 585.0	EST. WEIGHT: 795.0


_	3	MSA ELEVATION
	- E#	SCALE: NOT TO SCALE

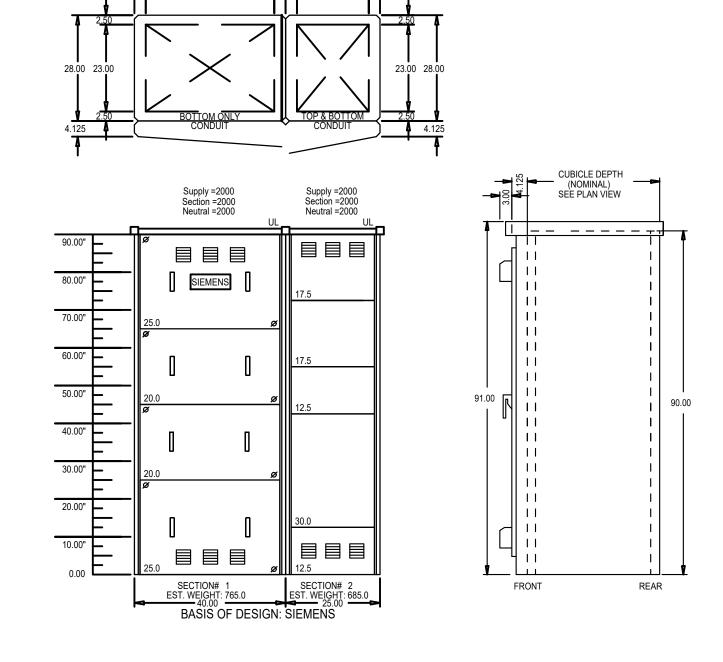

_	4	PS ELEVATION
_	E#	SCALE: NOT TO SCALE

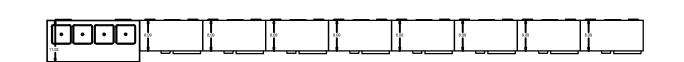

Mit bills CL Line (n) 5 Typ. Mit bills CL Lin

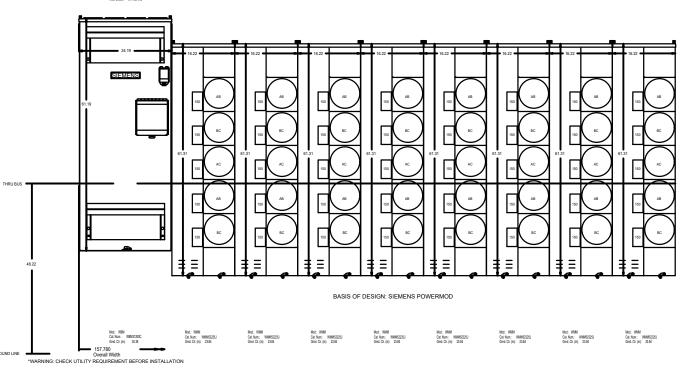

ı	5	DBA ELEVATION
	E#	SCALE: NOT TO SCALE



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PROJECT NAME & SITE ADDRESS:

MARIPOSA GARDENS
910 S. MARIPOSA ST

BURBANK, CA 91506

Drawing Content :

ELECTRICAL LOAD CALCULATIONS AND ELEVATIONS

Date :

Designer: JPB

Manager: FF

Date: 10-4-2024

Job No: 23-111-MAR

Drawing No :

E-6.3