



BOBHOPECENTER -RESIDENTIAL at 3201 W OLIVE AVE. BURBANK, CA 91505

PLANNING DEVELOPMENT STANDARDS SUBMITTAL - 01.04.24

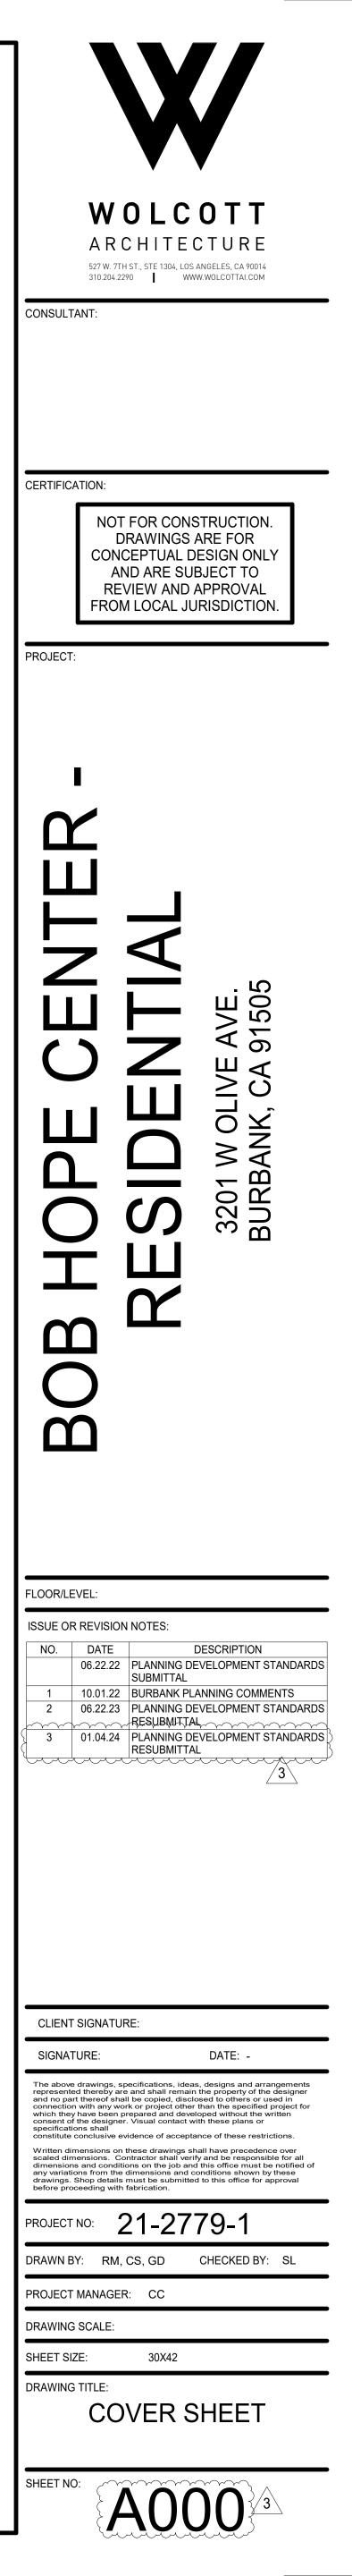

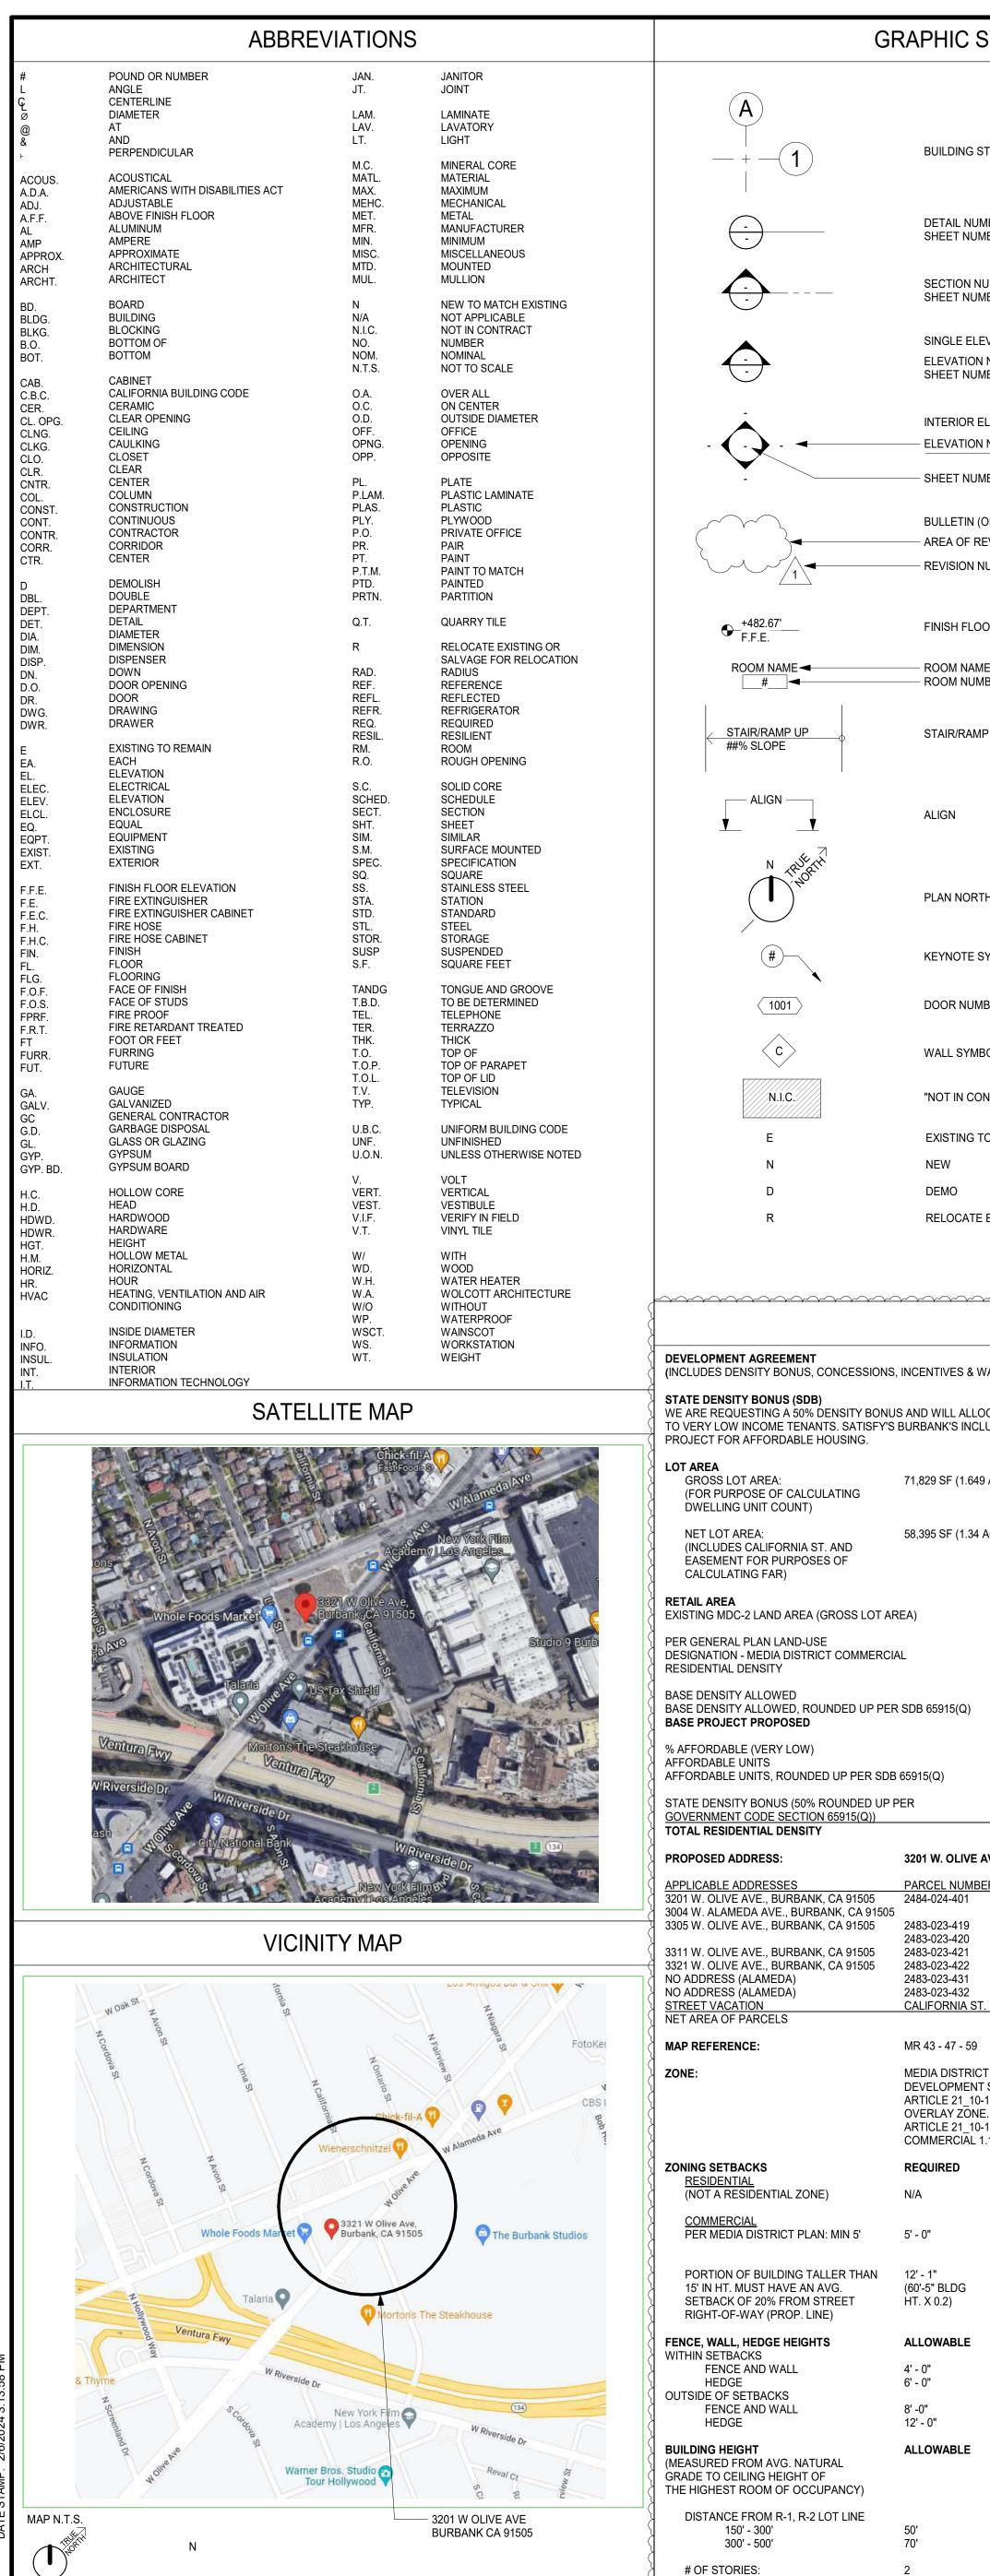


					<u></u>		
SYMBOLS	PROJECT TE	AM			SHEET IN		
STRUCTURAL GRID LINES	WOLCOTT ARCHITECTUREWO1708 N. ALEXANDRIA AVE100LOS ANGELES, CA 90027SANPHONE: 310.204.2290PHOEMAIL: SPADDOCK@WOLCOTTAI.COMEMA	IENT: RTHE REAL ESTATE GROUP WILSHIRE BLVD SUITE 2100 ITA MONICA, CA 90401 DNE: 310.393.9653 AIL: JADENR@WORTHE.COM NTACT: JADEN ROBBINS	DRAWING NUMBER	DRAWING TITLE	PLANNING DEV. STANDARDS SCHEMATIC DESIGN DESIGN DEVELOPMENT CONSTRUCTION DOCUMENT		
MBER MBER	SECONDARY: ROBBIE MEHRING EMAIL: RMEHRING@WOLCOTTAI.COM		ARCHITECTURA A000	COVER SHEET	•		
UMBER MBER	CIVIL:		A001 A002 A100	PROJECT DATA PROJECT REVISIONS EXISTING SITE PLAN	•		
EVATION IDENTIFICATION:	PSOMAS 555 FLOWER ST.		A110 A111 A200	SITE PLAN - PROPOSED AVERAGE SETBACK DIAGRAM FLOOR PLAN - 1ST FLOOR	•		
I NUMBER MBER	SUITE 4300 PHONE: 661.705.4410		A201 A202	FLOOR PLAN - 2ND FLOOR FLOOR PLAN - 3RD-5TH FLOORS ROOF PLAN	•		
	EMAIL: JEREMY.JOHNSON@PSOMAS.COM CONTACT: JEREMY JOHNSON		A203 A204 A205	FLOOR PLAN - P-1 FLOOR PLAN - P-2	•		
I NUMBER MBER	LANDSCAPE:		A206 A207 A300	RCP P-1 RCP P-2 EXTERIOR ELEVATIONS	•		
OR ADDENDUM):	GLLB STUDIO -		A301 A302 A303	ENLARGED EXTERIOR ELEVATIONS ENLARGED EXTERIOR ELEVATIONS ENLARGED EXTERIOR ELEVATIONS	•		
EVISION NUMBER	LOS ANGELES, CA PHONE: 310.625.2029		A400 A410 A600	BUILDING SECTIONS ENLARGED SECTIONS ENLARGED PLANS - TYP. UNITS	•		
	EMAIL: EGIBSON@GLLBSTUDIO.COM CONTACT: ERIC GIBSON		A601 A602	ENLARGED PLAN 1ST FLOOR - AREA A ENLARGED PLAN 1ST FLOOR - AREA B ENLARGED PLAN 2ND FLOOR - AREA A	•		
OR ELEVATION SYMBOL			A603 A604 A605	ENLARGED PLAN 2ND FLOOR- AREA B ENLARGED PLAN 3RD-5TH FLOORS - A	•		
1E IBER			A606 A607 A710	ENLARGED PLAN 3RD-5TH FLOORS - B ENLARGED PLAN - FEATURE WALL SCHEDULE - FINISH AND FIXTURE	•		
P DIRECTION: ARROW POINTS UP			A900 A901	SITE CONTEXT PHOTOS VIEWS AND IMAGES	•		
			CIVIL C000	CIVIL DRAWING PACKAGE	•		
			LANDSCAPE L1.0	OVERALL LANDSCAPE CONCEPT PLAN	•		
			L1.1 L1.2 L1.3	HARDSCAPE CONCEPT PLAN LANDSCAPE ELEVATIONS CONCEPTUAL PLANTING PLAN	•		
TH REFERENCE			L1.4 L1.5	PLANT IMAGES PLANT IMAGES	•		
SYMBOL	PROJECT DESCI		}				
IBER	SCOPE OF WORK:						
BOL TYPE	LOCATED AT 3201 W. OLIVE AVE., ALSO KNOWN AS THE BOB HOPE CONSISTING OF A NEW CONTEMPORARY STYLE MULTI-STORY RES UNITS, INCLUDING POOL AND GYM AMENITIES, AS WELL AS A COMM	DENTIAL APARTMENT BUILDING OF 144 LIVING					
NTRACT": NO WORK IN THIS AREA	VACANT LOT. THE LIVING UNITS WILL BE A MIX OF STUDIO, 1-BEDRO		}				
TO REMAIN			> } }				
EXISTING/SALVAGE FOR RELOCATION (AT DEMO PLAI	N)						
) } }				
BURBANK PLAI							
VAIVERS PER BMC PLANNED DEVELOPMENT)	LOT COVERAGE: ALLOWABLE PR (INCLUDES GARAGE RAMP AREA) 35,037 SF (60%) 29	OPOSED 424 SF	<pre>}</pre>				
	FLOOR AREA RATIOALLOWABLEPR(USING NET LOT AREA AND LIMITED TO COMMERCIAL & ANOLU ARE FOOTAGE1.1 FAR0.0	OPOSED 2 FAR 058 SF RETAIL / 58,395 SF)					
	TOTAL BUILDING AREAPROPOSED(EXCLUDES SHAFTS & STAIRS)1,058 SF		}		~~~~~~~~~~~~~~~~~~~~~~~~~~~~~~~~~~~~~~		~~~~~~
ACRES)	RESIDENTIAL 130,666 SF TOTAL 131,724 SF					58°W, B 1618 PG 296 58°W, B 1618 PG 296 59°35°E 393.18 NT. 1618 PG 30'25"W ON CL PWFB 1618 PG 30'25"W	
	UNIT COUNT: <u>1ST 2ND 3RD 4TH 5TH TOTAL PERCE</u>	NTAGES				ENUE RAU NGO FD SA ST. THE AND SA SA ST. THE AND SA SA ST. THE AND SA ST. THE AND SA SA ST. THE AND SA	
1,058 SF 1.65 ACRES (71,829 SF)	2BR:669993927.1%1BR:12201616168055.6%STUDIO:465552517.4%			-DA		12 12 12 12 12 12 12 12 12 12 12 12 12 1	e.
58 DU/ACRE	TOTAL: 22 32 30 30 30 144			WEST ALAMEDA		SCAN SCOTT TO BT 2	
95.64 DU	ALLOCATES 15 UNITS AS VERY LOW INCOME (15% PER SDB) MARKET RATE UNITS INCLUDE ONE ON-SITE RESIDENT MANAGER UNIT. FIFTEEN UNITS WILL BE DEED-RESTRICTED AFFORDABLE HOUSING UNITS (VERY LOW INCOME) FOR 55 YEARS.		52 WILL 329.96'	X COME PARTY OF	30 15 ORDER NO. 0046176-01 1 30 4 54 700.	
15%	VEHICLE PARKING: NOTE: ZERO PARKING REQUIRED PER SB35 AS PROJECT IS WITHIN ONE-HA	I F MILF OF TRANSIT		FD 586W, B 334, PG 142 EN66'59	R ¹ (40.02'	CHO PROVIDENCE EL PRESE PRESE ON SO.	/
15 DU	USE FORMULA UNIT COUNT/SF REQ'D (ZERO REQ'D PER	SB-35 AS PROJECT PROPOSED		PER PER PUR OVERHEAD MIG6 59 32	SIGN THE RASE	BIK 43 BILOCIK 63 BILOCIK 63 LOT 1 BILOCIK 63 LOT 1 BILOCIK 63 BILOCIK 64 BILOCIK 64 BIL	
	RETAIL3.3 PER 1,000SF1,058 SFIS WITHIN 1/2 MILE OF TR/ 0RESIDENTIAL0.5 PER UNIT144 UNITS0	4 STALLS 177 STALLS		N66"59"35"E 330.00 AL N66"59"35"E 330"AL N66"59"35"E 330"AL N77"AL N66"59"35"E 330"AL N77"AL	P.N. 2483-023-432 224 SQ. FT.	83.023.419 8 420 83.023.419 8 420 567 5Q. FT. 567 5Q. FT. 507 5Q.	
	TOTAL 0 STALLS	(20 TANDEM=40 STALLS) 181 STALLS		TO FD SUN SINCE PO TO FD SUN SINCE W/ AVON B 1618 PO W/ AVON B 1618 PO TS-MICH	A.P.N ^S 22,5	567 32 1045176-994-X49 10 0 0 0 0 0 0 0 0 0 0 0 0 0 0 0 0 0 0	
22,567 SF		PROPOSED 5 STALLS		PROFILE STATES STATES	2:57'38"E		
2,685 SF		2 STALLS 7 STALLS		60 SIGN & CAR SAUSSAU CONTO 30 A.P.N. 2483.023-44 SOURT 50 10 0 6,848 SOURT 50 10 0	185.81. DIRT	an as can be a first a	
T. 4,414 SF 58,395 SF (1.34 ACRES)	ACCESSIBLE VAN EV STALL 1 STALL BICYCLE PARKING (PER BMC SECTION 10-1-1405.5) REQUIRED	1 STALL PROPOSED		Z 30 0RT 0RT 0RT 0RT 0RT 0RT 0RT 0RT 0RT 0R	21 92 402	A A A A A A A A A A A A A A A A A A A	
T LIMITED COMMERCIAL (MDC-2)	SHORT TERM: RESIDENTIAL (1 SPACE / 20 UNITS) 7.2 RETAIL (1 SPACE / 5000 SF)	7 1		P R CABLER P CARL A. P.N. 2405 SQ. F1. 11,960 SQ. F1. 11,960 SQ. F1. 11,960 SQ. F1. 11,960 SQ. F1.	.994-X49	A A A A A A A A A A A A A A A A A A A	
T STANDARDS BASED ON MDC-2 -1-2101 PURPOSE OF THE MEDIA DISTRICT E. -1-2109.5 MDC-2 ZONE MEDIA DISTRICT	TOTAL: 8.2 (8)	8 SPACES		A PAREL STREET ORDER NO. 0046076- STREET DINY Street Stree	STAN A	Jusé Oliver	
-1-2109.5 MDC-2 ZONE MEDIA DISTRICT 1.1 FAR, 58 UNITS PER ACRE PROPOSED	LONG TERM: RESIDENTIAL (1 SPACE / 4 UNITS) 36 RETAIL: (1 SPACE / 12,000 SF) 1	36 1		Pr J. J. Son of The Property o	in the second	WE OFFER WEST	
N/A	TOTAL: 37 SPACES OPEN SPACE REQUIREMENTS	37 SPACES		THIS S PRIME SOM	\$ 50. 190	INE TYPE LEGEND:	
5' - 0" (APPLIES TO SINGLE STORY RETAIL BUILDING)	(NOT REQ'D IN MDC-2 ZONE) MIN. PRIVATE OPEN SPACE PER UNIT:			SURVER BY-C - CA -	a / 3	So, CENTERLINE	
10' - 1" AVG. BLDG. SETBACK 8' - 0" AVG. OVERHANG / PROJECTION	 (NOT REQ'D IN MDC-2 ZONE) LANDSCAPING (INCLUDES SET BACKS) TO FOLLOW MDC-2 ZONE & BMC SECTION 101-2107(E) REQUIREMENTS . 			TZ BE SIGNAL BE SIGNAL		DESCRIPTION LEGEND:	
PROPOSED	 TO FOLLOW MDC-2 ZONE & BMC SECTION 101-2107(E) REQUIREMENTS & & ARTICLE 5, CHAPTER 3, SUBSECTION 9-3-500 				/	CB CATCH BASIN CONC CONCRETE ELEC ELECTRICAL FD FOUND	
3' - 0" 6' - 0" MAX.						GW GUY WIRE L&T LEAD AND TACK PP POWER POLE	
8' - 0" MAX. 6' - 0" MAX.				58° ~ 50		PLTR/PA PLANTER SMH SEWER MANHOLE SPK&W SPIKE AND WASHER	
ACTUAL				AND SOLUTION		TC TOP OF CURVE W WITH WM WATER METER	
60' - 5"				P.M.		WM WATER METER WV WATER VALVE JBX JUNCTION BOX	_


60' - 5"

5


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I - PROPOSED SETBACK DIAGRAM	•		-		
AN - 1ST FLOOR	•				
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AN - 3RD-5TH FLOORS	•				
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D PLANS - TYP. UNITS	•				
D PLAN 1ST FLOOR - AREA A D PLAN 1ST FLOOR - AREA B	•				
D PLAN 13T FLOOR - AREA B D PLAN 2ND FLOOR - AREA A	•				
D PLAN 2ND FLOOR - AREA A D PLAN 2ND FLOOR- AREA B	•				
D PLAN 3RD-5TH FLOORS - A	•				
D PLAN 3RD-5TH FLOORS - B	•				
D PLAN - FEATURE WALL	•				
E - FINISH AND FIXTURE	•				
TEXT PHOTOS	•				
D IMAGES	•				
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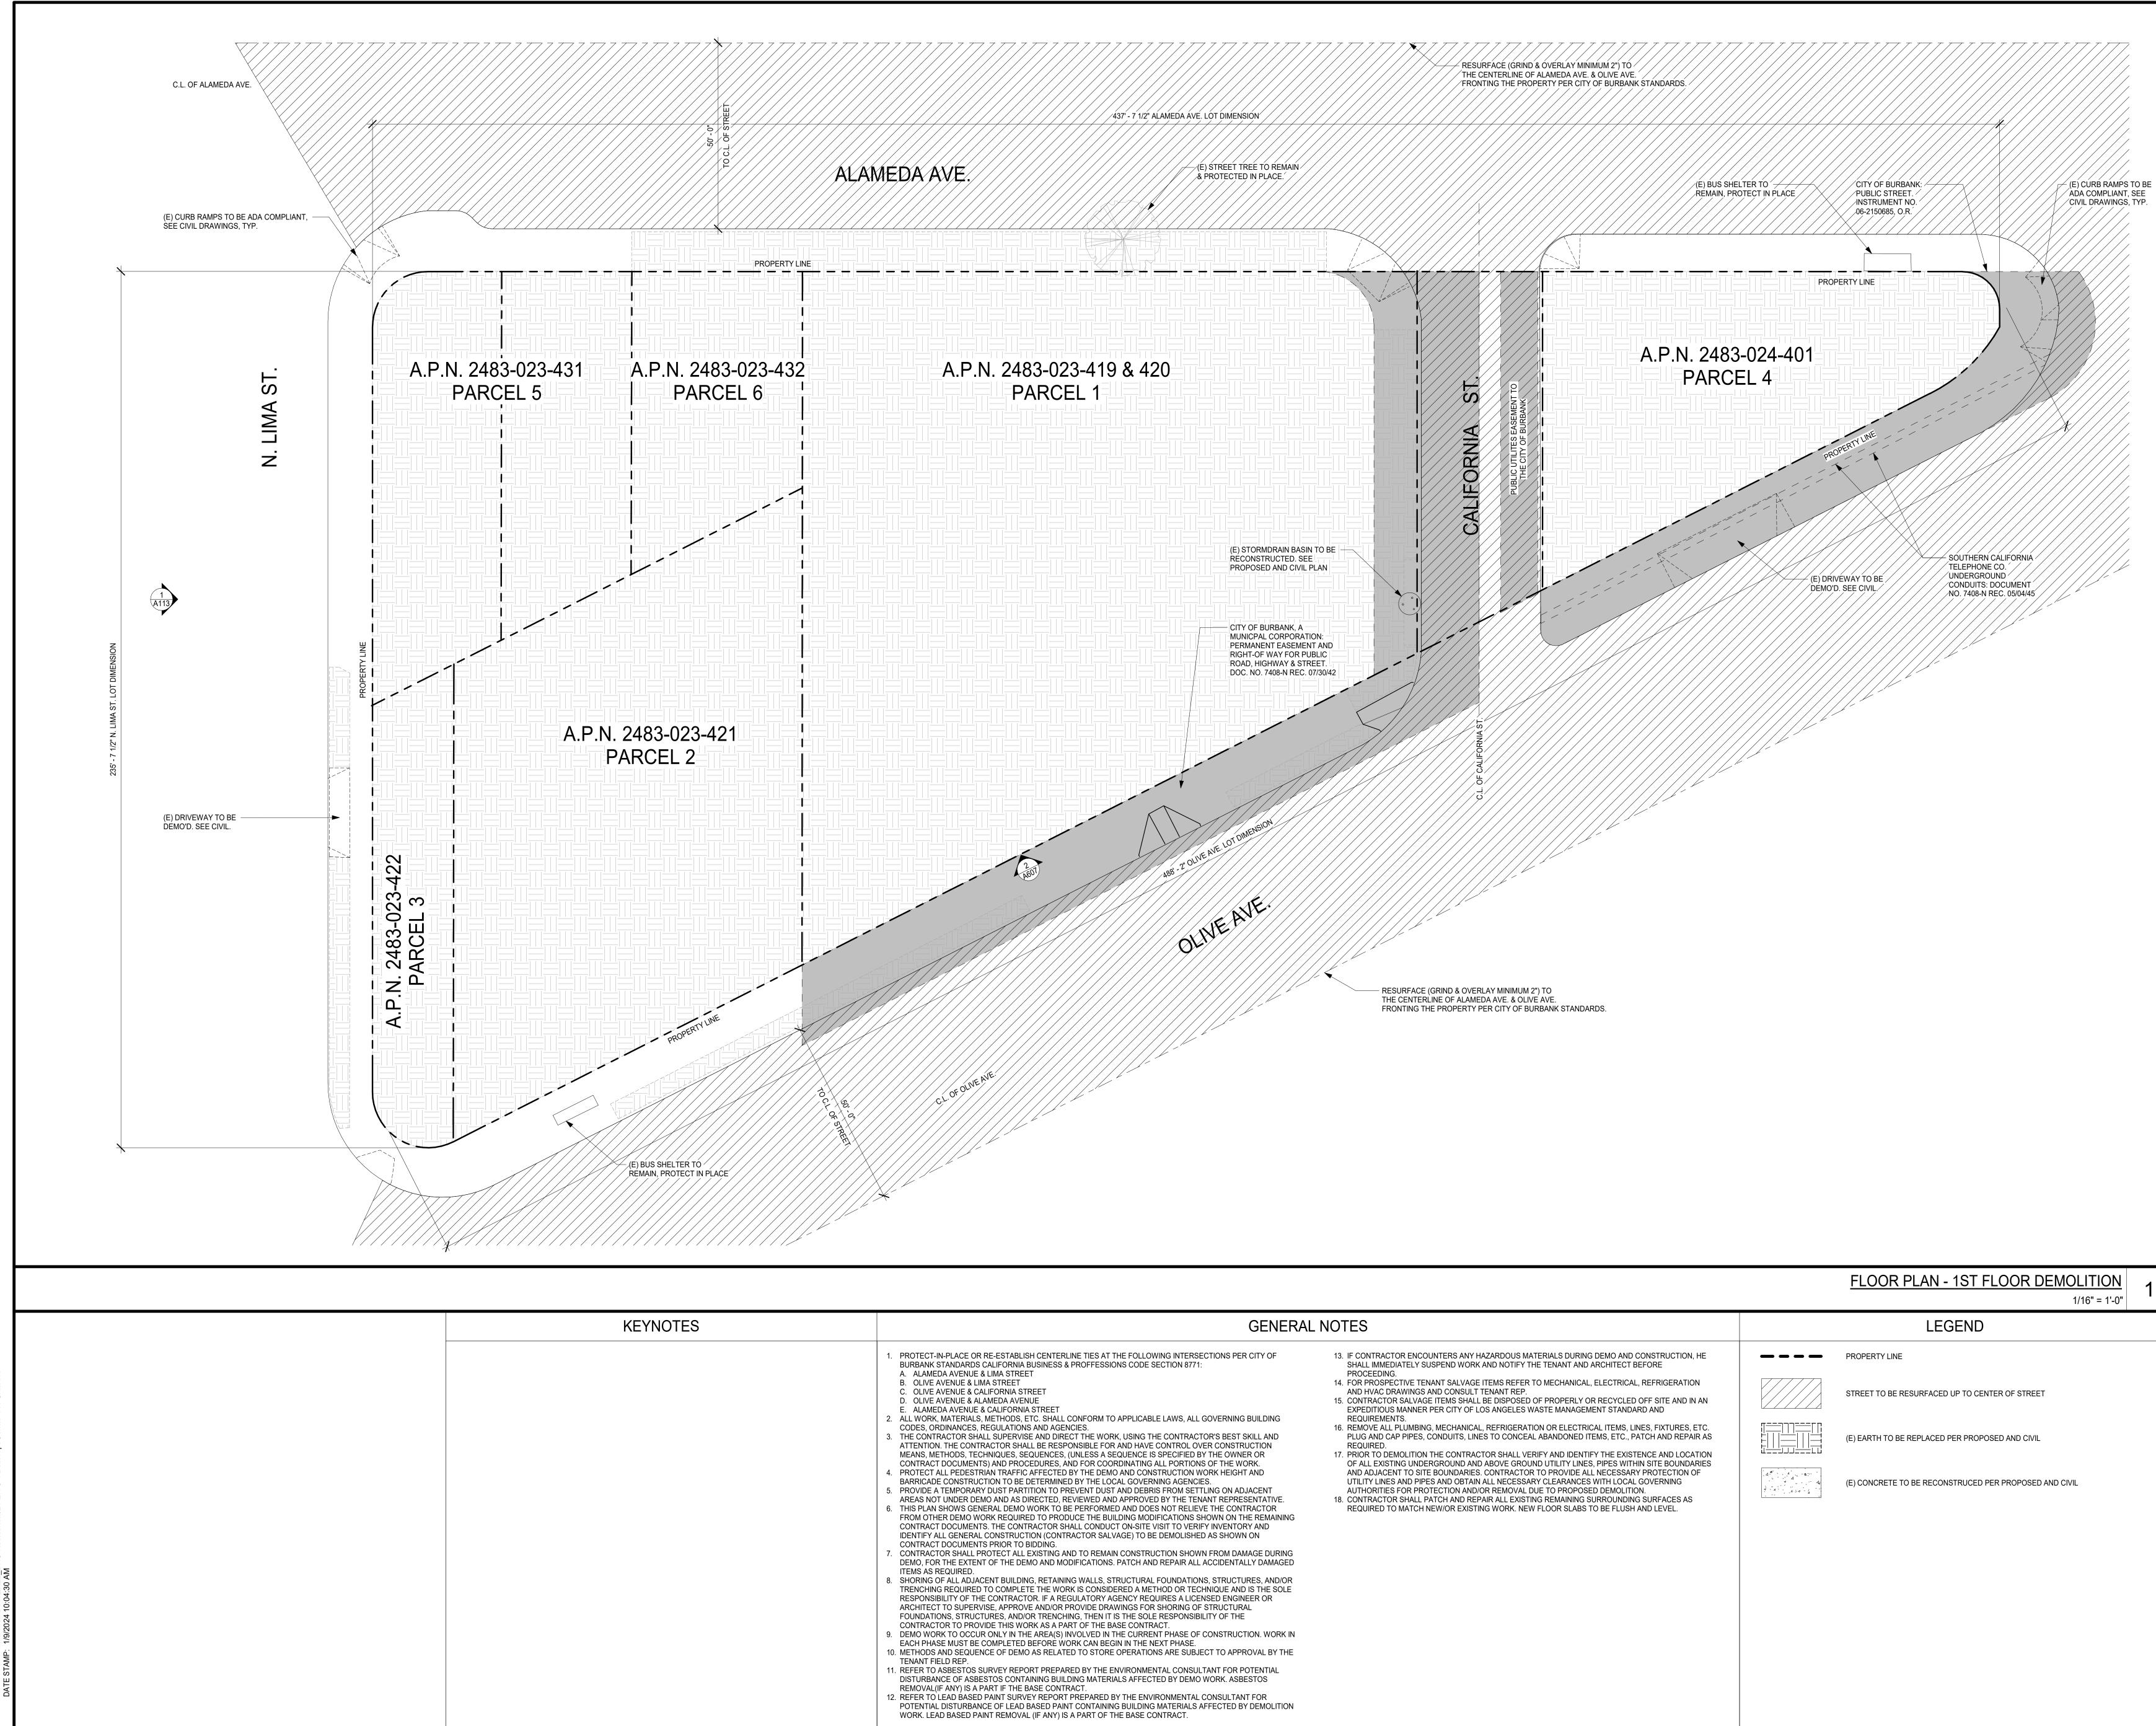


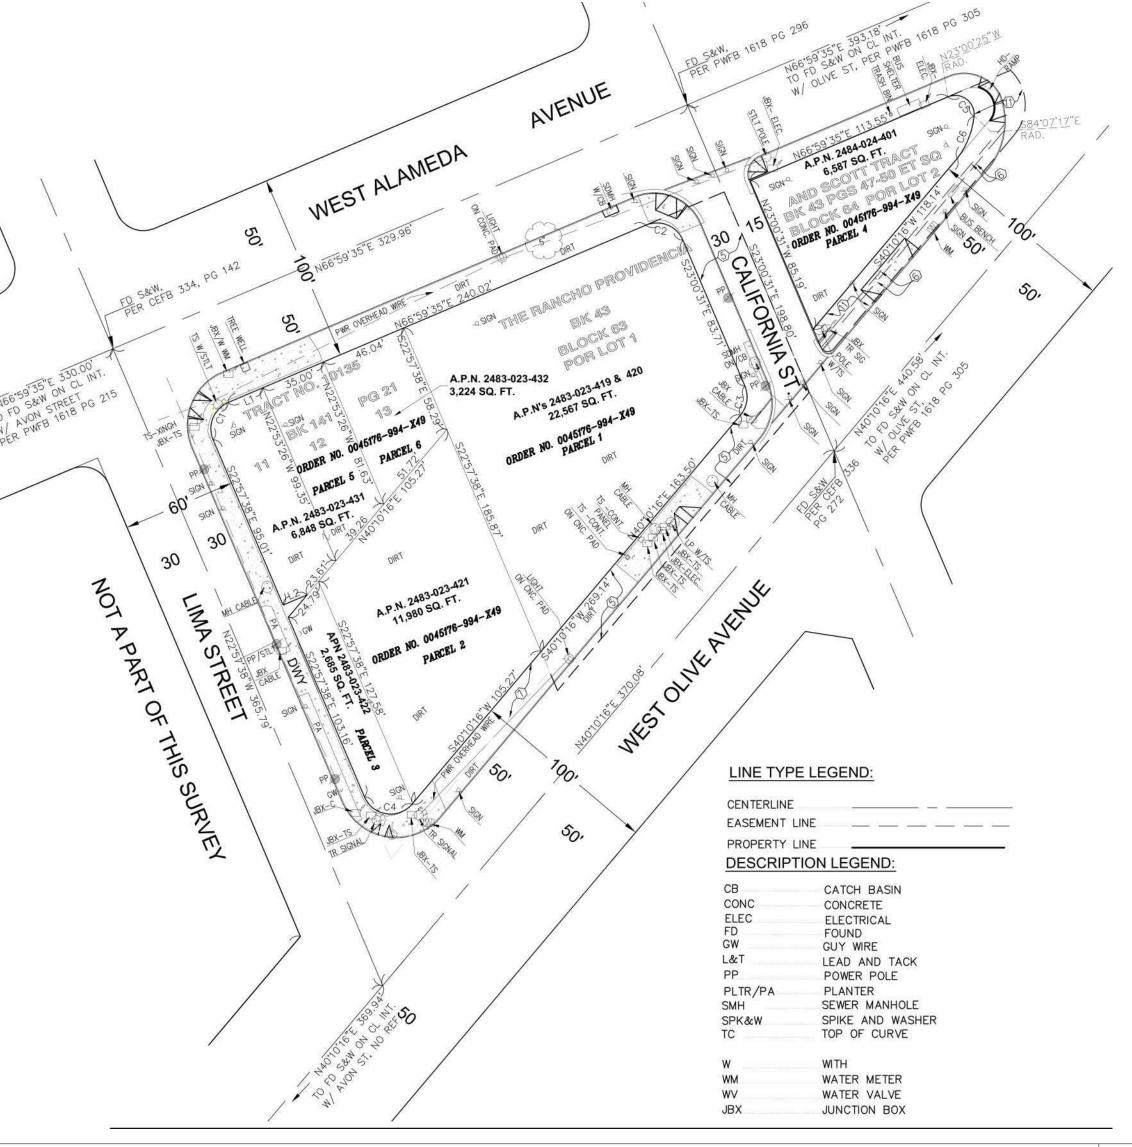SCALE PARCEL MAP (FOR REFERENCE ONLY)

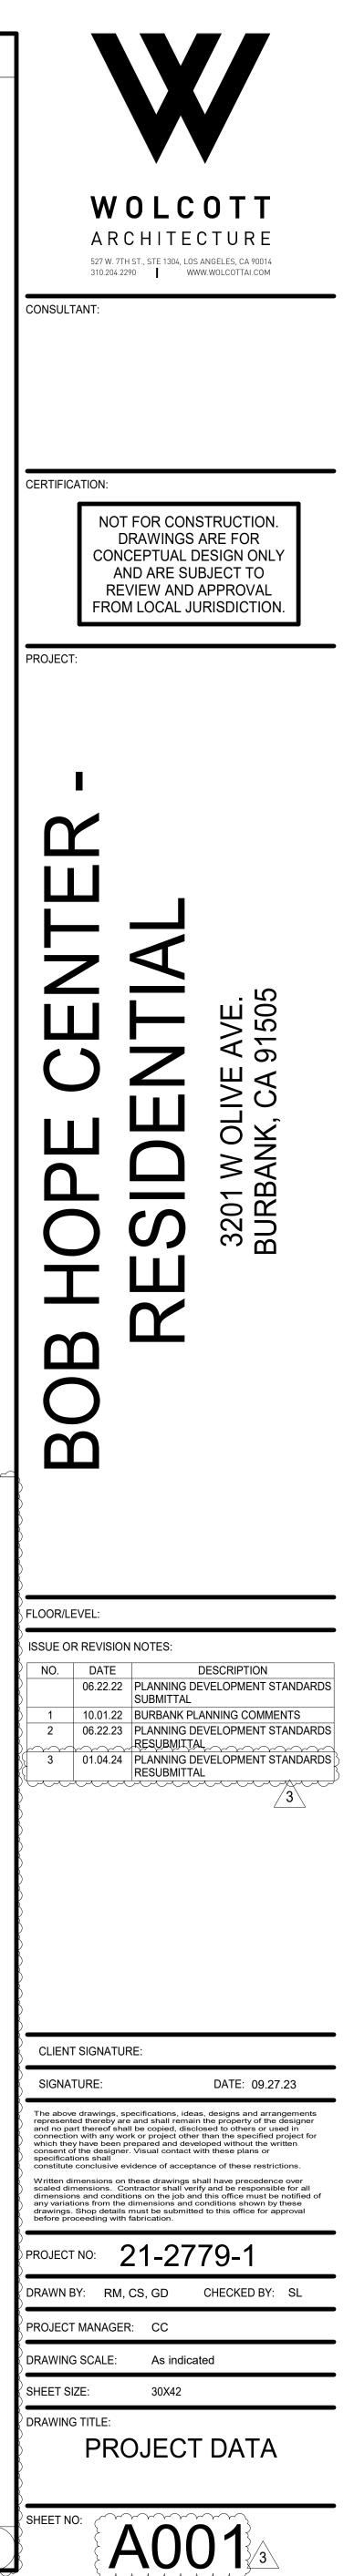

PROJECT REVISION
REVISION #02: PLANNING AND DEVELOPMENT STANDARDS
A000 • UPDATED COVER SHEET TO LATEST SUBMITTAL
 A001 UPDATED PROJECT DATA UNIT COUNTS REMOVED A202 FROM INDEX REVISED CLIENT ADDRESS REVISED PARKING COUNT REQUIREMENTS REVISED BASE DENSITY ALLOWED AND DENSITY BONUS UPDATED SETBACK REQUIREMENTS UPDATED NUMBER OF STORIES
 A002 ADDED PROJECT REVISION SHEET A110 REVISED SIDEWALK TO (E) CONDITION ALONG ALAMEDA AVE. ADDED DOOR TO (N) LEASING OFFICE ALONG ALAMEDA AVE. REVISED TO A 4-STORY APARTMENT BUILDING ADDED TRANSFORMER VAULT LOCATION RECESSED STAIRWAY EXIT DOORS TO COVER DOORWAYS UPDATED SITE TO SHOW LANDSCAPE PER LANDSCAPE DRAWINGS ADDED DESIGN ARTICULATION TO POOL WALL ALONG OLIVE AVE.
A111 • REVISED AVERAGE SETBACK CALCULATIONS BASED ON NEW HEIGHTS
 A200 ADDED LEASING OFFICE AND MAILROOM(RM 128) CHANGED MAINTENANCE ROOM TO ELECTRICAL ROOM(RM 161) AND DATA ROOM(RM133) REVISED "STAIR-A" FOOTPRINT REVISED TRASH ENCLOSURE, CHUTES, AND ADDED TRASH ENCLOSURE VESTIBULE ADDED TRANSFORMER VAULT LOCATION REMOVED (5) STUDIO UNITS AND (1) 1-BEDROOM AND ADDED (2) 2-BEDROOM UNITS A201 REMOVED (2) 1-BEDROOM UNITS AND ADDED (1) 2-BEDROOM UNIT ADDED TRASH ENCLOSURE ROOM ADDED TRASH ENCLOSURE ROOM ADDED TRASH ENCLOSURE ROOM ADDED BALCONIES TO UNITS 221, 227, AND 204 ADDED ADOF DRAIN TO RETAIL REVISED LAYOUT ON UNITS: UNIT 203, 212, 215, 217, 219, AND 224 A203 CHANGED ROOF DRAIN TYPE TO HAVE BOTH PRIMARY AND OVERFLOW DRAINS AS ONE TYPE. ADDED 5-6" RETURN TO CANOPY A204 & A205 RELOCATED STAIR NO. 01 TO ALIGN W/ STAIRCASE ON LEVELS 2-4
 A300 REMOVED 5TH FLOOR REVISED LEVEL HEIGHTS TO HAVE 10°-06" FLOOR TO FLOOR HEIGHT ON LEVELS 2-4 ADDED ELEVATION LOCATION MARKERS ADDED BALCONIES TO UNITS, SEE A201 FOR LOCATIONS ON PLAN A301-A303 UPDATED GLAZING PANEL LOCATIONS AND DIMENSIONS REVISED LEVEL HEIGHTS TO HAVE 10°-06" FLOOR TO FLOOR HEIGHT ON LEVELS 2-4 REMOVED 5TH FLOOR A400-A410 REVISED LEVEL HEIGHTS TO HAVE 10°-06" FLOOR TO FLOOR HEIGHT ON LEVELS 2-4 REMOVED 5TH FLOOR A601-A604 UPDATED ENLARGED PLANS WITH REVISED LAYOUT PER A200 AND A201 A901 UPDATED RENDERS PER REMOVAL OF 5TH FLOOR




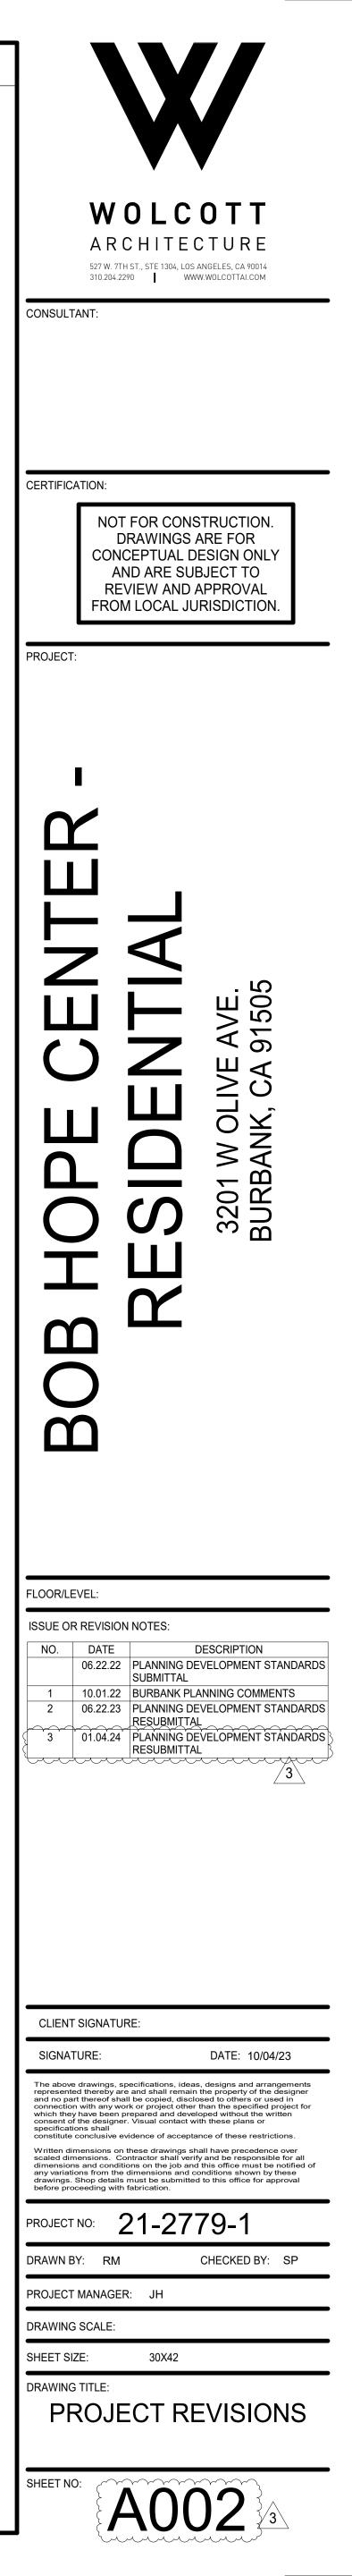

NOTES	GENERAL	NOTES
	 PROTECT-IN-PLACE OR RE-ESTABLISH CENTERLINE TIES AT THE FOLLOWING INTERSECTIONS PER CITY OF BURBANK STANDARDS CALIFORNIA BUSINESS & PROFFESSIONS CODE SECTION 8771: ALAMEDA AVENUE & LIMA STREET OLIVE AVENUE & LIMA STREET OLIVE AVENUE & ALMA STREET OLIVE AVENUE & CALIFORNIA STREET ALMEDA AVENUE & ALMACDA AVENUE E. ALAMEDA AVENUE & CALIFORNIA STREET ALL WORK, MATERIALS, METHODS, ETC. SHALL CONFORM TO APPLICABLE LAWS, ALL GOVERNING BUILDING CODES, ORDINANCES, REGULATIONS AND AGENCIES. THE CONTRACTOR SHALL SPREYSE AND DIRECT THE WORK, USING THE CONTRACTOR'S BEST SKILL AND ATTENTION. THE CONTRACTOR SHALL BE RESPONSIBLE FOR AND HAVE CONTROL OVER CONSTRUCTION MEANS, METHODS, TECHNIQUES, SEQUENCES, UNLESS A SEQUENCE IS SPECIFIED BY THE IDON AND CONSTRUCTION WORK HEIGHT AND BARRICADE CONSTRUCTION TO BE DETERMINED BY THE LOOM AND CONSTRUCTION WORK HEIGHT AND BARRICADE CONSTRUCTION TO BE DETERMINED BY THE LOOM AND CONSTRUCTION WORK HEIGHT AND BARRICADE CONSTRUCTION TO BE DETERMINED BY THE LOOM AND CONSTRUCTION WORK HEIGHT AND BARRICADE CONSTRUCTION TO BE DETERMINED BY THE LOOM AND CONSTRUCTION WORK HEIGHT AND BARRICADE CONSTRUCTION TO BE DETERMINED BY THE LOOM AND CONSTRUCTION WORK HEIGHT AND BARRICADE CONSTRUCTION TO BE DETERMINED BY THE LOW AND AGENOTES. PROVIDE A TEMPORARY DUST PARTITION TO PREVENT DUST AND DEBRIS FROM SETTLING ON ADJACENT AREAS NOT UNDER DEMO WORK AND DO PREVENT DUST AND DEBRIS FROM SETUTIVE. THEIN SHOWS GENERAL DEND OWN REDO DO AND AD PROVED BY THE TELINATIVE. ECONTRACTOR FROM OTHER DEMO WORK REQUIRED TO PRODUCE THE BUILDING MALLS. CONTRACTO DOCUMENTS THE CONTRACTOR SALVAGE) TO BE DEMOLISHED AS SHOWN ON CONTRACTO DOCUMENTS THE CONTRACTOR AND ADD TO REMAIN CONSTRUCTIONS SHOWN ON THE REMAINING CONTRACTO DOCUMENTS PRIOR TO REDIDING. CON	 IF CONTRACTOF SHALL IMMEDIAT PROCEEDING. FOR PROSPECT AND HVAC DRAV CONTRACTOR S EXPEDITIOUS M REQUIREMENTS REMOVE ALL PL PLUG AND CAP F REQUIRED. PRIOR TO DEMC OF ALL EXISTING AND ADJACENT UTILITY LINES AI AUTHORITIES FC CONTRACTOR S REQUIRED TO M



CONSULTANT:

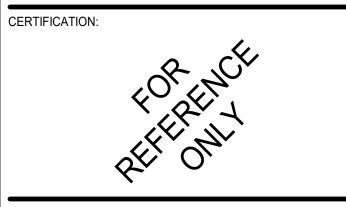


PROJECT:




FLOOR/LEVEL:


ISSUE OF	R REVISION	NOTES:
NO.	DATE	DESCRIPTION
	06.22.22	PLANNING DEVELOPMENT STANDARDS SUBMITTAL
1	10.01.22	BURBANK PLANNING COMMENTS
2	06.22.23	PLANNING DEVELOPMENT STANDARDS RESUBMITTAL
3	01.04.24	PLANNING DEVELOPMENT STANDARDS RESUBMITTAL
	•	·

CLIENT SIGNATURE:	
SIGNATURE:	DATE: 10/02/23
represented thereby are an and no part thereof shall be connection with any work o which they have been preps consent of the designer. Vis specifications shall constitute conclusive evider Written dimensions on thes scaled dimensions. Contra dimensions and conditions any variations from the dim	fications, ideas, designs and arrangements d shall remain the property of the designer e copied, disclosed to others or used in r project other than the specified project for ared and developed without the written sual contact with these plans or nce of acceptance of these restrictions. se drawings shall have precedence over actor shall verify and be responsible for all on the job and this office must be notified of ensions and conditions shown by these at be submitted to this office for approval rication.
PROJECT NO: 21	1-2779-1
DRAWN BY: Author	CHECKED BY: Checker
PROJECT MANAGER:	Designer
DRAWING SCALE:	As indicated
SHEET SIZE:	30X42
DRAWING TITLE:	NG SITE PLAN
SHEET NO:	100

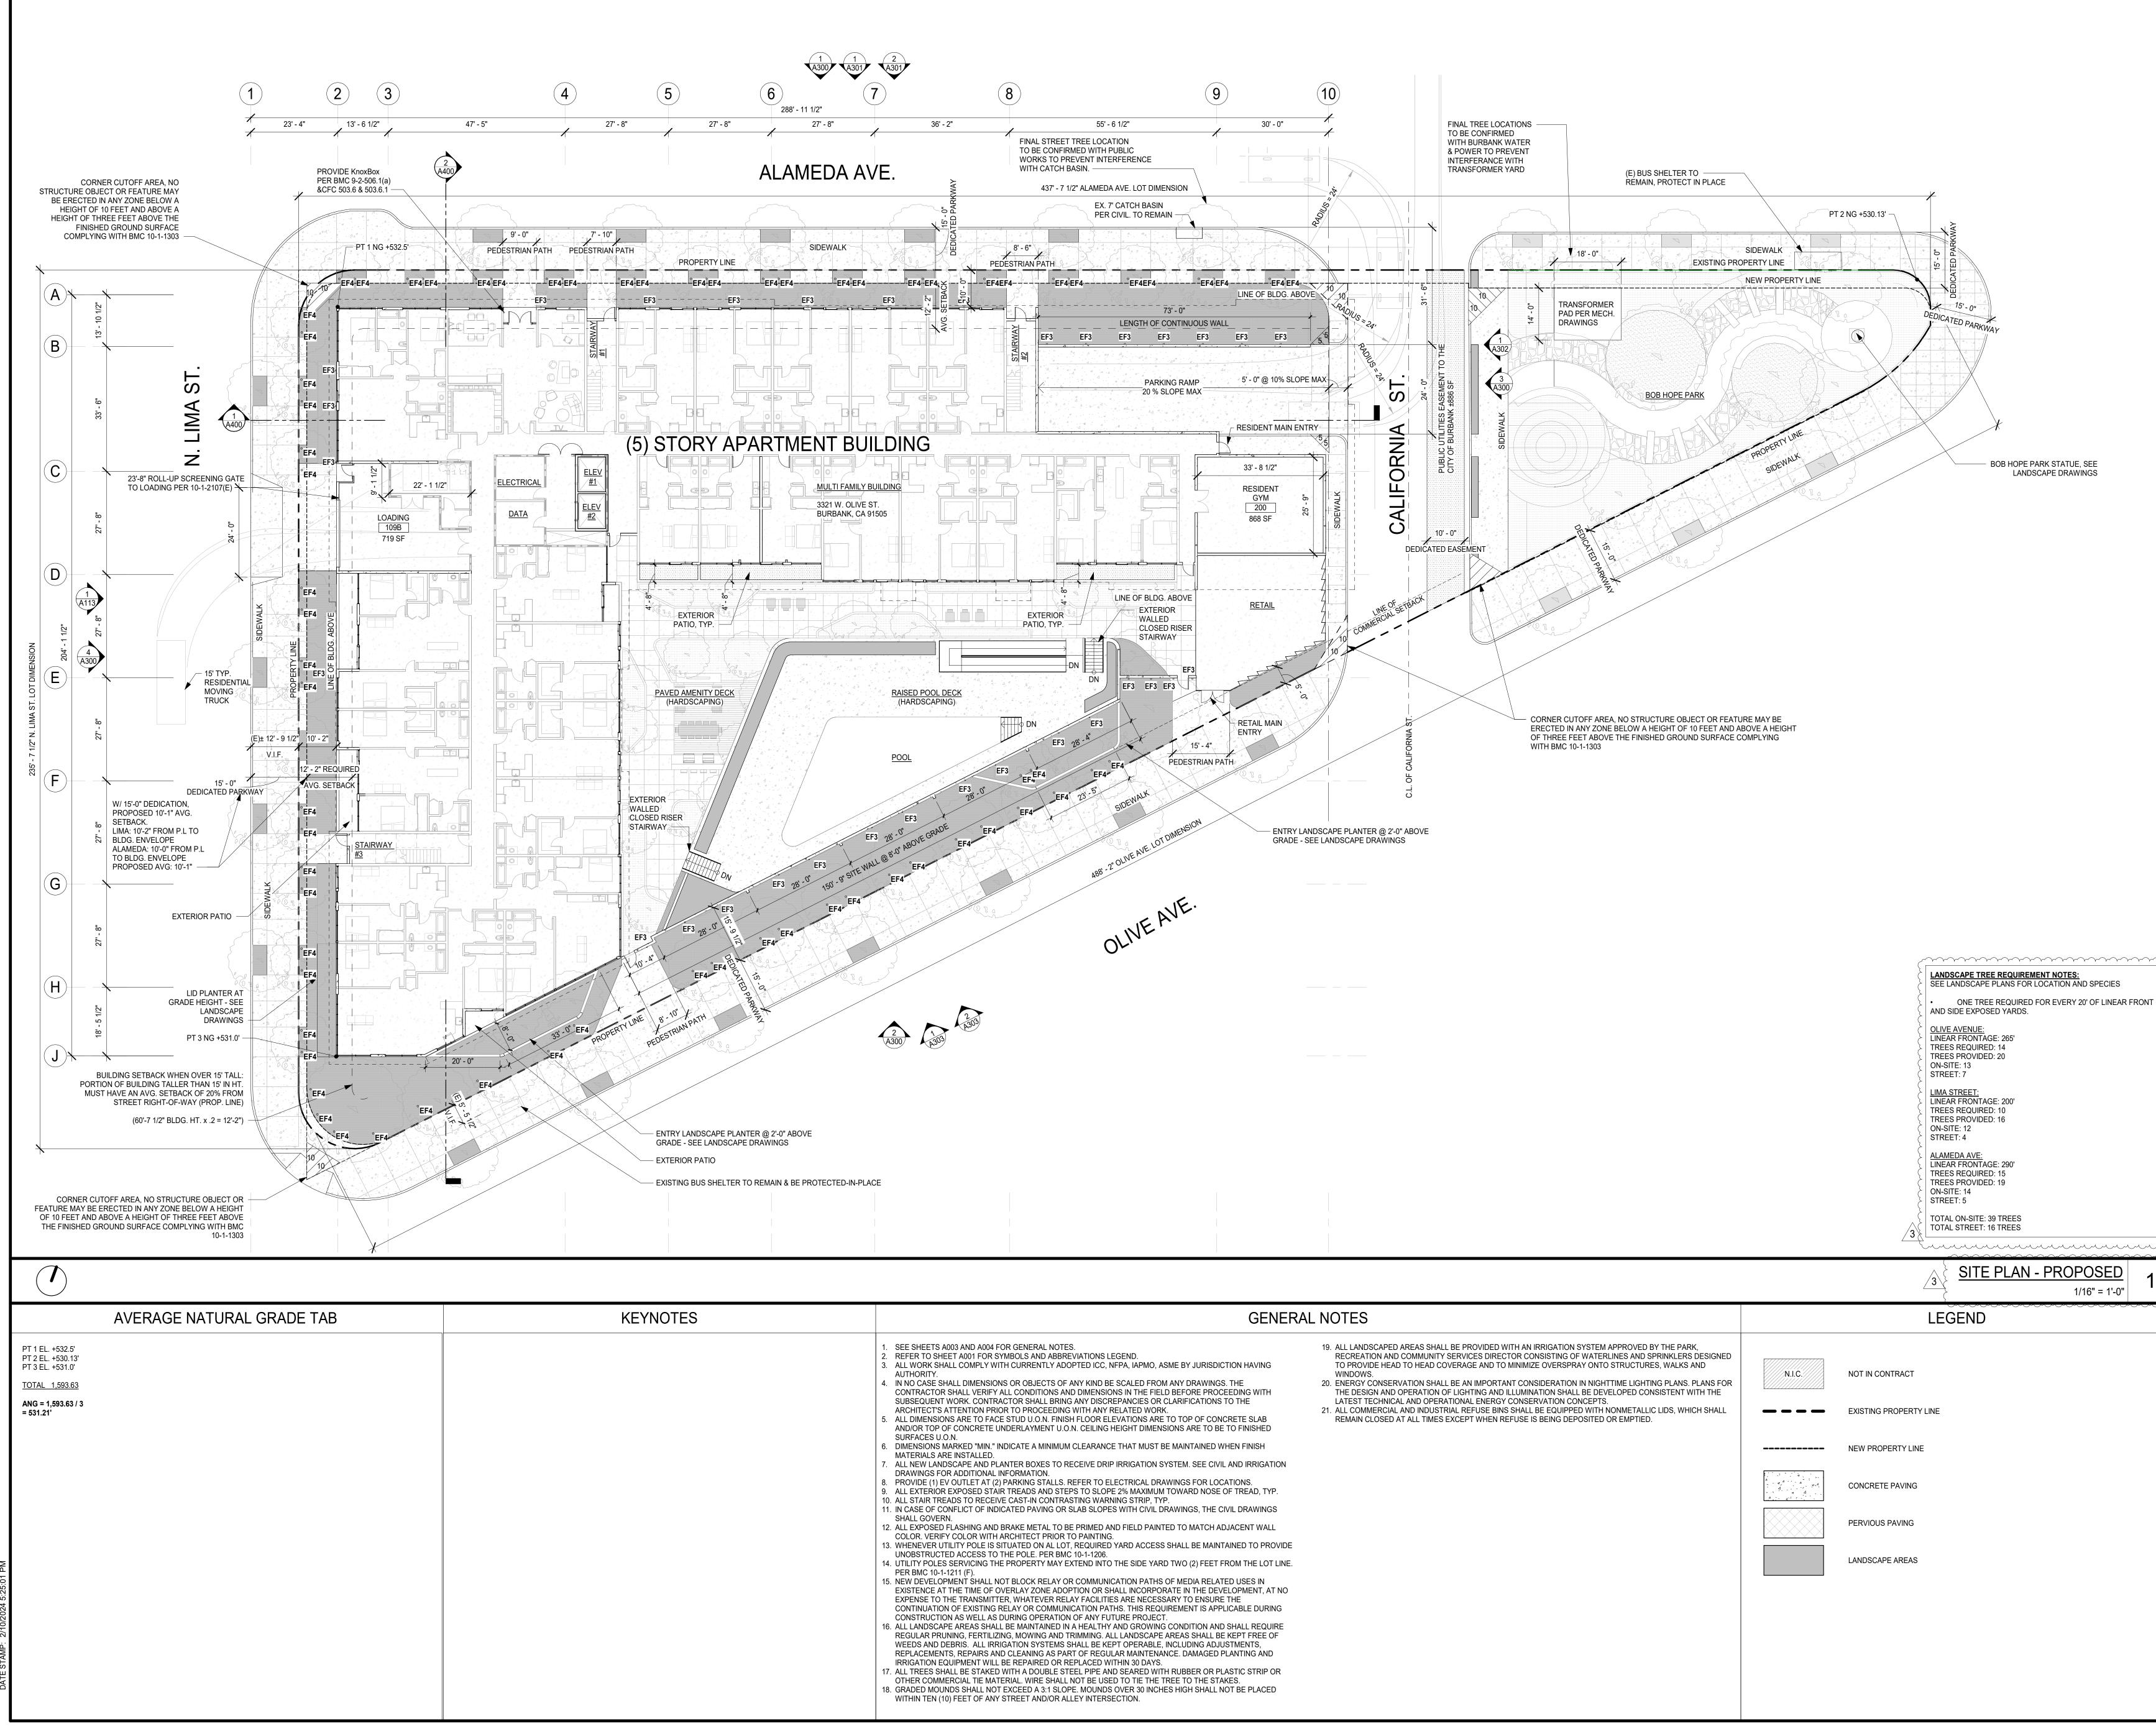



NOTES	GENERAL NO	OTES
	 REFER TO SHEET A001 FOR SYMBOLS AND ABBREVIATIONS LEGEND. ALL WORK SHALL COMPLY WITH CURRENTLY ADOPTED ICC, NFPA, IAPMO, ASME BY JURISDICTION HAVING AUTHORITY. IN NO CASE SHALL DIMENSIONS OR OBJECTS OF ANY KIND BE SCALED FROM ANY DRAWINGS. THE CONTRACTOR SHALL VERIFY ALL CONDITIONS AND DIMENSIONS IN THE FIELD BEFORE PROCEEDING WITH SUBSEQUENT WORK. CONTRACTOR SHALL BRING ANY DISCREPANCIES OR CLARIFICATIONS TO THE 	ALL LANDSCAPED A RECREATION AND O TO PROVIDE HEAD WINDOWS. ENERGY CONSERV/ THE DESIGN AND O LATEST TECHNICAL ALL COMMERCIAL A REMAIN CLOSED AT

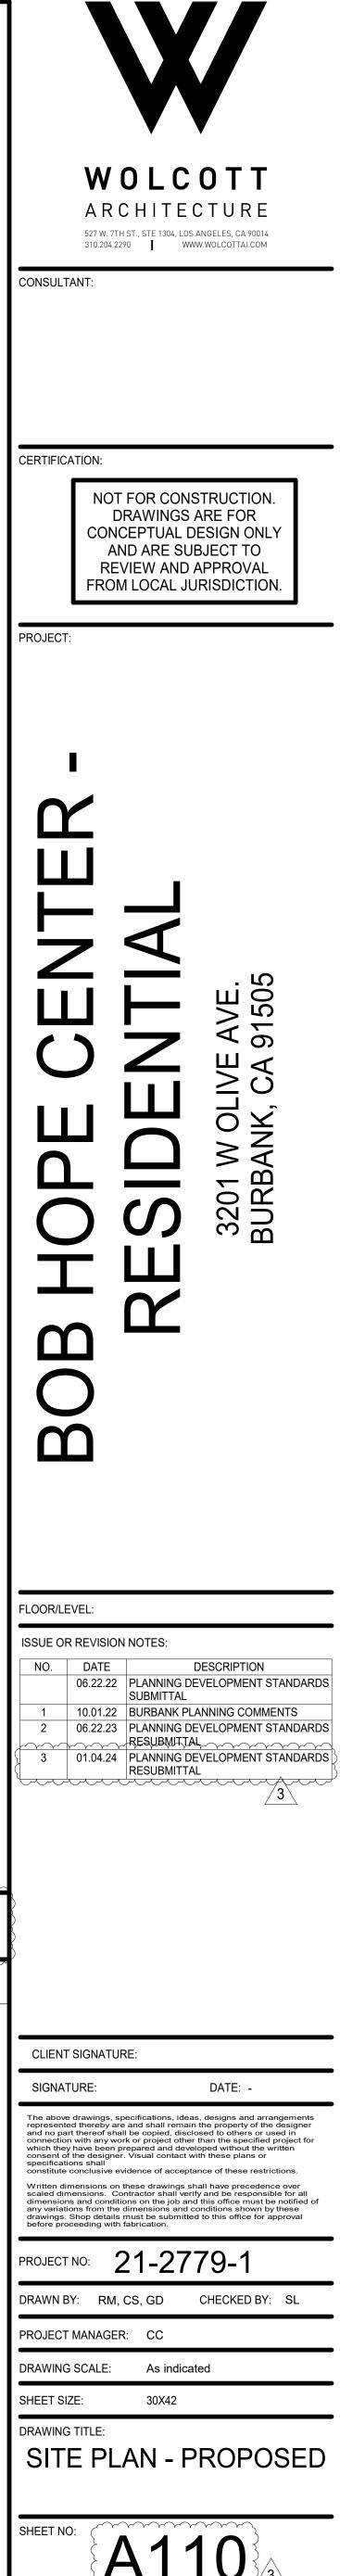

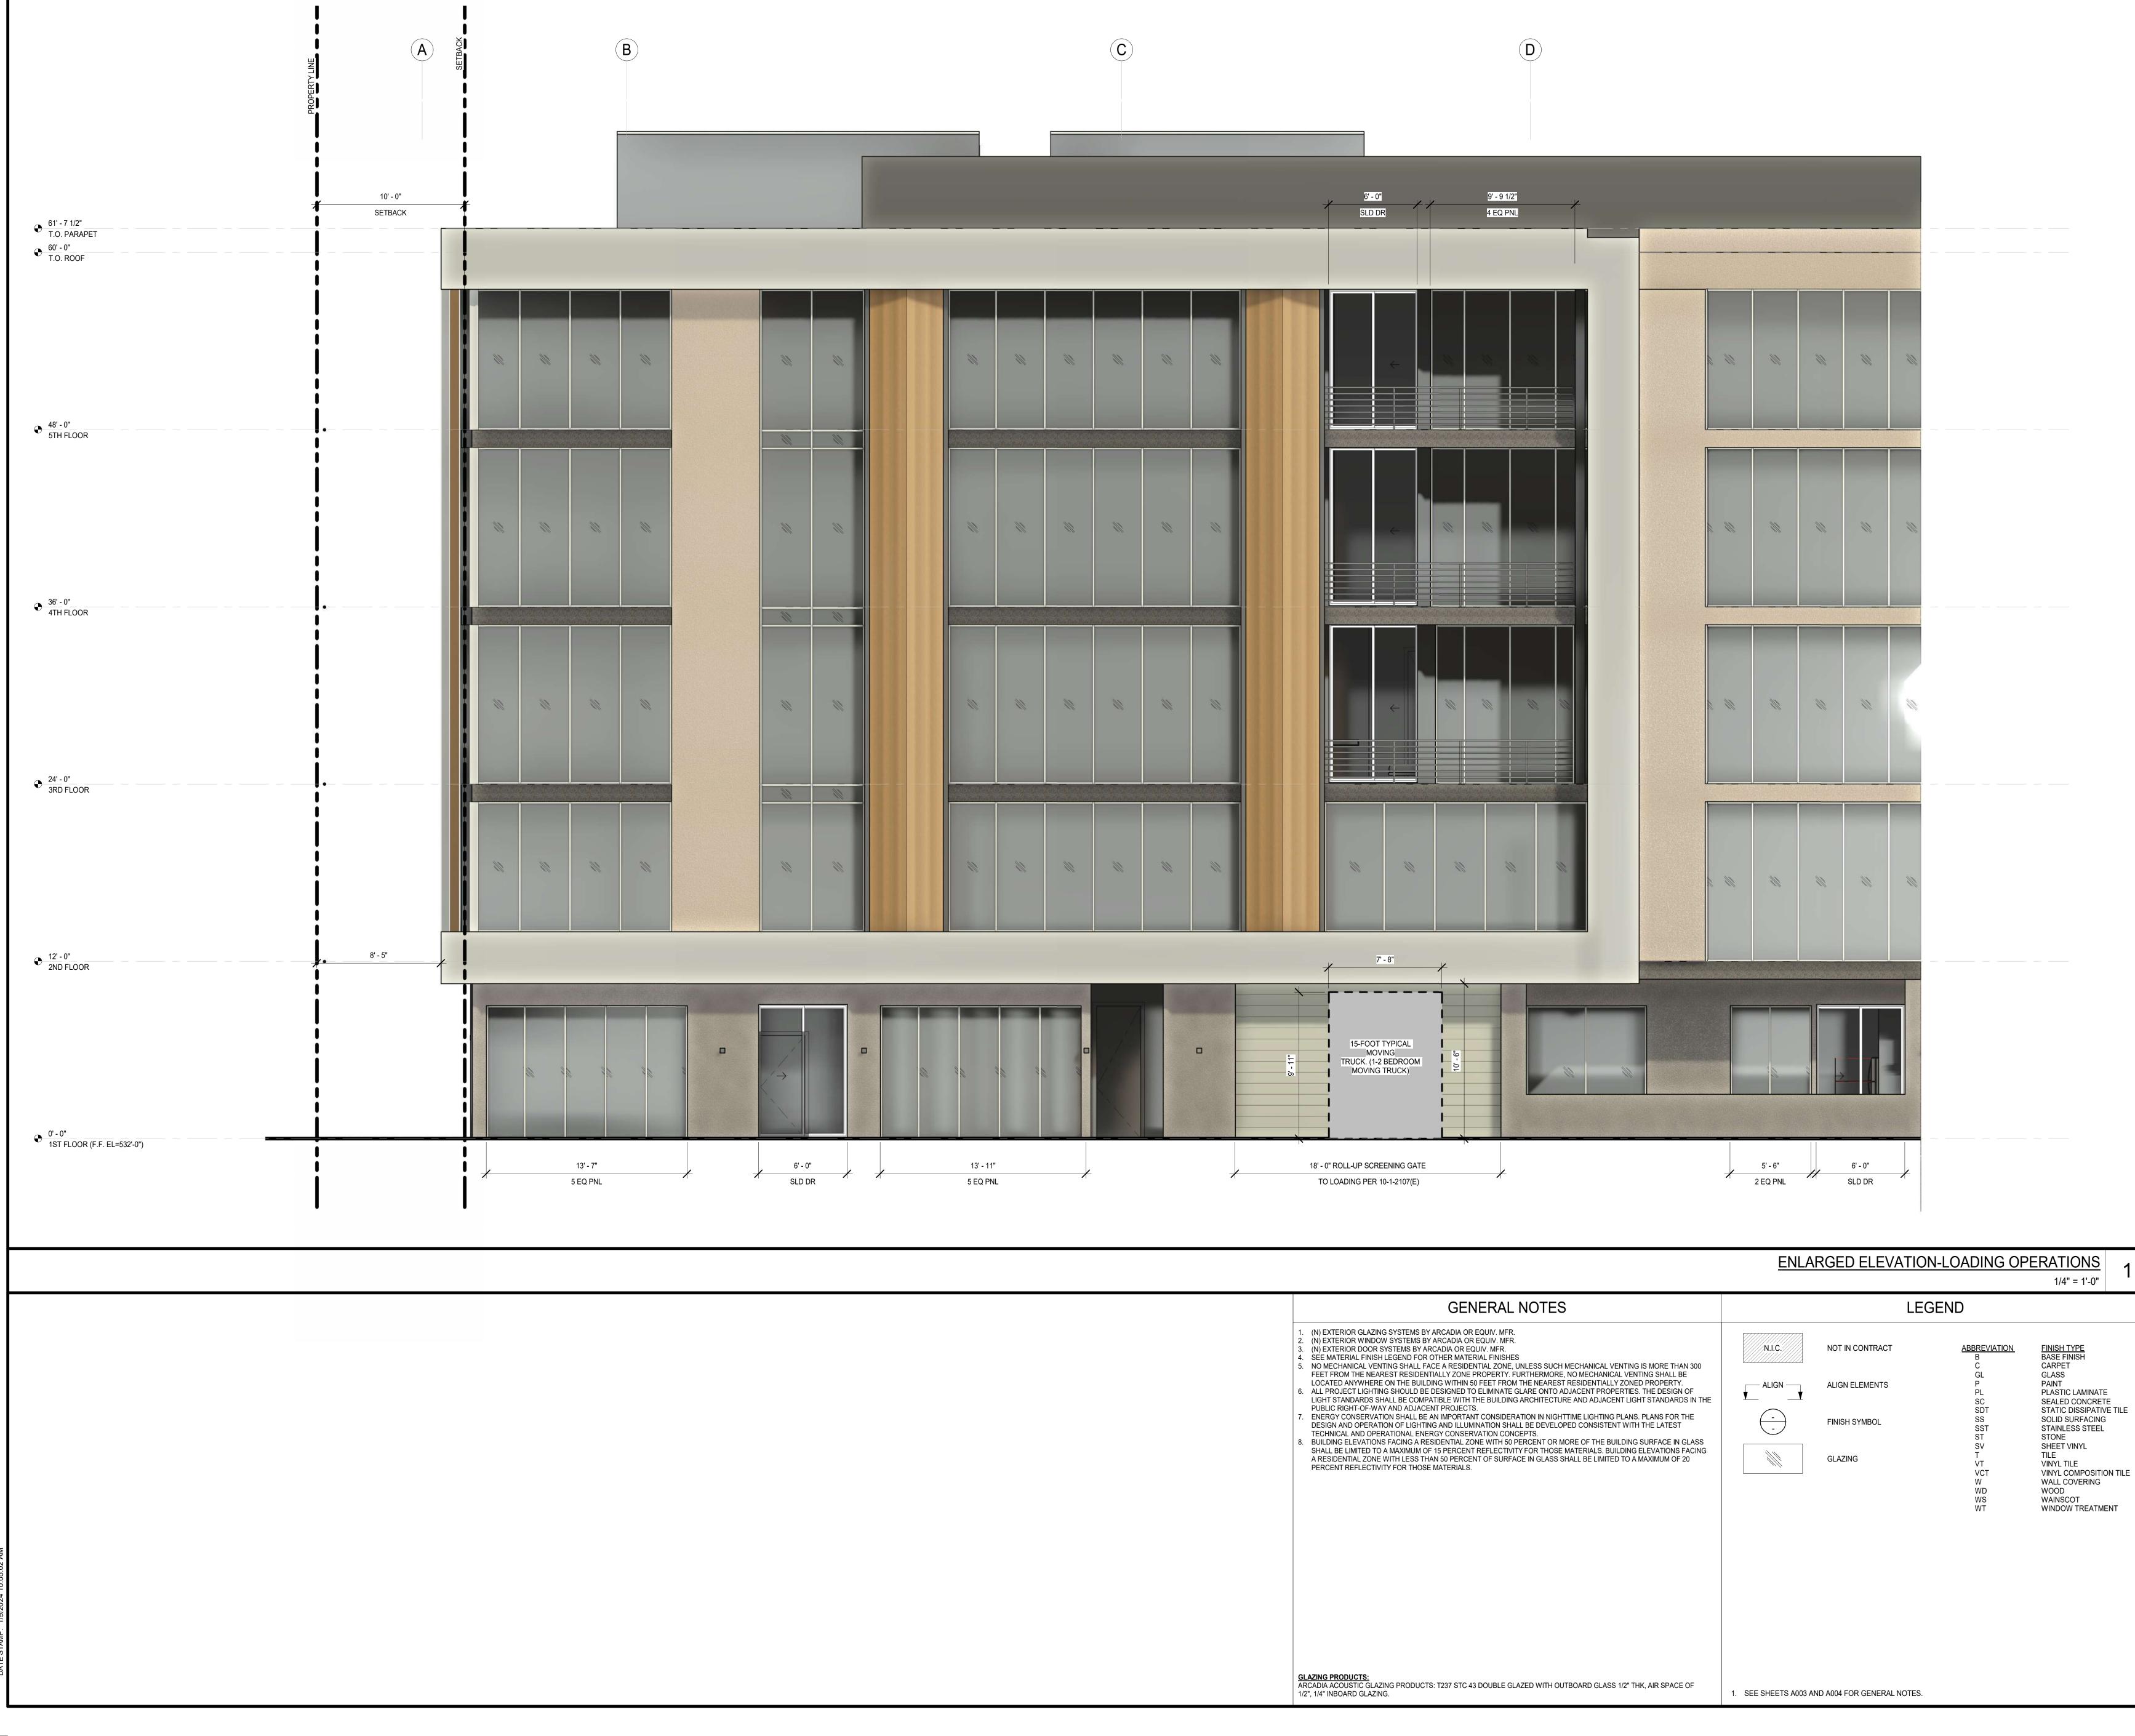

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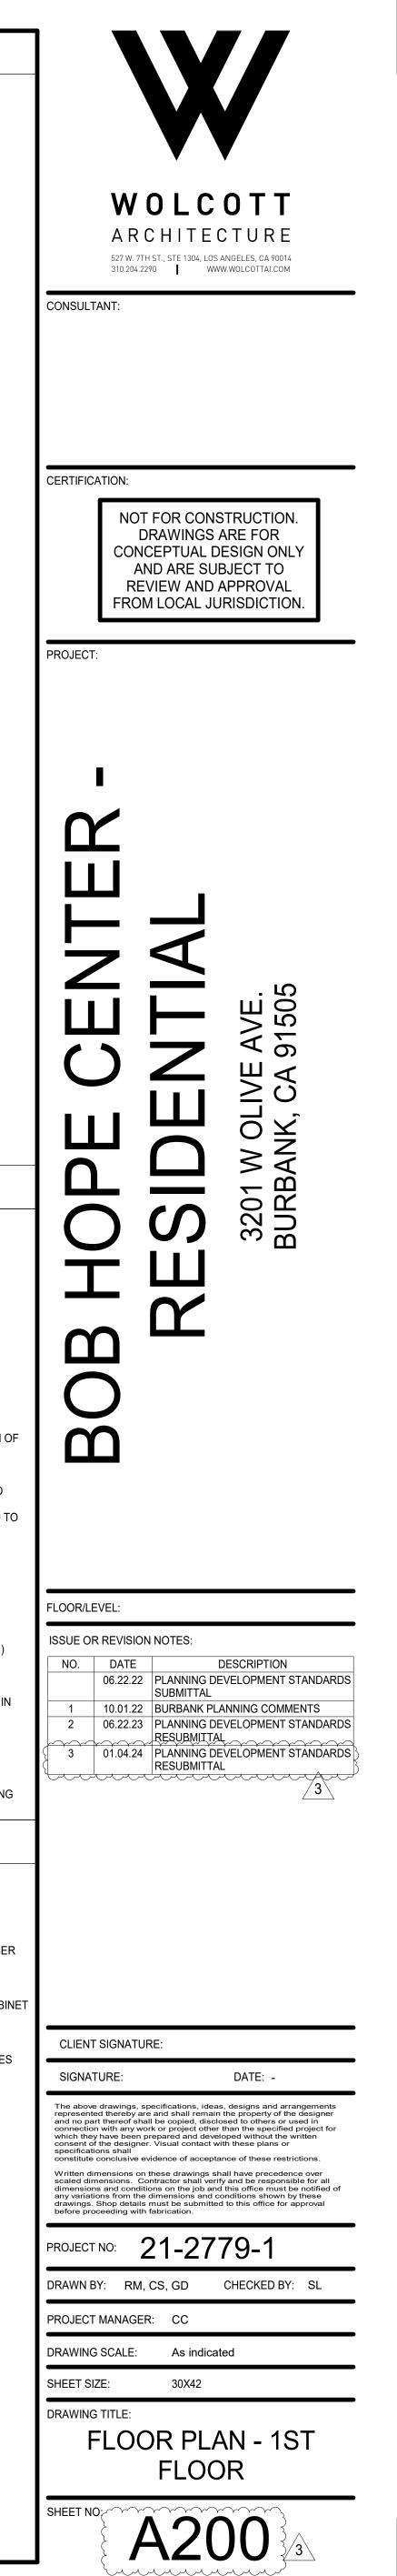


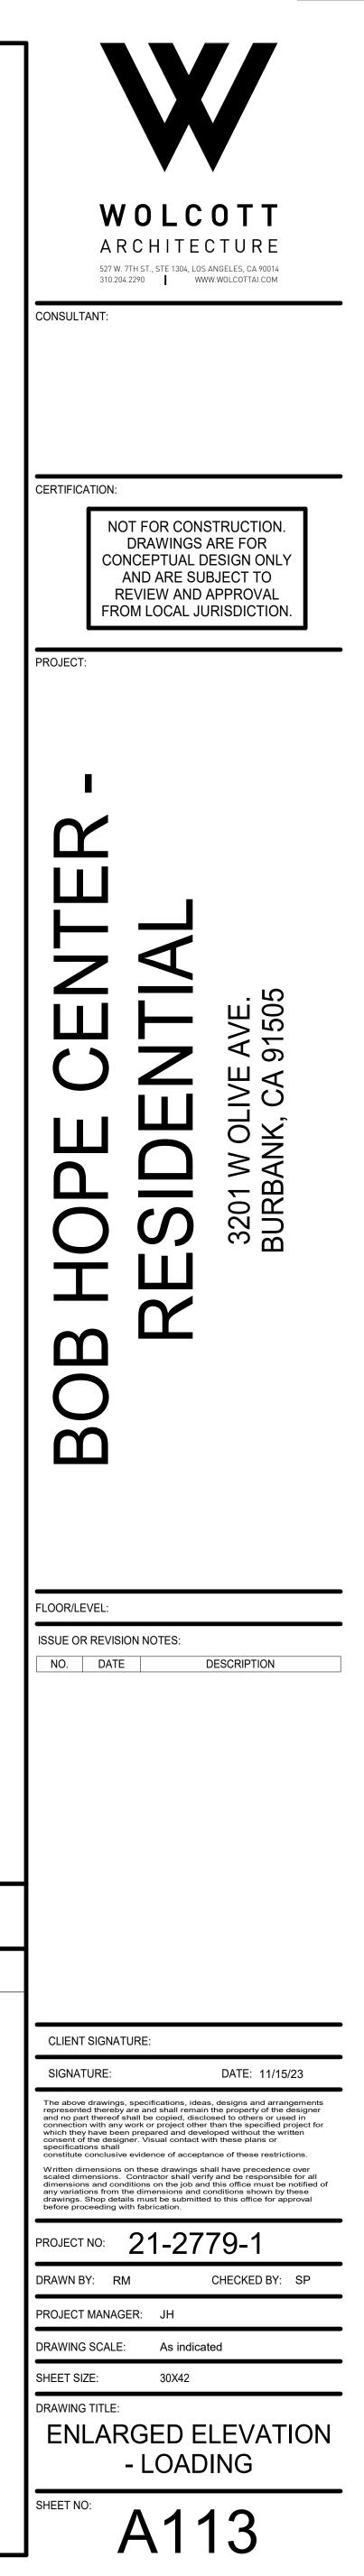
	GENERAL	NOTES	
 REFER TO SHEET / ALL WORK SHALL (AUTHORITY. IN NO CASE SHALL CONTRACTOR SHA SUBSEQUENT WOR ARCHITECT'S ATTE ALL DIMENSIONS A AND/OR TOP OF CC SURFACES U.O.N. DIMENSIONS MARH MATERIALS ARE IN ALL FRAMING MEM CONDUITS AND DU STIFFENERS, BRAC ALL WALL MOUNTE ACCESSORIES, GR ALL WOOD FRAMIN SECTION 2303.2. W SHEATHING, SILL F ADJUST FRAMING O MAINTAIN FIRE-RAT INFORMATION. ALL GYPSUM BOAF REFER TO SHEET / 	IBERS SHALL BE SO ARRANGED AND S ICTWORK WITH A MINIMUM OF CUTTIN CES, BACK-UP PLATES AND SUPPORTI ED OR SUSPENDED MECHANICAL AND AB BARS, MILLWORK. IG IN EXTERIOR WALLS TO BE FIRE-RE OOD FRAMING TO INCLUDE, BUT NOT PLATES, TOP PLATES, ETC. CONFIGURATION AT ALL FAN COIL UN TED ASSEMBLY. REFER TO MECHANIC URFACES TO BE FLUSH U.O.N. PROVI RD WALLS AND CEILINGS TO BE TAPEL A800 FOR WALL TYPES. A700 FOR DOOR SCHEDULE AND DETA A710 FOR FINISH, LIGHT FIXTURE, APP BE SHIELDED TO ELIMINATE GLARE ON GES, PARKING AREAS, AND DRIVEWAY TY PER BMC 10-1-2017 (G)(2) ING TO STANDARDS PRESCRIBED BY KING LOTS USED FOR PUBLIC PARKIN THE BURBANK 2035 GENERAL PLAN T SOURCES OF THE GENERAL PLAN. L BE CONSTRUCTED INCORPORATING INERGY, WATER, AND OTHER NATURA	ICC, NFPA, IAPMO, ASME ND BE SCALED FROM AN ENSIONS IN THE FIELD BE DISCREPANCIES OR CLAF ANY RELATED WORK. OR ELEVATIONS ARE TO LING HEIGHT DIMENSION RANCE THAT MUST BE M/ SPACED AS TO PERMIT IN IG. CONTRACTOR SHALL NG BRACKETS AS REQUI ELECTRICAL EQUIPMENT ETARDANT TREATED WOO LIMITED TO: STUDS, BLC ITS WITHIN FLOOR/ CEILII CAL AND STRUCTURAL DF D BE PRESSURE TREATED DE FURRING AS REQUIRED O, SANDED, AND PRIMED AILS AND WINDOW SCHEI LIANCE, EQUIPMENT, ANI ITO ADJACENT PROPERT (S SHALL CONTAIN SECU THE PUBLIC WORKS DIRE IG OR FOR COMMERCIAL HIS PROJECT WILL BE CO ABLE N-3 MAXIMUM ALLO	Y DRAWINGS. THE FORE PROCEEDING WITH RIFICATIONS TO THE TOP OF CONCRETE SLAB S ARE TO BE TO FINISHED AINTAINED WHEN FINISH STALLATION OF PIPE PROVIDE AND INSTALL ALL RED FOR THE INSTALLATION T, FIXTURES, BATHROOM OD COMPLYING WITH CBC CKING, EXTERIOR PLYWOOD AG ASSEMBLY AS REQUIRED AWINGS FOR ADDITIONAL D. D. D. TO LEVEL 4 FINISH U.O.N. DULE AND DETAILS. D PLUMBING FIXTURE IES PER BMC 10-1-2017 (H) (1 RITY LIGHTING. PRIMARY CONSTRUCTED IN A WAY TO WABLE NOISE EXPOSURE - URES THAT MINIMIZE THE
AND ENERGY COD			
N.I.C.	NOT IN CONTRACT	ALIGN	ALIGN ELEMENTS
	EXISTING MILLWORK	RM NAME	ROOM NAME AND NUM
	NEW MILLWORK	F.E.C.	FIRE EXTINGUISHER CA
	EXISTING PARTITION		NEW PLUMBING FIXTUR
	EXISTING DOOR		
C# -	WALL TAG. REFER TO A800		
4" TYP.	NEW DOOR		
< <u>1001</u> >	DOOR NUMBER. REFER TO A700		
	NEW PLUMBING FIXTURE, APPLIANCE, OR EQUIPMENT. REFER TO A710		

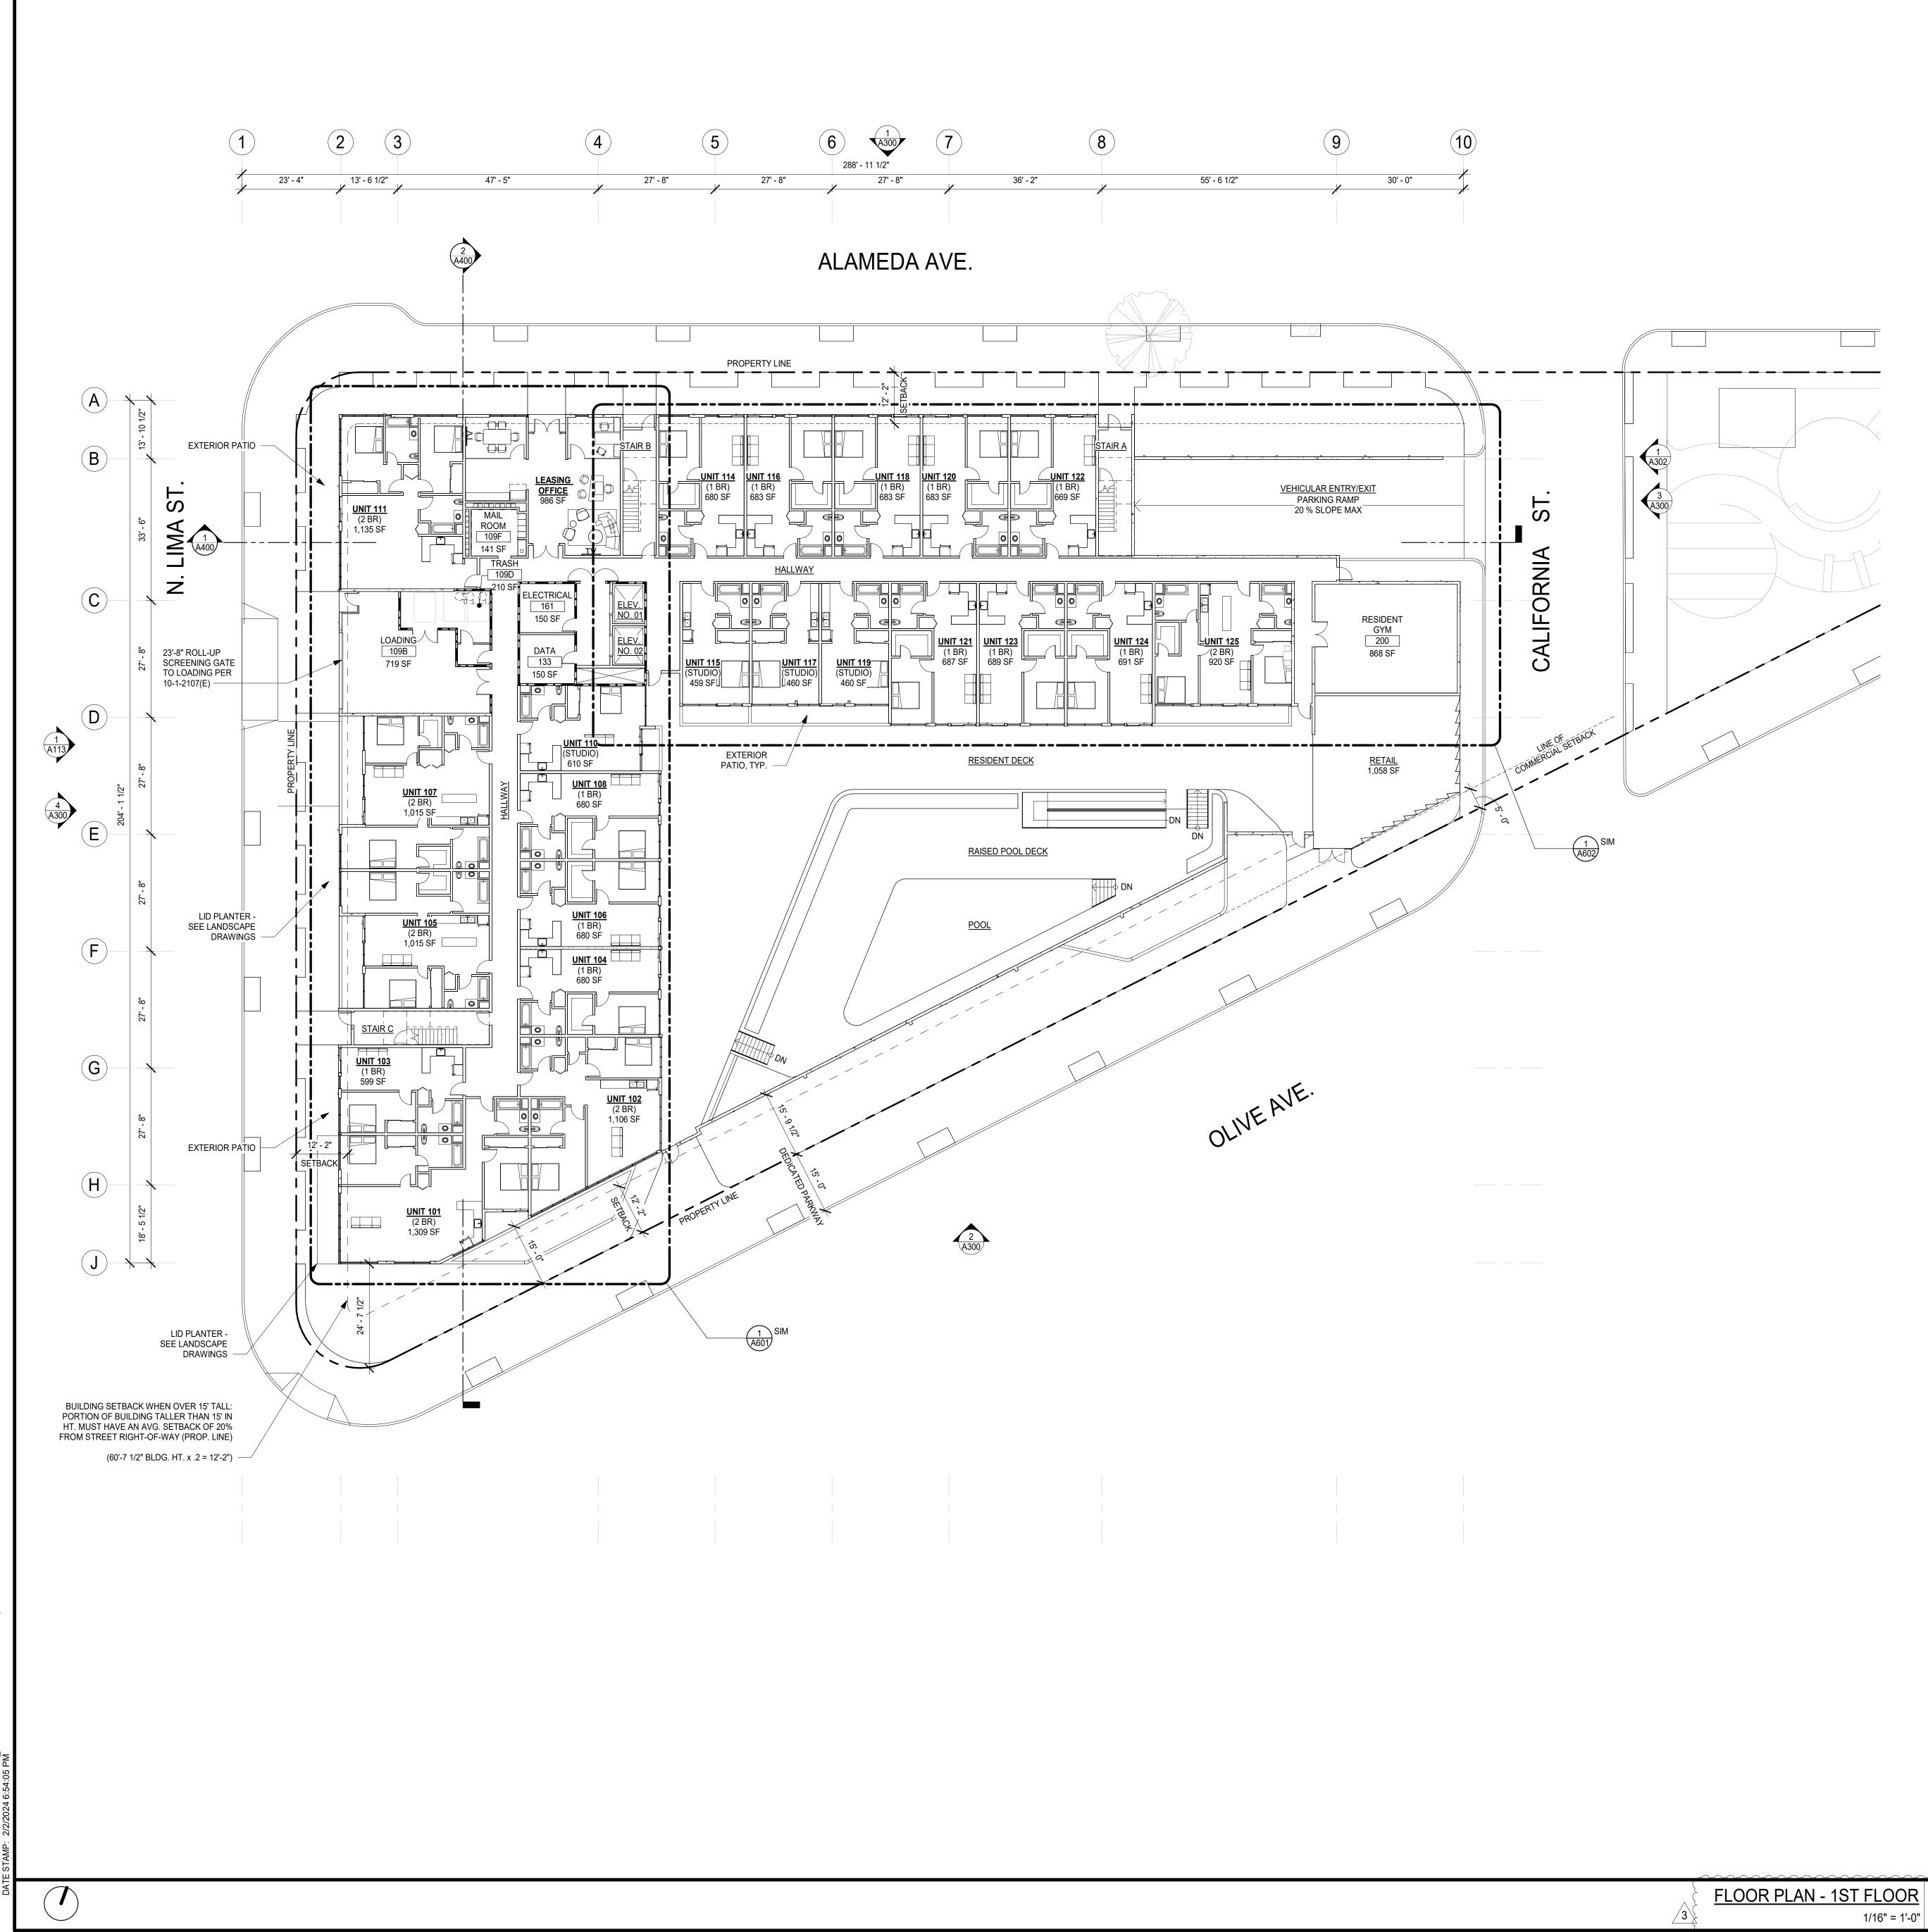KEYNOTES

1/16" = 1'-0"

APPLIANCE, OR EQUIPMENT. REFER TO A710



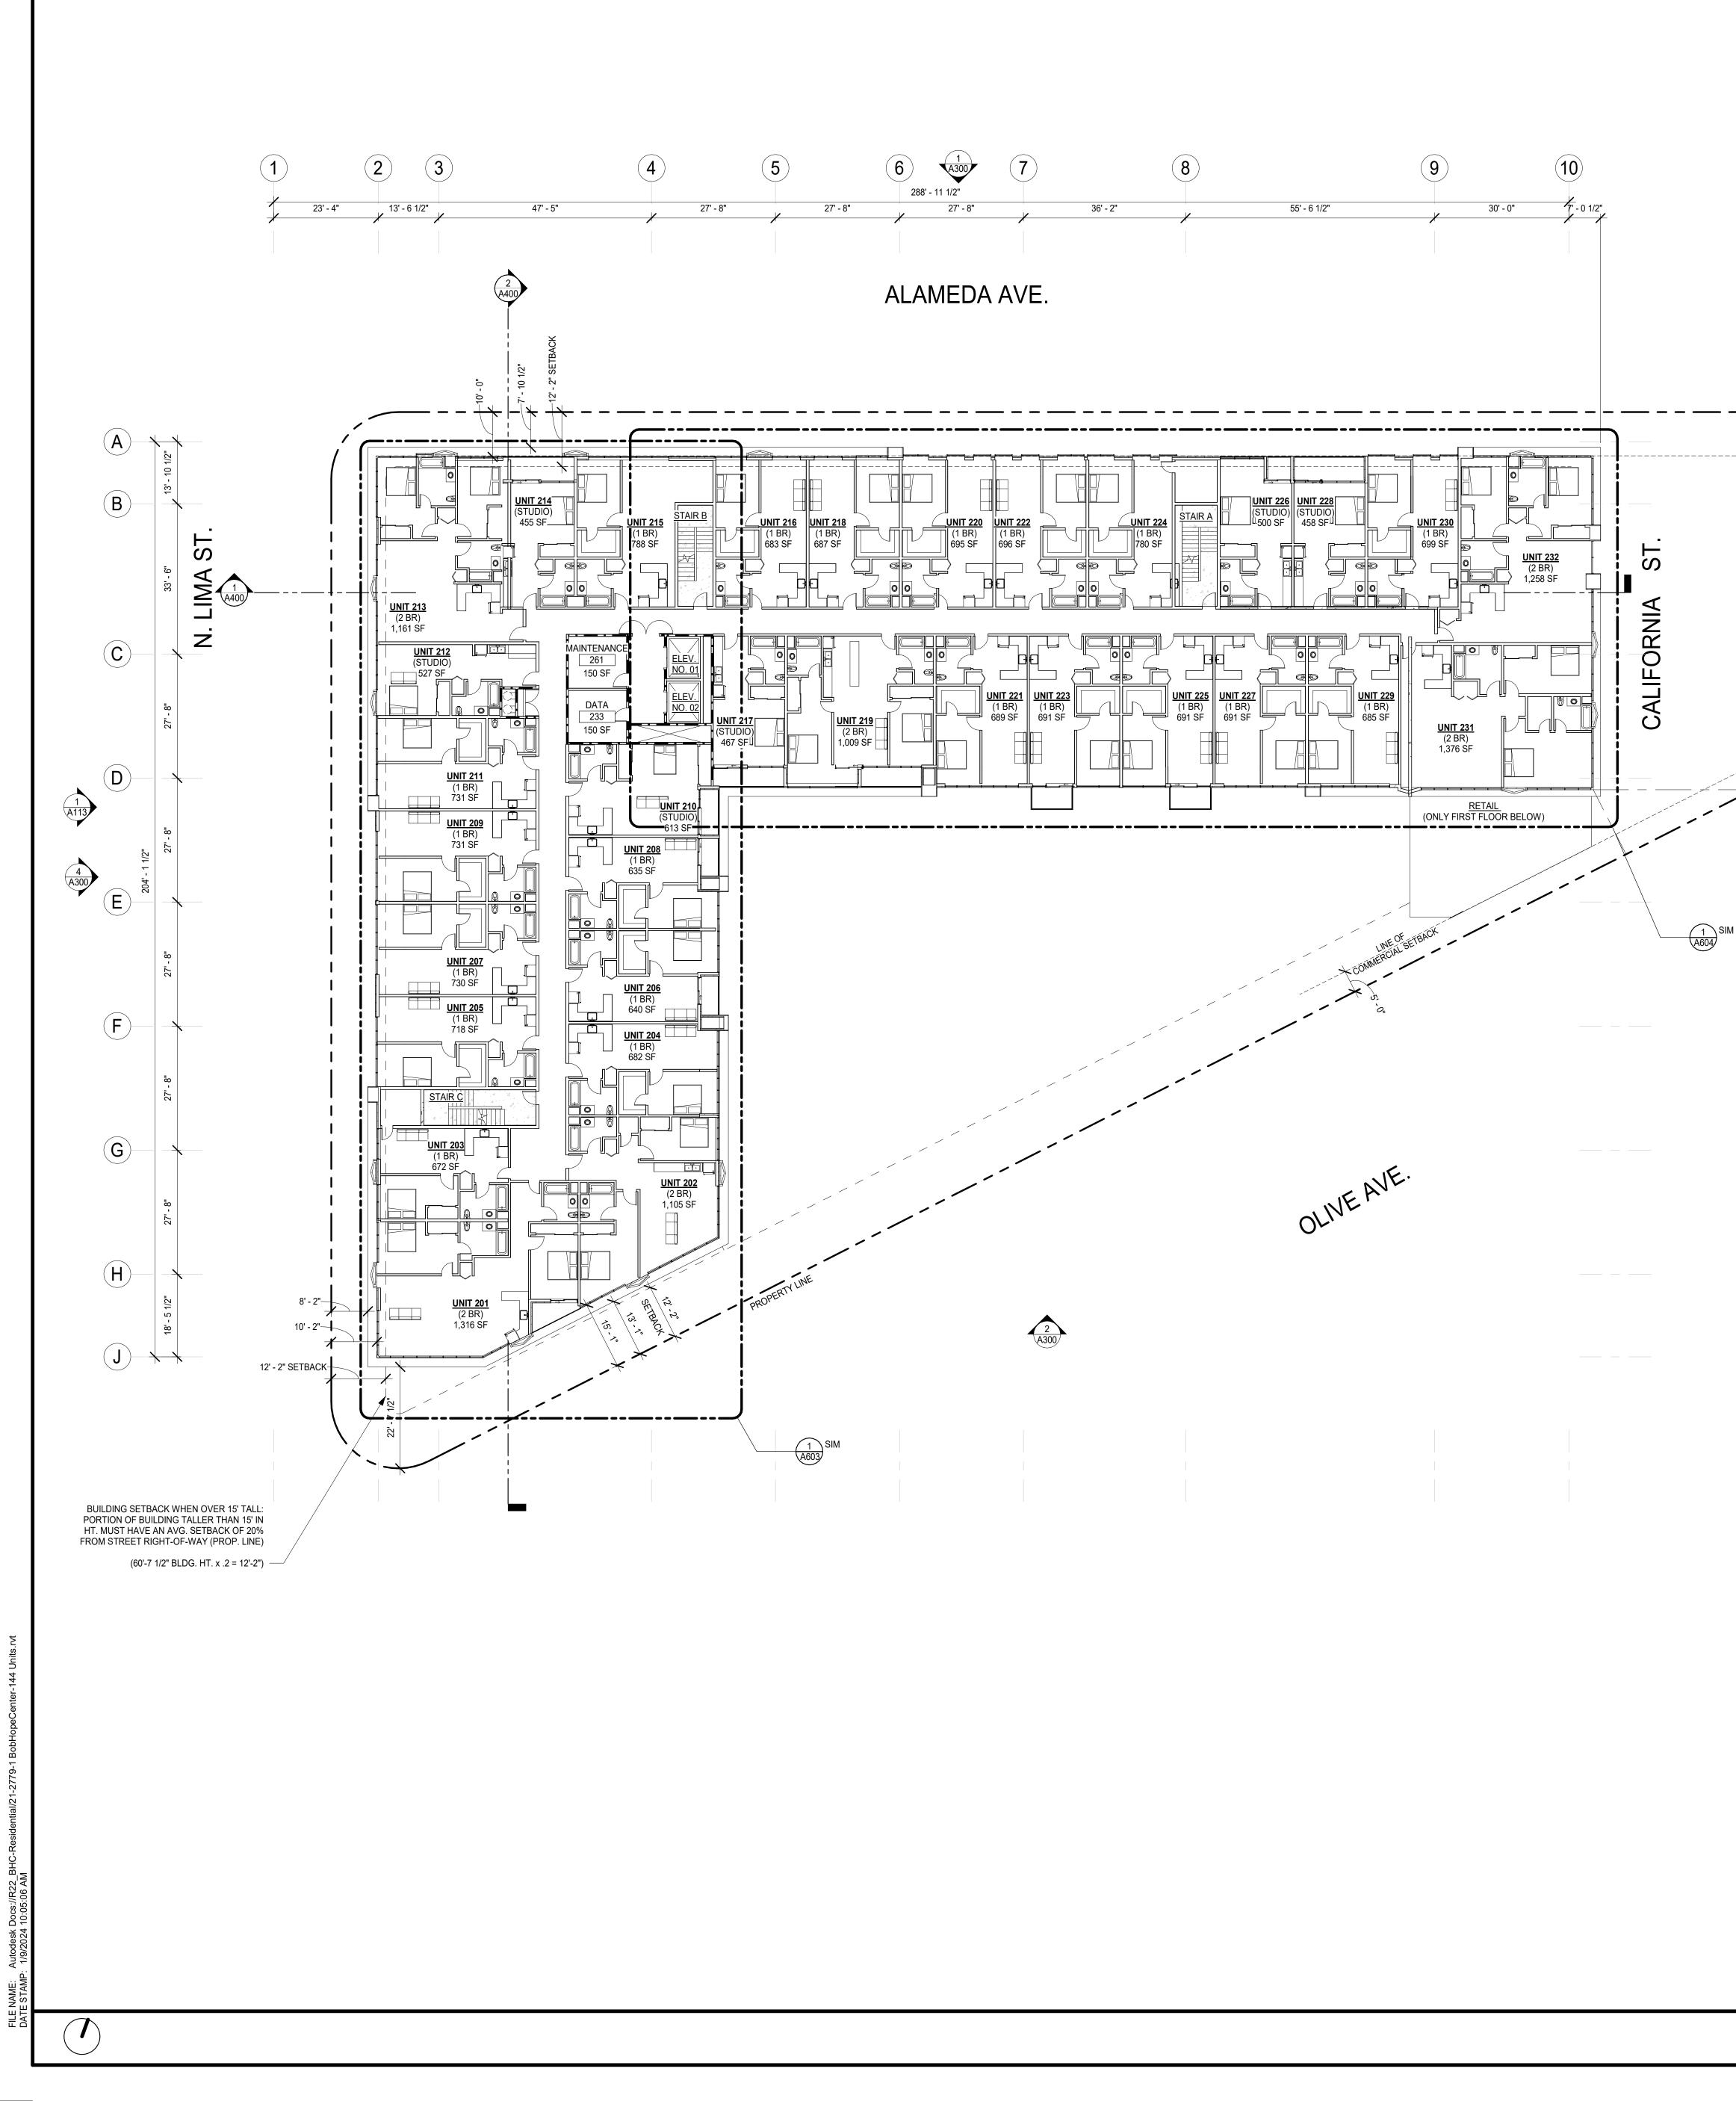


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A300				
SIM		GENERAL	NOTES	
		AND A004 FOR GENERAL NOTES. .001 FOR SYMBOLS AND ABBREVIATIO		
	 ALL WORK SHALL C AUTHORITY. IN NO CASE SHALL 	DIMENSIONS OR OBJECTS OF ANY KIN	CC, NFPA, IAPMO, ASME I	DRAWINGS. THE
	SUBSEQUENT WOR ARCHITECT'S ATTEI 5. ALL DIMENSIONS AF	K. CONTRACTOR SHALL BRING AND DIVIL NTION PRIOR TO PROCEEDING WITH A RE TO FACE STUD U.O.N. FINISH FLOC NCRETE UNDERLAYMENT U.O.N. CEIL	DISCREPANCIES OR CLAR ANY RELATED WORK. DR ELEVATIONS ARE TO T	IFICATIONS TO THE OP OF CONCRETE SLAB
	SURFACES U.O.N. 6. DIMENSIONS MARKI MATERIALS ARE INS	ED "MIN." INDICATE A MINIMUM CLEAF	ANCE THAT MUST BE MA	INTAINED WHEN FINISH
	CONDUITS AND DUO STIFFENERS, BRAC ALL WALL MOUNTED	CTWORK WITH A MINIMUM OF CUTTIN ES, BACK-UP PLATES AND SUPPORTI D OR SUSPENDED MECHANICAL AND AB BARS, MILLWORK.	G. CONTRACTOR SHALL F NG BRACKETS AS REQUIF	PROVIDE AND INSTALL ALL RED FOR THE INSTALLATION O
	8. ALL WOOD FRAMING SECTION 2303.2. WO SHEATHING, SILL PL	G IN EXTERIOR WALLS TO BE FIRE-RE DOD FRAMING TO INCLUDE, BUT NOT LATES, TOP PLATES, ETC. CONFIGURATION AT ALL FAN COIL UNI	LIMITED TO: STUDS, BLOG	CKING, EXTERIOR PLYWOOD
	MAINTAIN FIRE-RAT INFORMATION. 10. ALL WOOD FRAMING	G IN CONTACT WITH CONCRETE IS TO JRFACES TO BE FLUSH U.O.N. PROVID	AL AND STRUCTURAL DR	AWINGS FOR ADDITIONAL
	 ALL GYPSUM BOAR REFER TO SHEET A REFER TO SHEET A 	D WALLS AND CEILINGS TO BE TAPED), SANDED, AND PRIMED T	O LEVEL 4 FINISH U.O.N. ULE AND DETAILS.
	SCHEDULES. 16. ALL LIGHTING TO BE CARPORTS, GARAG	E SHIELDED TO ELIMINATE GLARE ON GES, PARKING AREAS, AND DRIVEWAY TY PER BMC 10-1-2017 (G)(2)	TO ADJACENT PROPERTI	ES PER BMC 10-1-2017 (H) (1)
	17. (NOT USED) 18. LIGHTS CONFORMIN	NG TO STANDARDS PRESCRIBED BY T KING LOTS USED FOR PUBLIC PARKIN		
	19. PER TABLE N-5 OF 1 ACHIEVE INTERIOR TRANSPORTATION	THE BURBANK 2035 GENERAL PLAN TH NOISE LEVELS US 45DBA MAX. PER T, SOURCES OF THE GENERAL PLAN. BE CONSTRUCTED INCORPORATING	ABLE N-3 MAXIMUM ALLO	WABLE NOISE EXPOSURE -
		NERGY, WATER, AND OTHER NATURA ES.	L RESOURCES CONSISTE	
		LEGE		
	N.I.C.	NOT IN CONTRACT	RM NAME	ALIGN ELEMENTS
		EXISTING MILLWORK	#	ROOM NAME AND NUMBER
		NEW MILLWORK	F.E.C.	FIRE EXTINGUISHER CABIN
		EXISTING PARTITION		NEW PLUMBING FIXTURES
		EXISTING DOOR		
	C# -			
		NEW DOOR		
	<u>< 1001</u> >	DOOR NUMBER. REFER TO A700		


FLOOR PLAN - 2ND FLOOR	1
1/16" = 1'-0"	I


 $\langle \mathsf{A} \rangle$

NEW GLAZING OR STOREFRONT SYSTEM PER SCHEDULE. NEW PLUMBING FIXTURE, APPLIANCE, OR EQUIPMENT. REFER TO A710


⟨##⟩ ◄──── WINDOW TAG. REFER TO A700

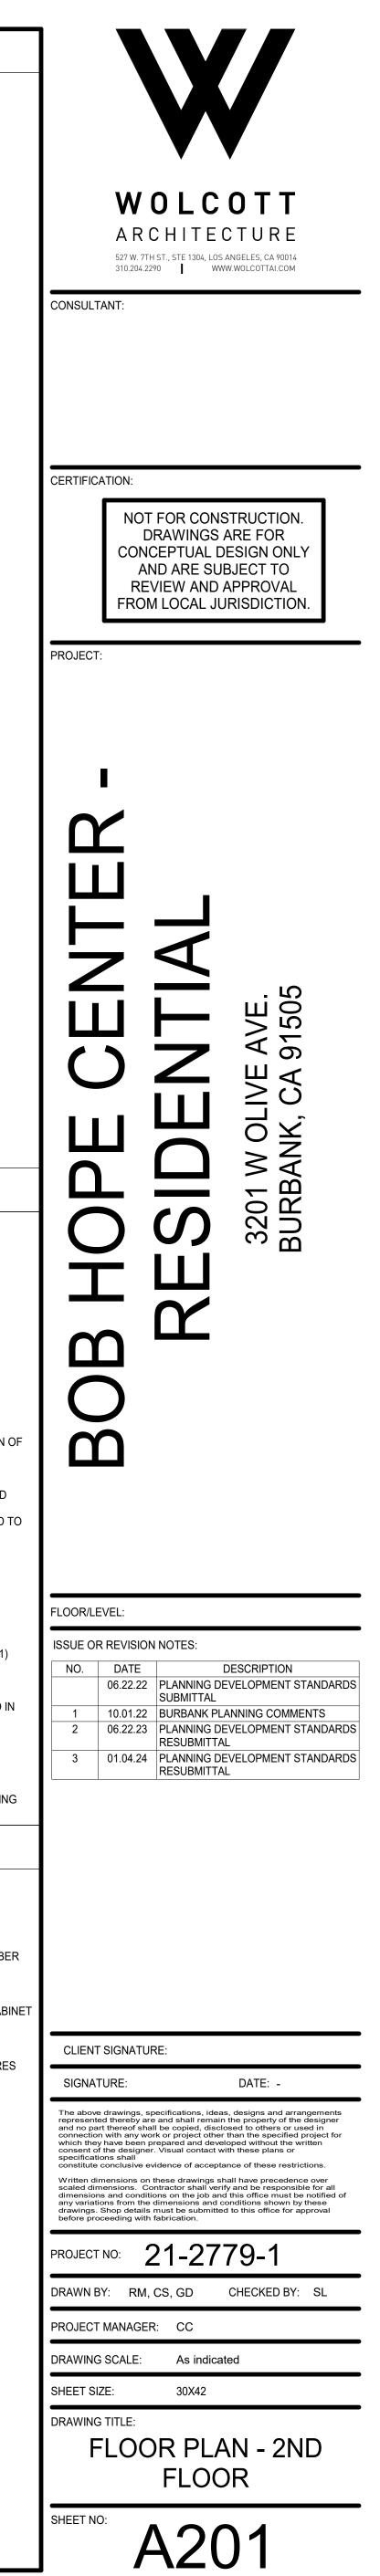


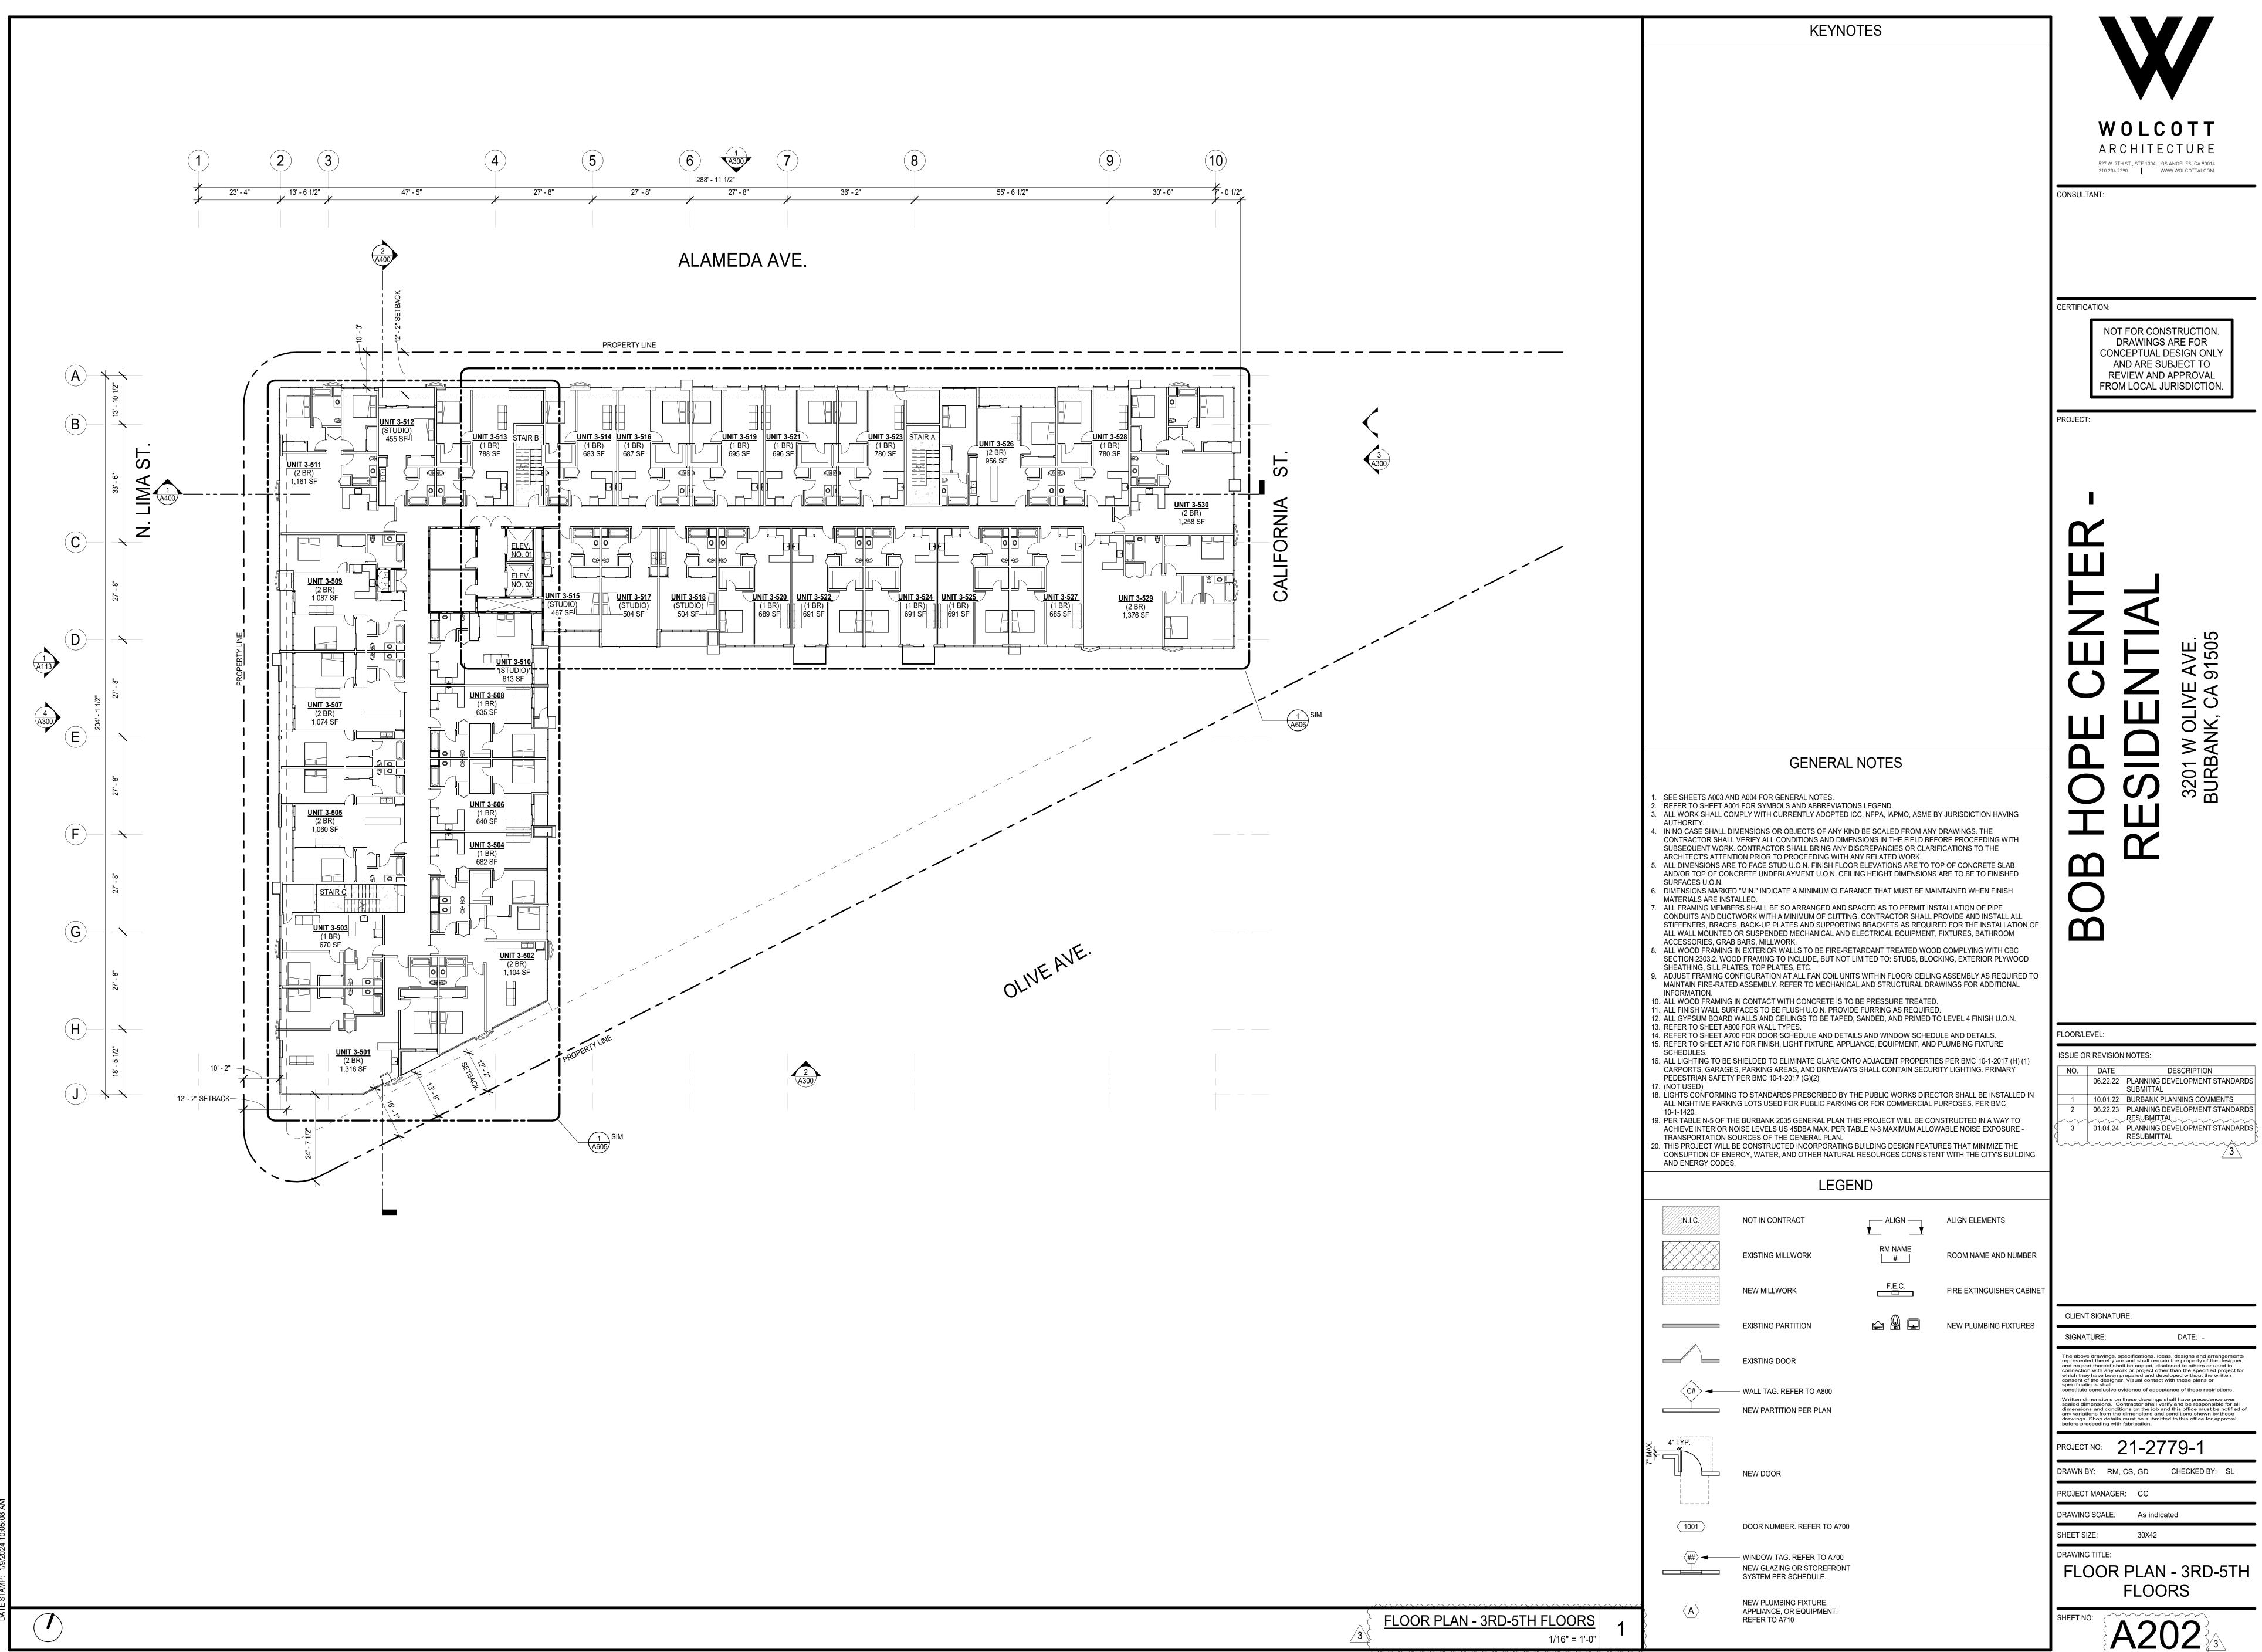

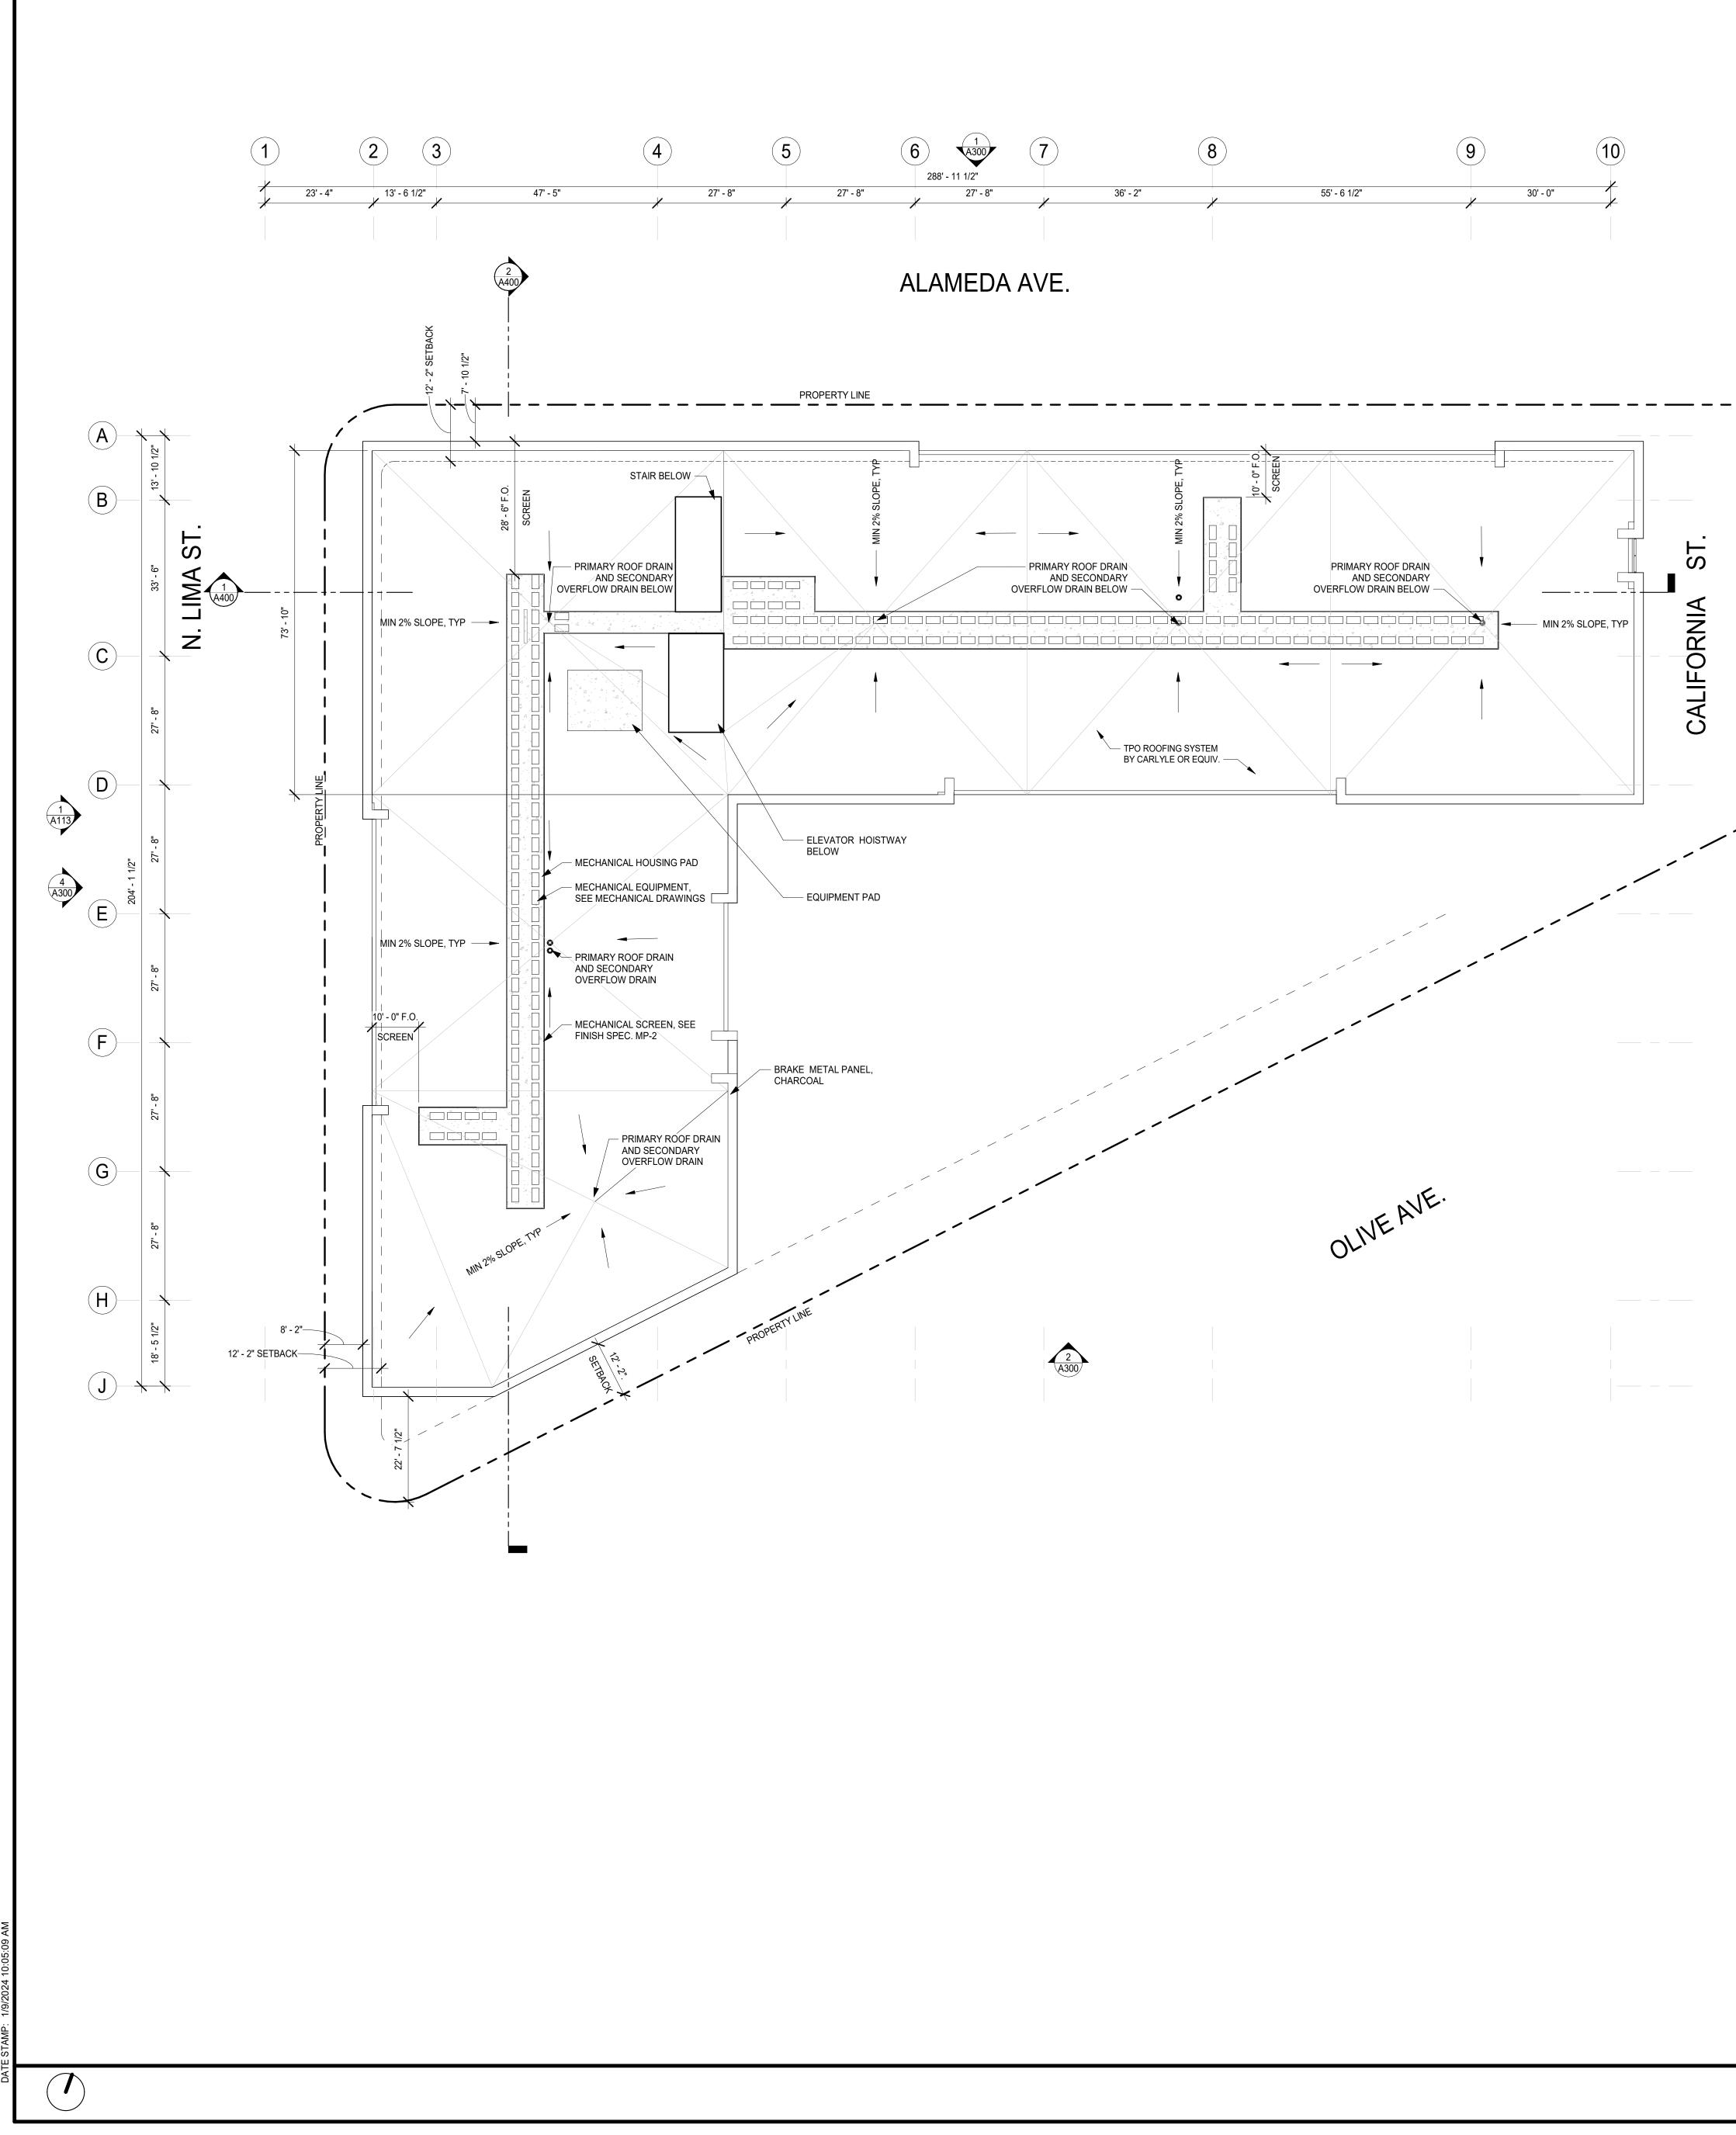

	KEYNOTES
3 (A300)	
	GENERAL NOTES
	 SEE SHEETS A003 AND A004 FOR GENERAL NOTES. PROVIDE NEW UL CLASS 'A' ROOF THROUGHOUT ENTIRE ROOF AREA, UP AND AROUND ALL WALL, PARAPETS, CRICKETS, MECHANICAL PLATFORMS AND VENTS. PROVIDE CREMERIANIS AND VENTS.
	 ROOFING SPECIFICATIONS: ROOFING MEMBRANE AND INSULATION BY GAF, PROVIDE GAF MECHANICALLY ATTACHED SINGLE-PLY EVERGUARD TPO 80 MIL ROOFING MEMBRANE.SYSTEM (UL1306) WITH 2 LAYERS OF 2.7 POLYISO INSULATION (DO NOT EXCEED 3" THICK INSULATION) FOR A MINIMUM R-30 R VALUE. PROVIDE GAF ROOFING ACCESSORIES INCLUDING; VENTS BOOTS, SQUARE TUBE WRAP, 36" CORNER CURB
	 WRAP, INSIDE CORNER, DETAILING MEMBRANE, FLASHING STRIP, SEALER POCKET AND TPO COATED METAL DRAINS . INSTALL ALL ROOFING ACCESSORIES AND ROOFING SYSTEM PER MANUFACTURER'S REQUIREMENTS. PROVID NEW ROOF WITH MINIMUM 2% SLOPE TO DRAINS.
	 SEE SHEET AXXX FOR ROOF PENETRATION DETAILS ALL LIGHTING TO BE SHIELDED TO ELIMINATE GLARE ONTO ADJACENT PROPERTIES PER BMC 10-1-2017 (H) (1) CARPORTS, GARAGES, PARKING AREAS, AND DRIVEWAYS SHALL CONTAIN SECURITY LIGHTING. PRIMARY PEDESTRIAN SAFETY PER BMC 10-1-2017 (G)(2)
	 LIGHTS CONFORMING TO STANDARDS PRESCRIBED BY THE PUBLIC WORKS DIRECTOR SHALL BE INSTALLED IN ALL NIGHTIME PARKING LOTS USED FOR PUBLIC PARKING OR FOR COMMERCIAL PURPOSES. PER BMC 10-1-1420.
	 PER TABLE N-5 OF THE BURBANK 2035 GENERAL PLAN THIS PROJECT WILL BE CONSTRUCTED IN A WAY TO ACHIEVE INTERIOR NOISE LEVELS US 45DBA MAX. PER TABLE N-3 MAXIMUM ALLOWABLE NOISE EXPOSURE - TRANSPORTATION SOURCES OF THE GENERAL PLAN. THIS PROJECT WILL BE CONSTRUCTED INCORPORATING BUILDING DESIGN FEATURES THAT MINIMIZE THE
	CONSUPTION OF ENERGY, WATER, AND OTHER NATURAL RESOURCES CONSISTENT WITH THE CITY'S BUILDING AND ENERGY CODES.
	LEGEND
	N.I.C. NOT IN CONTRACT
	ROOF CRICKET
	SLOPE 1:12 ROOF SLOPE
	ROOF HATCH
	WALK PAD
	ALIGN ALIGN ELEMENTS
	PARAPET. WALL TYPE TO MATCH BELOW
1	
ROOF PLAN	

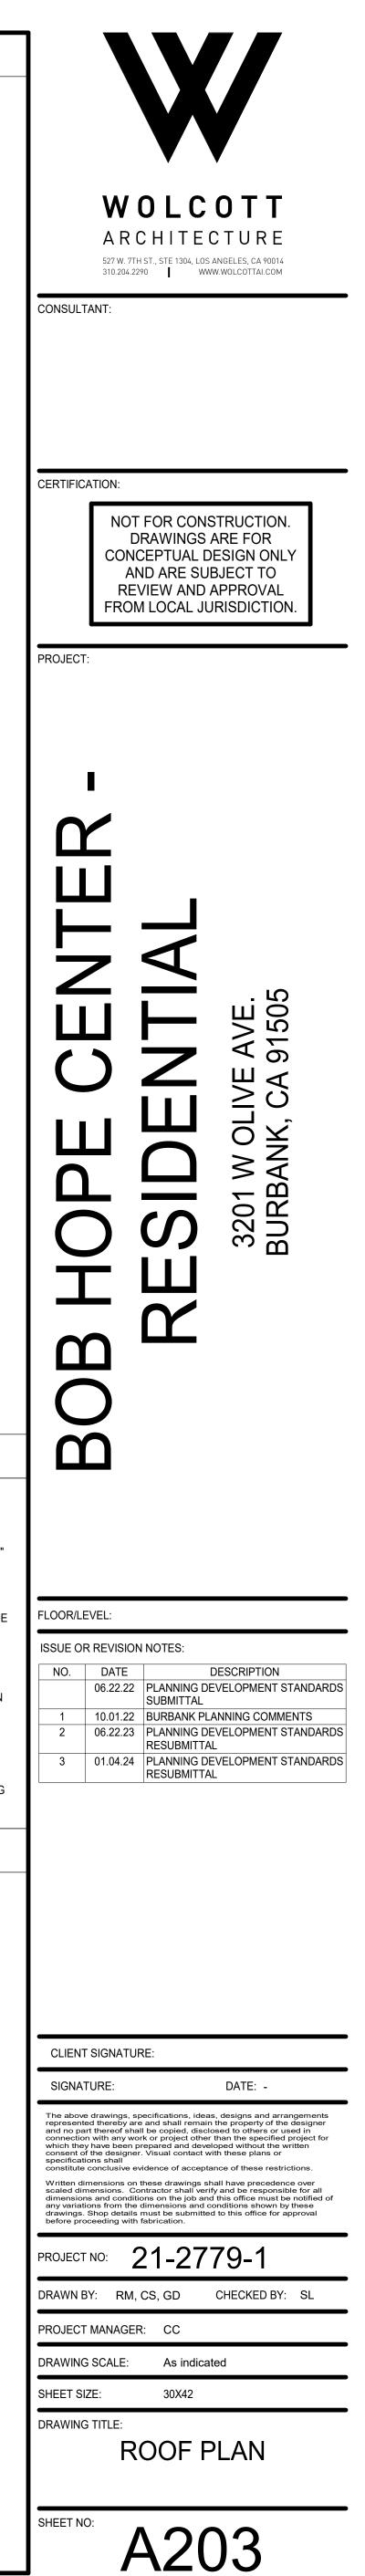


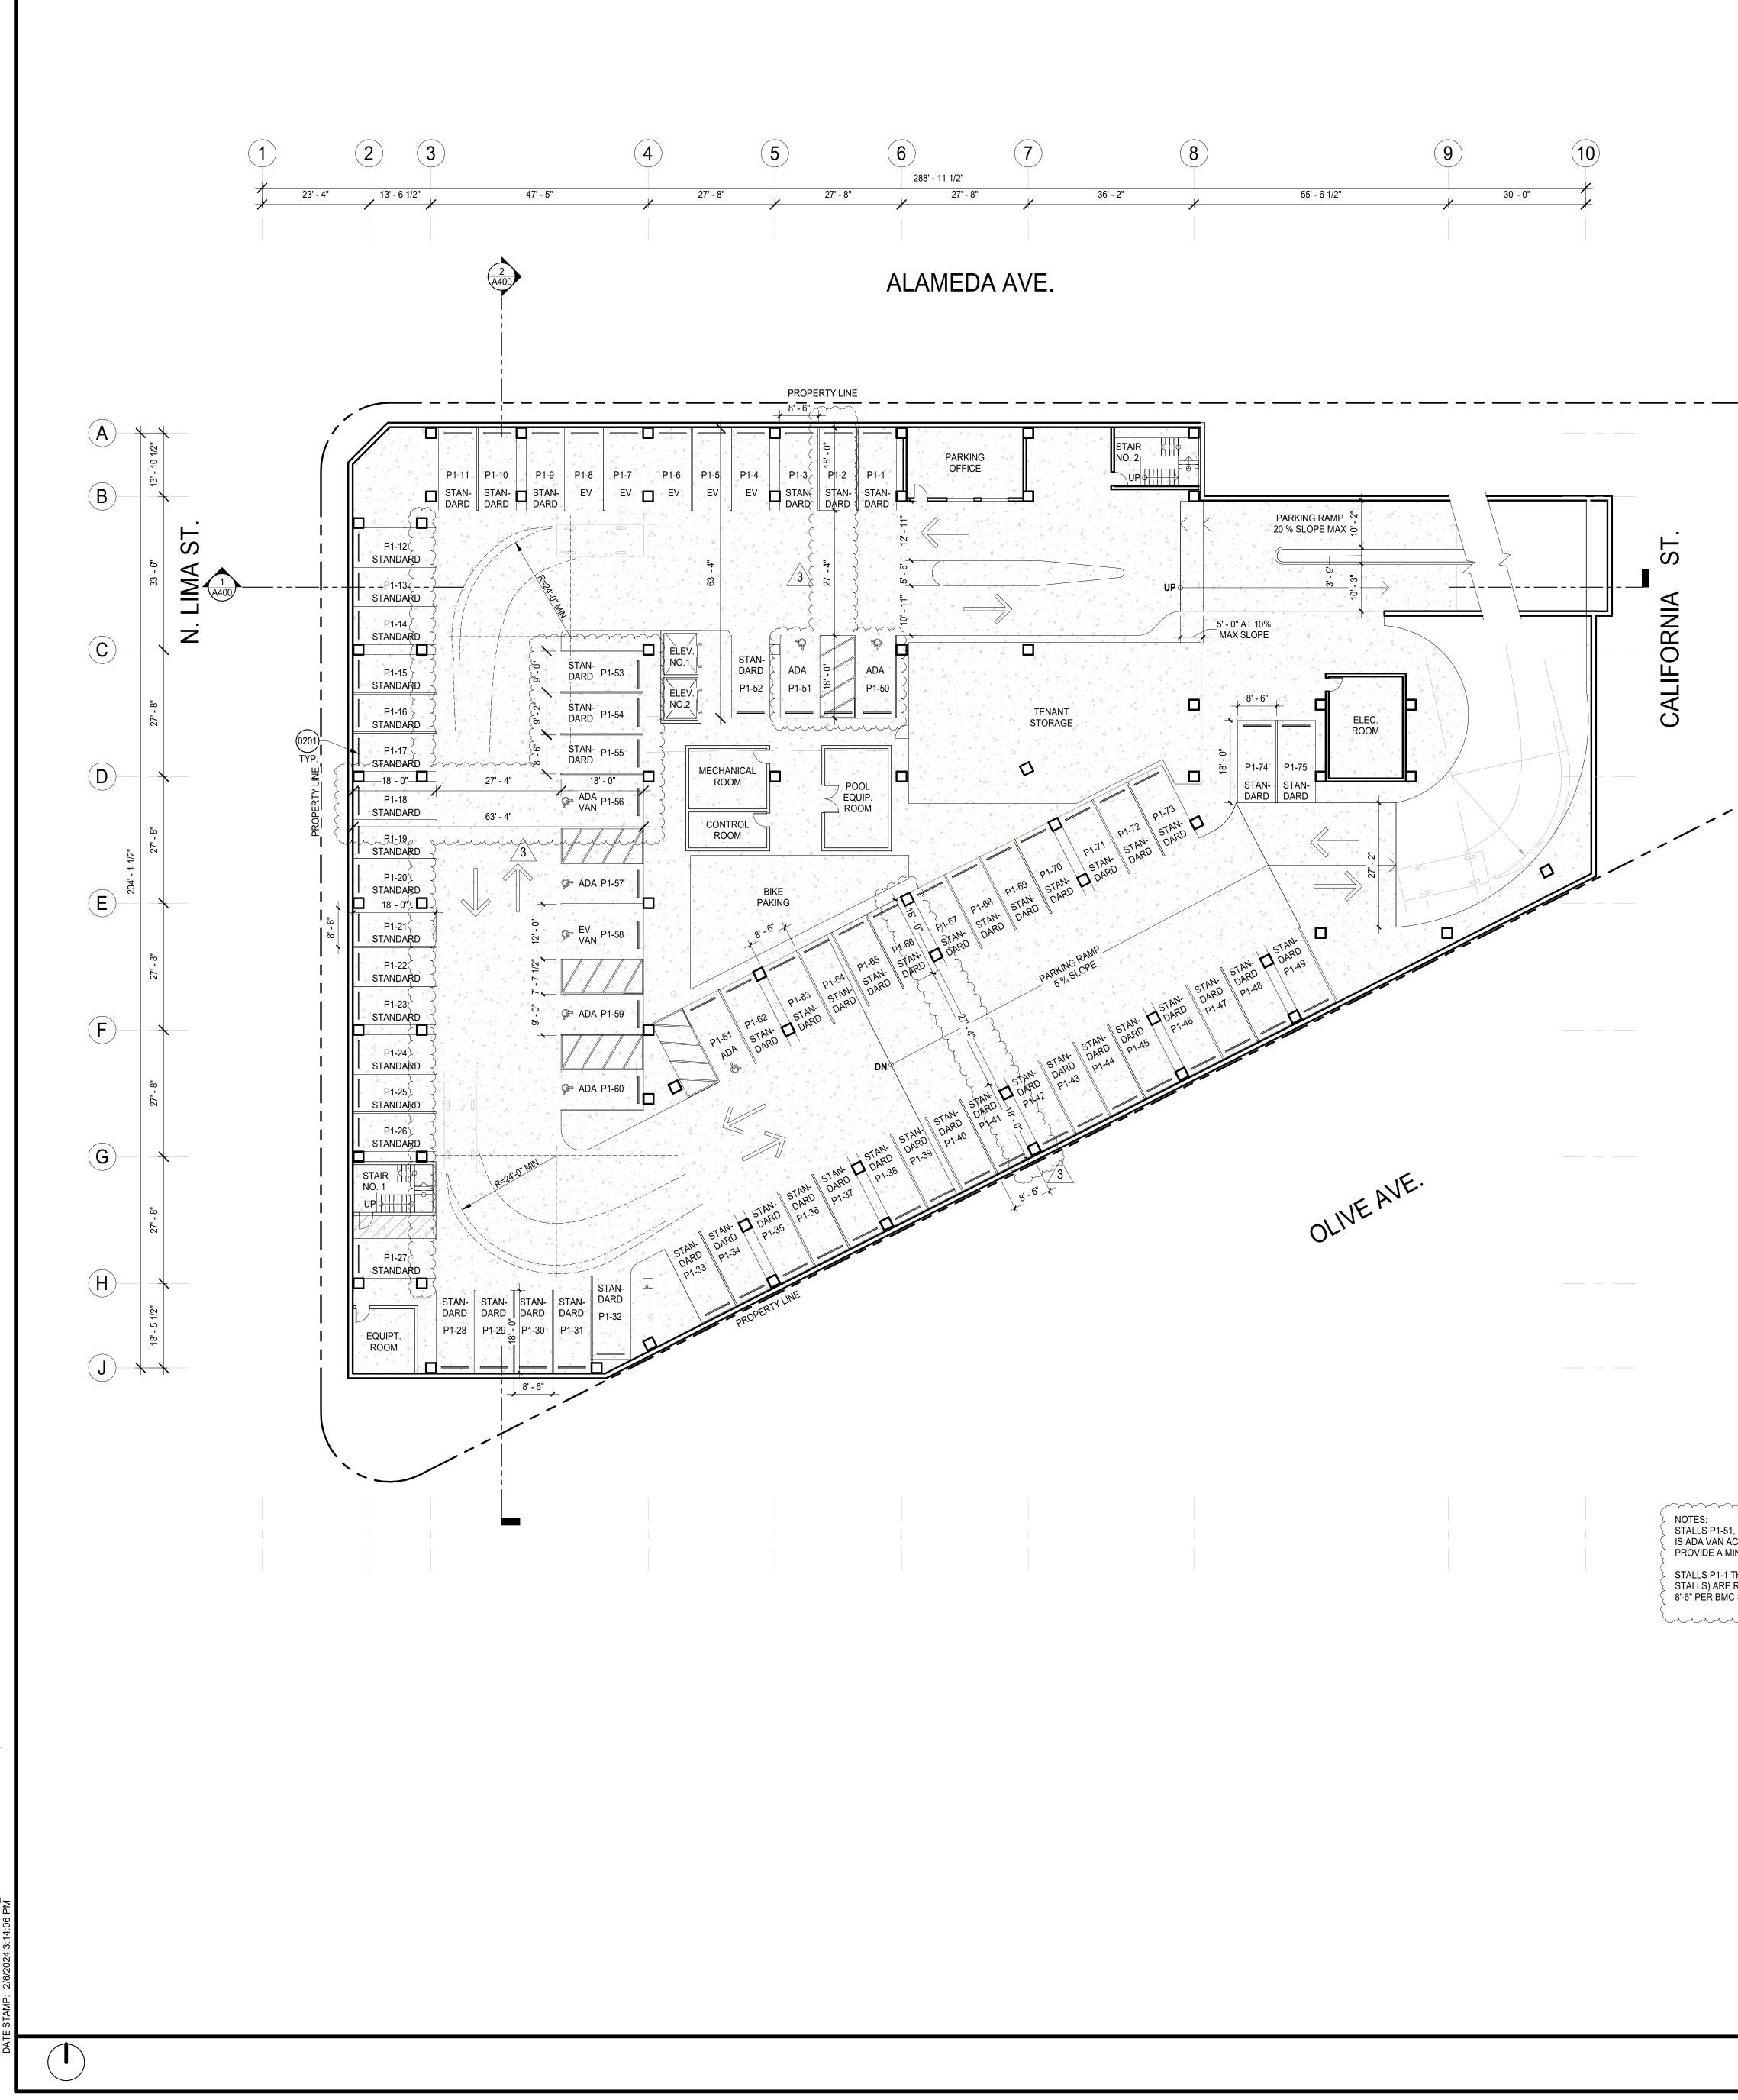


	0201 WHEELSTOP, TY	P. AT ALL STALLS.		
		GENERAL	NOTES	
	2. REFER TO SHEET AC	ND A004 FOR GENERAL NOTES. 01 FOR SYMBOLS AND ABBREVIATION DMPLY WITH CURRENTLY ADOPTED IC		BY JURISDICTION HAVING
	CONTRACTOR SHAL	IMENSIONS OR OBJECTS OF ANY KINE L VERIFY ALL CONDITIONS AND DIMEN (. CONTRACTOR SHALL BRING ANY DIS	SIONS IN THE FIELD BE	FORE PROCEEDING WITH
	ARCHITECT'S ATTEN 5. ALL DIMENSIONS AR	TION PRIOR TO PROCEEDING WITH AN E TO FACE STUD U.O.N. FINISH FLOOR NCRETE UNDERLAYMENT U.O.N. CEILIN	NY RELATED WORK. E ELEVATIONS ARE TO T	OP OF CONCRETE SLAB
	 DIMENSIONS MARKE MATERIALS ARE INS⁻ ALL FRAMING MEMB 	ERS SHALL BE SO ARRANGED AND SP	ACED AS TO PERMIT IN	STALLATION OF PIPE
	STIFFENERS, BRACE ALL WALL MOUNTED ACCESSORIES, GRA		G BRACKETS AS REQUI	RED FOR THE INSTALLATION , FIXTURES, BATHROOM
	SECTION 2303.2. WO SHEATHING, SILL PL 9. ADJUST FRAMING CO	IN EXTERIOR WALLS TO BE FIRE-RET, OD FRAMING TO INCLUDE, BUT NOT LI ATES, TOP PLATES, ETC. ONFIGURATION AT ALL FAN COIL UNITS	MITED TO: STUDS, BLO S WITHIN FLOOR/ CEILIN	CKING, EXTERIOR PLYWOOD
	INFORMATION. 10. ALL WOOD FRAMING 11. ALL FINISH WALL SU	ED ASSEMBLY. REFER TO MECHANICAL IN CONTACT WITH CONCRETE IS TO E RFACES TO BE FLUSH U.O.N. PROVIDE	BE PRESSURE TREATED). D.
	13. REFER TO SHEET A8 14. REFER TO SHEET A7	WALLS AND CEILINGS TO BE TAPED, 3 00 FOR WALL TYPES. 00 FOR DOOR SCHEDULE AND DETAIL 10 FOR FINISH, LIGHT FIXTURE, APPLI/	S AND WINDOW SCHEE	OULE AND DETAILS.
	SCHEDULES. 16. ALL LIGHTING TO BE CARPORTS, GARAGE	SHIELDED TO ELIMINATE GLARE ONT ES, PARKING AREAS, AND DRIVEWAYS Y PER BMC 10-1-2017 (G)(2)	O ADJACENT PROPERT	ES PER BMC 10-1-2017 (H) (1)
	17. (NOT USED) 18. LIGHTS CONFORMIN	G TO STANDARDS PRESCRIBED BY TH NG LOTS USED FOR PUBLIC PARKING		
	19. PER TABLE N-5 OF T ACHIEVE INTERIOR N TRANSPORTATION S	HE BURBANK 2035 GENERAL PLAN THI NOISE LEVELS US 45DBA MAX. PER TAB OURCES OF THE GENERAL PLAN.	BLE N-3 MAXIMUM ALLO	WABLE NOISE EXPOSURE -
		BE CONSTRUCTED INCORPORATING E ERGY, WATER, AND OTHER NATURAL S.		
		LEGE	ND	
I-51, P1-52, P1-53, & P1-54 (A TOTAL OF 4 STALLS, IN WHICH P1-51 N ACCESSIBLE) ARE RESERVED FOR COMMERCIAL USE & A MINIMUM WIDTH OF 9'-0" PER BMC SECTION 10-1-1401.	N.I.C.	NOT IN CONTRACT	ALIGN —	ALIGN ELEMENTS
I-1 THROUGH P1-50 & P1-55 THROUGH P2-116 (A TOTAL OF 177 RE RESERVED FOR RESIDENTIAL USE & PROVIDE A MINIMUM OF 3MC SECTION 10-1-1401.		EXISTING MILLWORK	RM NAME #	ROOM NAME AND NUMBE
<u> </u>		NEW MILLWORK	F.E.C.	FIRE EXTINGUISHER CAB
		EXISTING PARTITION	<u></u>	NEW PLUMBING FIXTURE
		EXISTING DOOR		
	C# -	— WALL TAG. REFER TO A800		
		NEW PARTITION PER PLAN		
	A" TYP.			
		NEW DOOR		
	1001	DOOR NUMBER. REFER TO A700		
	<##	— WINDOW TAG. REFER TO A700 NEW GLAZING OR STOREFRONT		
		NEW GLAZING OR STOREFRONT SYSTEM PER SCHEDULE.		
FLOOR PLAN - P-1 1	$\langle \mathbf{A} \rangle$	NEW PLUMBING FIXTURE, APPLIANCE, OR EQUIPMENT. REFER TO A710		
1/16" = 1'-0"				

KEYNOTES

0201 WHEELSTOP, TYP. AT ALL STALLS.

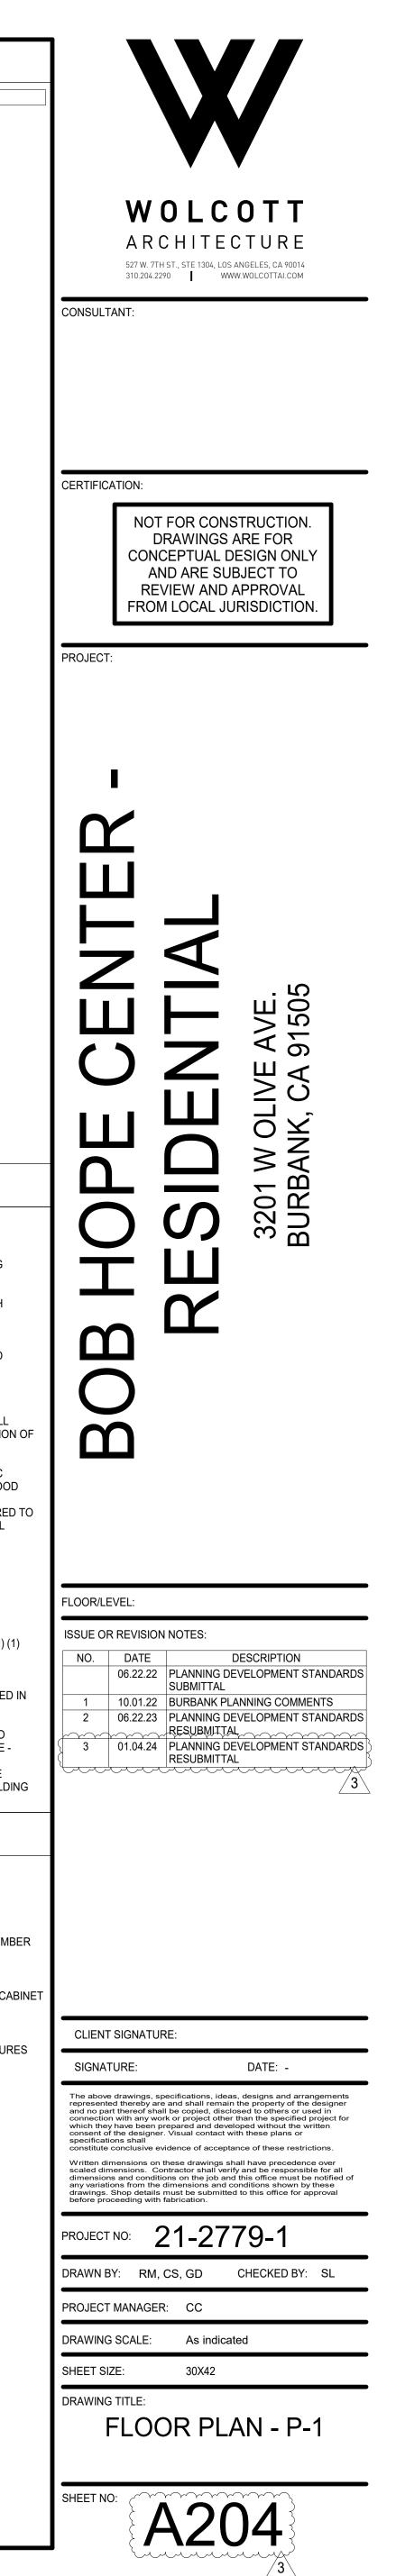


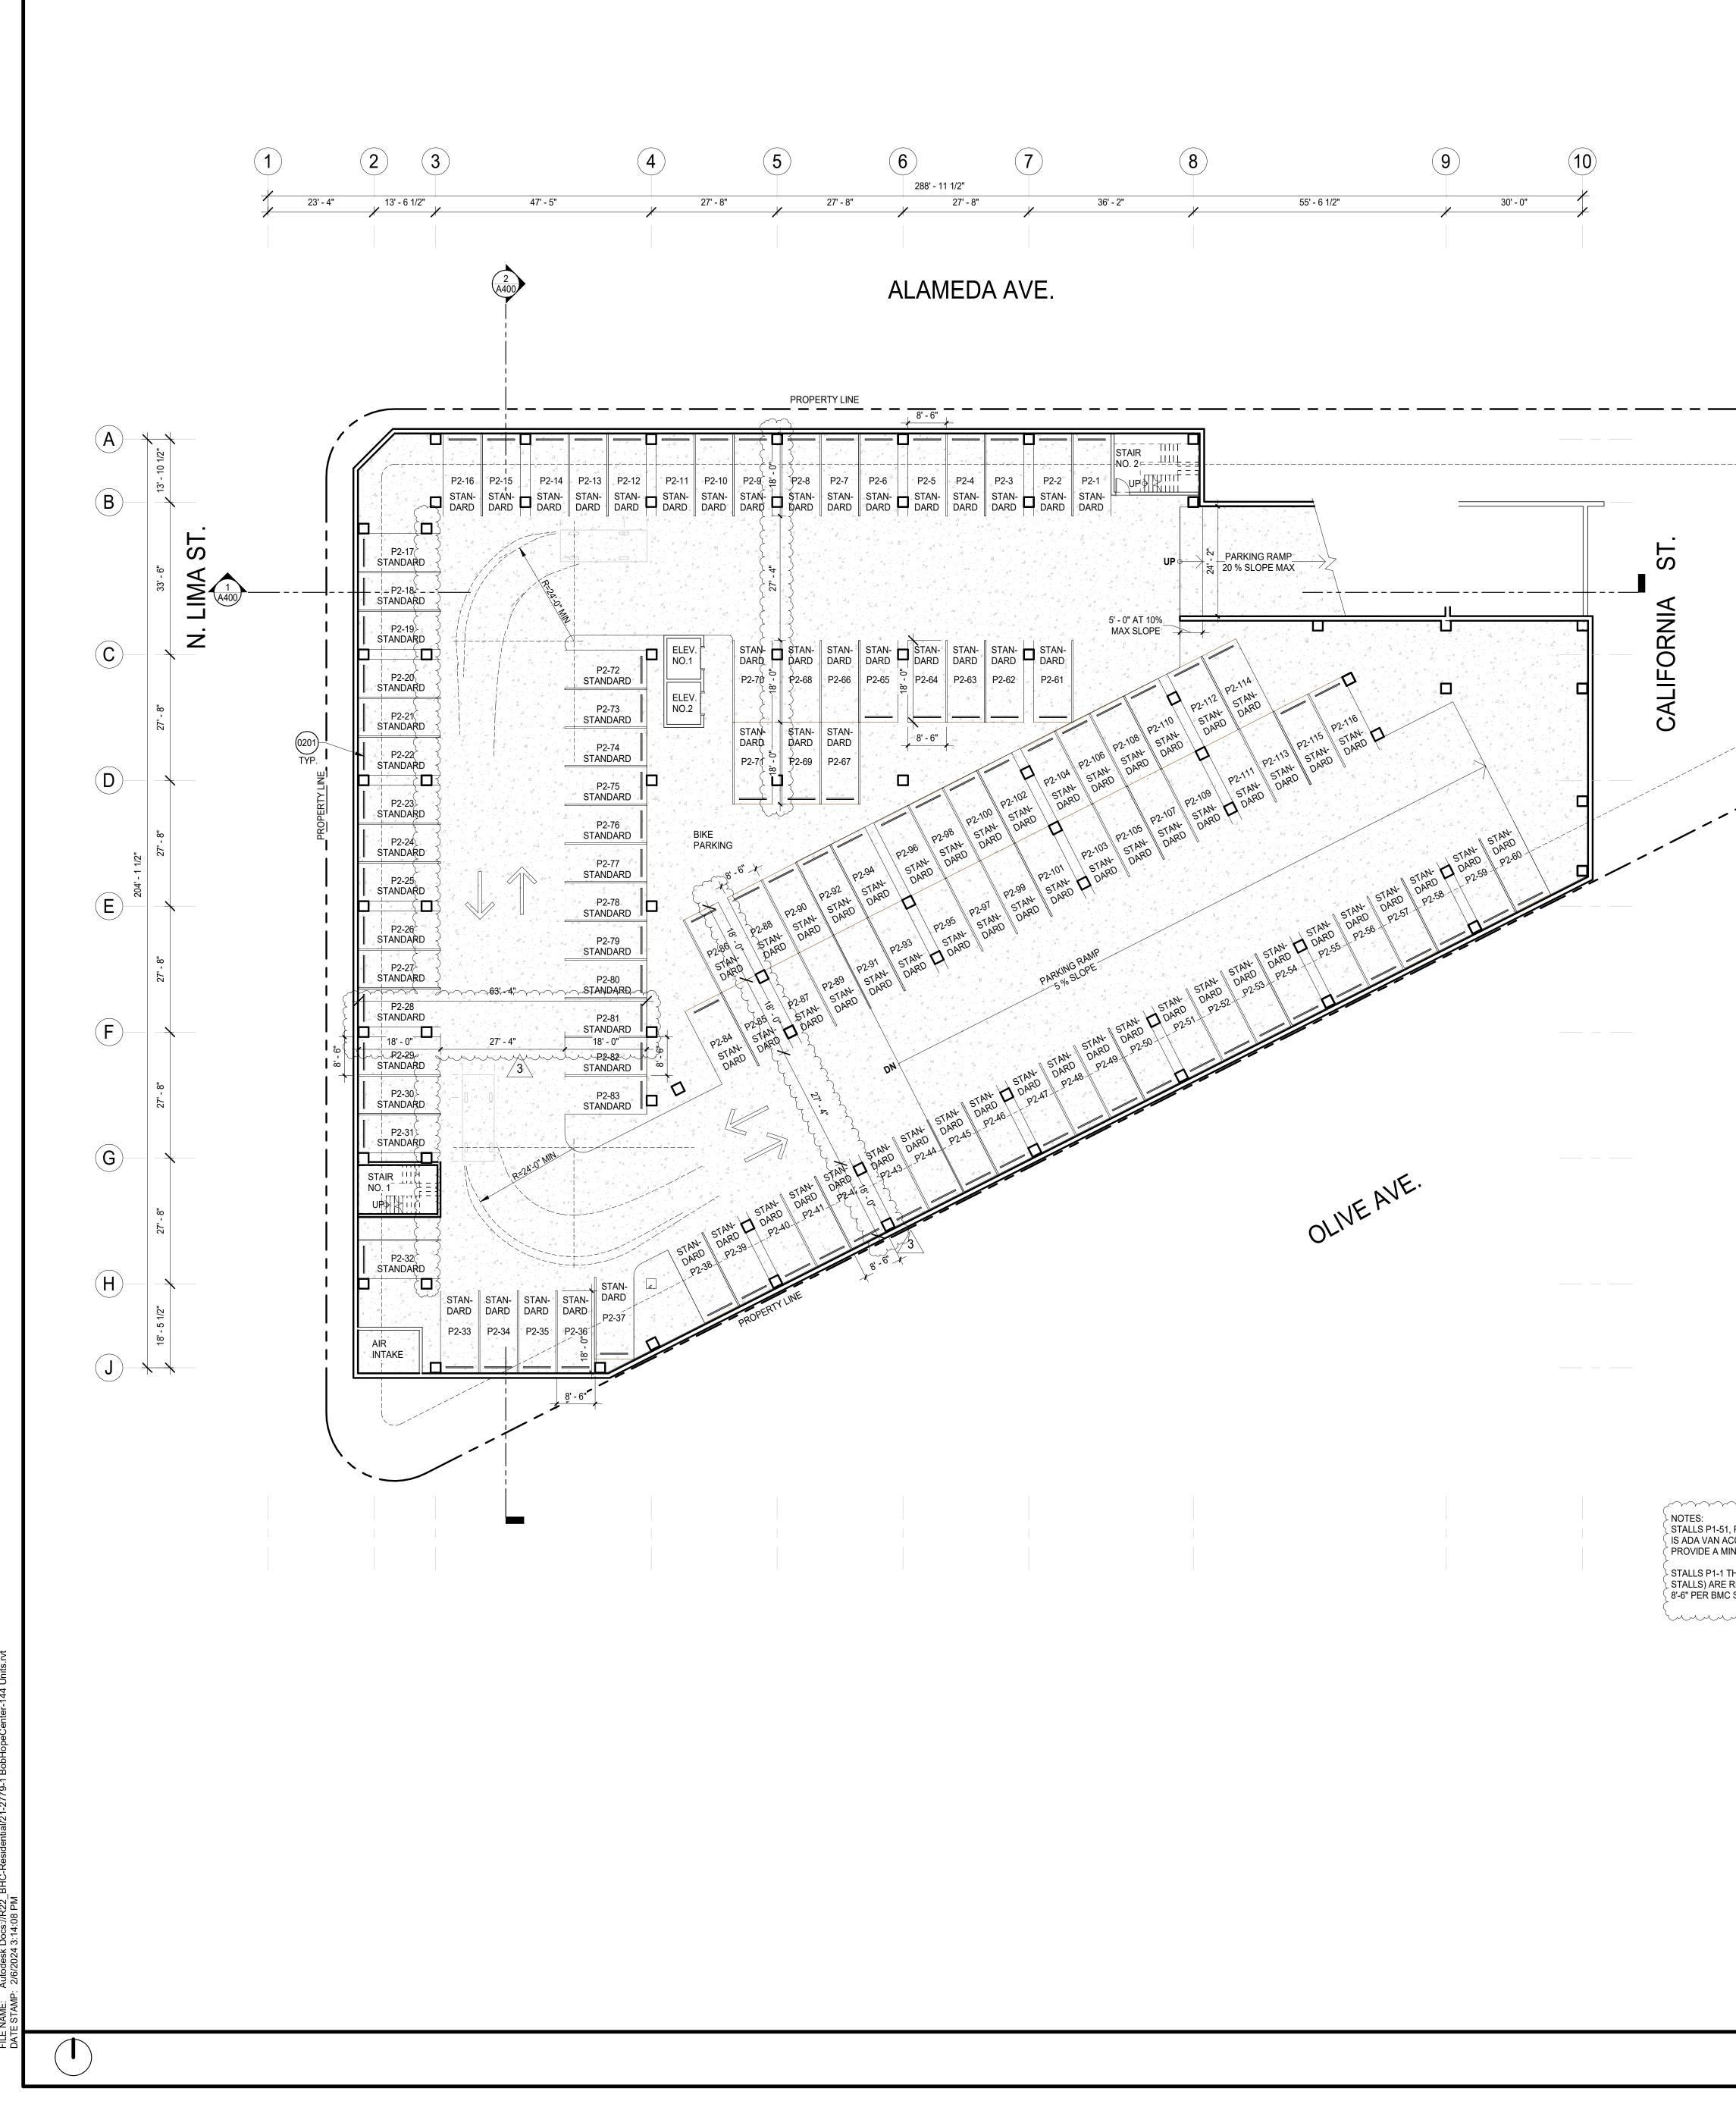


	 REFER TO SHEET A0 ALL WORK SHALL CO AUTHORITY. IN NO CASE SHALL D CONTRACTOR SHALL SUBSEQUENT WORK ARCHITECT'S ATTEN ALL DIMENSIONS AR AND/OR TOP OF CON SURFACES U.O.N. DIMENSIONS MARKE MATERIALS ARE INST ALL FRAMING MEMBI CONDUITS AND DUC STIFFENERS, BRACE ALL WALL MOUNTED ACCESSORIES, GRAI ALL WOOD FRAMING SECTION 2303.2. WO SHEATHING, SILL PL/ ADJUST FRAMING CO MAINTAIN FIRE-RATE INFORMATION. ALL GYPSUM BOARD REFER TO SHEET A7 SCHEDULES. ALL LIGHTING TO BE CARPORTS, GARAGE PEDESTRIAN SAFET REFER TO SHEET A7 SCHEDULES. ALL LIGHTING TO BE CARPORTS, GARAGE PEDESTRIAN SAFET (NOT USED) LIGHTS CONFORMIN ALL NIGHTIME PARKI 10-1-1420. PER TABLE N-5 OF TH ACHIEVE INTERIOR N TRANSPORTATION S THIS PROJECT WILL 	ERS SHALL BE SO ARRANGED AND S TWORK WITH A MINIMUM OF CUTTIN S, BACK-UP PLATES AND SUPPORTIN O OR SUSPENDED MECHANICAL AND I B BARS, MILLWORK. IN EXTERIOR WALLS TO BE FIRE-RE OD FRAMING TO INCLUDE, BUT NOT ATES, TOP PLATES, ETC. ONFIGURATION AT ALL FAN COIL UNIT D ASSEMBLY. REFER TO MECHANIC/ G IN CONTACT WITH CONCRETE IS TO RFACES TO BE FLUSH U.O.N. PROVID WALLS AND CEILINGS TO BE TAPED WALLS AND CEILINGS TO BE TAPED WALLS AND CEILINGS TO BE TAPED TO FOR DOOR SCHEDULE AND DETA TO FOR FINISH, LIGHT FIXTURE, APPL SHIELDED TO ELIMINATE GLARE ON ES, PARKING AREAS, AND DRIVEWAY Y PER BMC 10-1-2017 (G)(2) IG TO STANDARDS PRESCRIBED BY T ING LOTS USED FOR PUBLIC PARKING HE BURBANK 2035 GENERAL PLAN TH NOISE LEVELS US 45DBA MAX. PER T/ SOURCES OF THE GENERAL PLAN. BE CONSTRUCTED INCORPORATING ERGY, WATER, AND OTHER NATURAL	NS LEGEND. CC, NFPA, IAPMO, ASME ND BE SCALED FROM AN' NSIONS IN THE FIELD BE ISCREPANCIES OR CLAF ANY RELATED WORK. R ELEVATIONS ARE TO T ING HEIGHT DIMENSIONS ANCE THAT MUST BE MA PACED AS TO PERMIT IN G. CONTRACTOR SHALL NG BRACKETS AS REQUI ELECTRICAL EQUIPMENT TARDANT TREATED WOO LIMITED TO: STUDS, BLO TS WITHIN FLOOR/ CEILIN AL AND STRUCTURAL DR D BE PRESSURE TREATED DE FURRING AS REQUIRE , SANDED, AND PRIMED ILS AND WINDOW SCHEE IANCE, EQUIPMENT, AND TO ADJACENT PROPERT S SHALL CONTAIN SECU THE PUBLIC WORKS DIRE G OR FOR COMMERCIAL HIS PROJECT WILL BE CO ABLE N-3 MAXIMUM ALLO BUILDING DESIGN FEAT	Y DRAWINGS. THE FORE PROCEEDING WITH RIFICATIONS TO THE OP OF CONCRETE SLAB S ARE TO BE TO FINISHED AINTAINED WHEN FINISH STALLATION OF PIPE PROVIDE AND INSTALL ALL RED FOR THE INSTALLATION , FIXTURES, BATHROOM OD COMPLYING WITH CBC CKING, EXTERIOR PLYWOOI AG ASSEMBLY AS REQUIRED AWINGS FOR ADDITIONAL D. D. TO LEVEL 4 FINISH U.O.N. OULE AND DETAILS. O PLUMBING FIXTURE IES PER BMC 10-1-2017 (H) (1 RITY LIGHTING. PRIMARY CTOR SHALL BE INSTALLED PURPOSES. PER BMC ONSTRUCTED IN A WAY TO WABLE NOISE EXPOSURE - URES THAT MINIMIZE THE
s1, P1-52, P1-53, & P1-54 (A TOTAL OF 4 STALLS, IN WHICH P1-51 ACCESSIBLE) ARE RESERVED FOR COMMERCIAL USE & MINIMUM WIDTH OF 9-0" PER BMC SECTION 10-1-1401. 11 THROUGH P1-50 & P1-55 THROUGH P2-116 (A TOTAL OF 177 RESERVED FOR RESIDENTIAL USE & PROVIDE A MINIMUM OF AC SECTION 10-1-1401.		LEGE NOT IN CONTRACT EXISTING MILLWORK NEW MILLWORK EXISTING PARTITION EXISTING DOOR WALL TAG. REFER TO A800 NEW PARTITION PER PLAN NEW DOOR DOOR NUMBER. REFER TO A700 EXISTING OR STOREFRONT		ALIGN ELEMENTS ROOM NAME AND NUME FIRE EXTINGUISHER CA NEW PLUMBING FIXTUR
FLOOR PLAN - P-2 1/16" = 1'-0"	$\langle \mathbf{A} \rangle$	NEW PLUMBING FIXTURE, APPLIANCE, OR EQUIPMENT. REFER TO A710		

KEYNOTES


0201 WHEELSTOP, TYP. AT ALL STALLS.

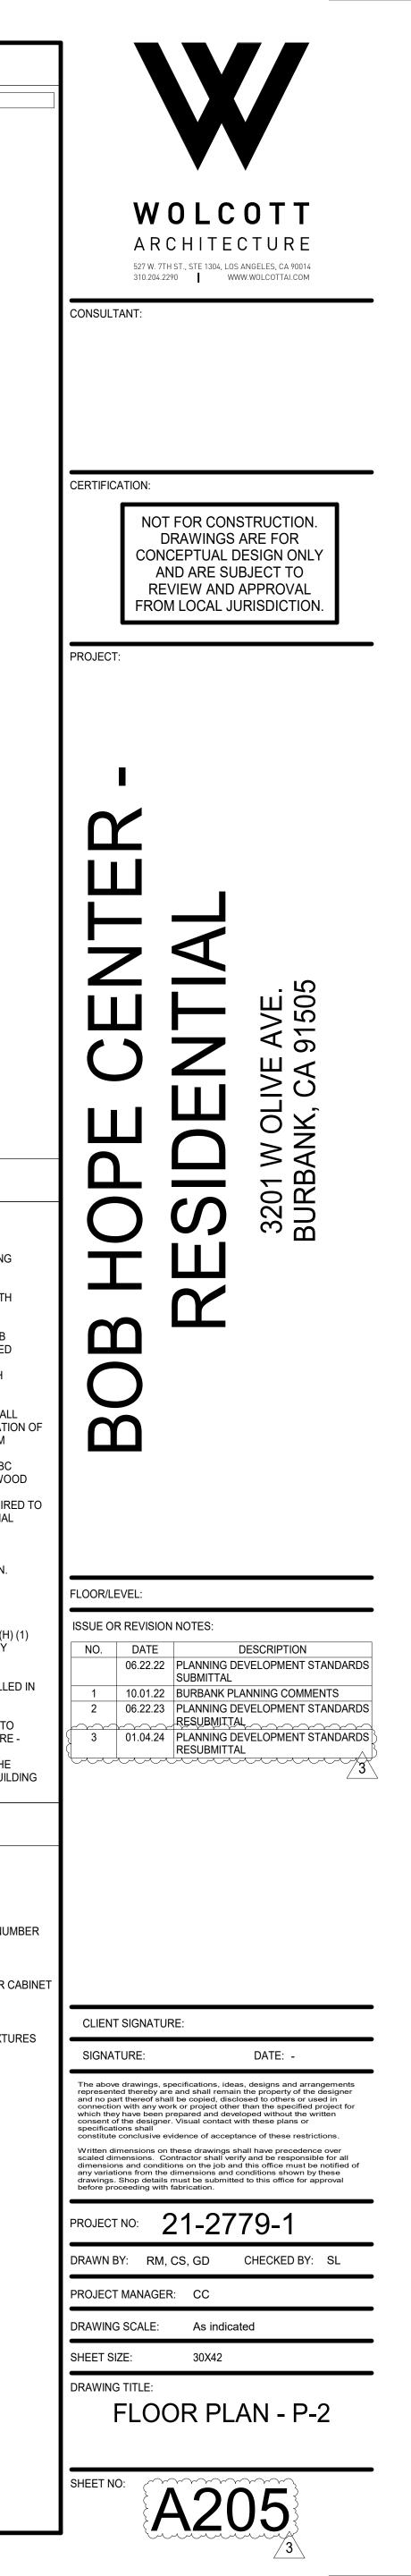


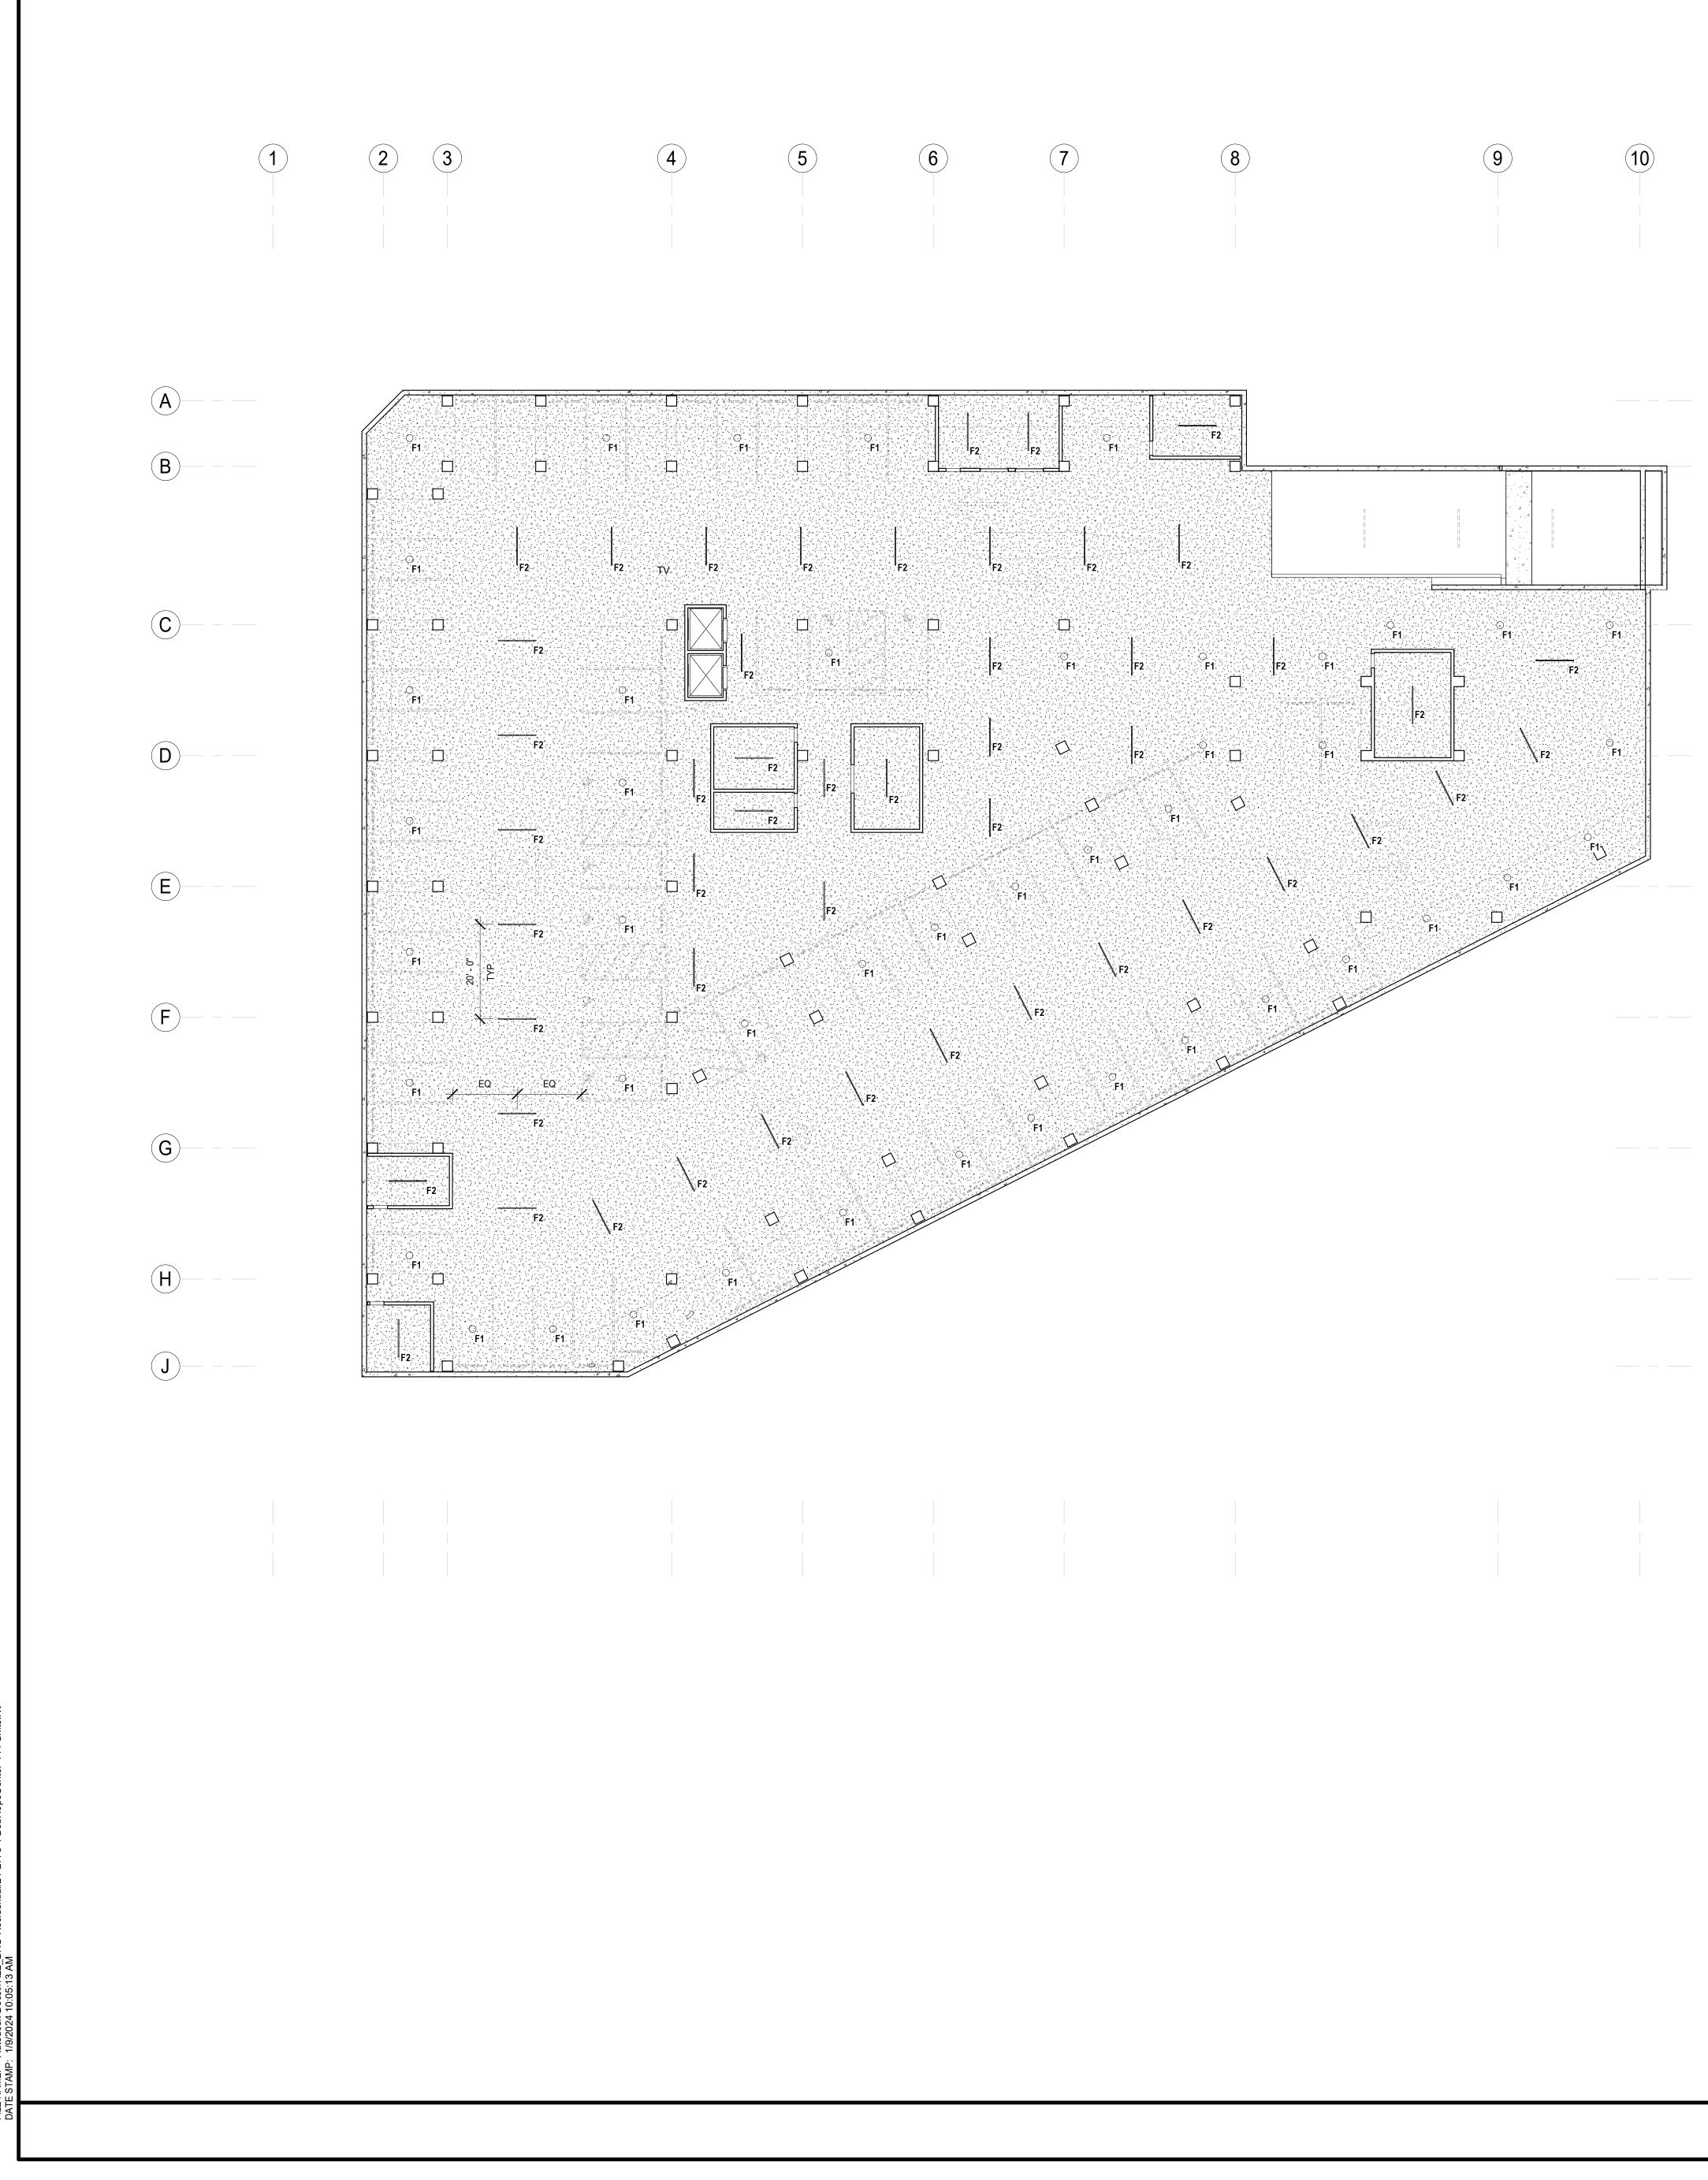


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	KEYNOTES
	1. ALL FIXTURES SHALL HAVE APPROPRIATE UL LABEL, DAMP, OR WET AS REQUIRED BY LOCAL CODES.
	 ALL FIXTURES SHALL INCLUDE ALL ACCESSORIES FOR INSTALLATION ACCORDING TO ALL LOCAL, SEISMIC, A NATIONAL CODES. ALL FIXTURES SUSPENDED OVER 18" SHALL BE SEISMICALLY BRACED IN ACCORDANCE WITH CBC 1617A.1.18 ASCE, SECTION 13.1.4 ADDEDING ANY LIGUTING FOURDMENT, THE CONTRACTOR SHALL VERIEV ALL LOCATIONS AND REC
	 PRIOR TO ORDERING ANY LIGHTING EQUIPMENT, THE CONTRACTOR SHALL VERIFY ALL LOCATIONS AND REC DEPTHS. FIXTURES REQUIRING "TRAPEZE"-TYPE OR OTHER NON-STANDARD INSTALLATION SHALL BE IDENT AT TIME OF BID. ALL LAMPS SHALL BE INSTALLED ACCORDING TO THE FIXTURE SCHEDULE. REFER TO SHEET A720. CONTRACTOR SHALL VERIFY FINAL VOLTAGES, DRIVER LOCATIONS AND CEILING TRIM COMPATIBILITY PRIOF
	 ORDERING FIXTURES. CEILING THICKNESS IN EXCESS OF 3/4" SHALL BE IDENTIFIED IN WRITING BY CONTRACTOR/ARCHITECT. ALL FIXTURES SHALL BE ORDERED WITH THE APPROPRIATE BALLASTS THAT HAVE UL AND CBM LABELS. ALL BALLASTS MUST CONFORM TO TITLE 24 REQUIREMENTS FOR PERFORMANCE, SWITCHING, AND WIRING (I.E.
	 TANDEM). 9. PROVIDE APPROVED FIRE-RATED ENCLOSURES FOR ALL LIGHTING FIXTURES LOCATED IN A FIRE-RATED CE 10. WALLS DIRECTLY ILLUMINATED SHALL BE INSTALLED AND FINISHED IN A MANNER TO ELIMINATE SHADOWS (BLEMISHES (I.E. HANG DRY WALL VERTICALLY. PROVIDE LEVEL 5 FINISH).
	 RESPONSIBILITY FOR EMERGENCY LIGHTING, EGRESS PHOTOMETRICS, TITLE 24 CALCULATIONS, AND CIRCU TO MEET CODE CONFORMANCE REMAINS WITH THE ELECTRICAL ENGINEER OR DESIGN-BUILD SUBCONTRA AS REQUIRED BY LAW. ALL FIXTURES LOCATED IN AN INSULATED CEILING AREA, SHOULD HAVE AN IC HOUSING (ELECTRICAL
	 CONTRACTOR TO COORDINATE). 13. ANY FIXTURE SUBSTITUTIONS MUST BE APPROVED BY WOLCOTT PRIOR TO BID. CONTRACTOR MUST BE PREPARED TO SUPPLY A SAMPLE AND/OR PHOTOMETRIC DATA IF REQUESTED. IF SUBSTITUTION IS REJECT CONTRACTOR MUST BE PREPARED TO PROVIDE SPECIFIED PRODUCT WITHOUT DELAY.
	14. ALL LIGHTING CONTROL DIMMERS SHALL HAVE PRESET RECALL FUNCTIONALITY. 15. FIXTURES WITH DUAL CIRCUITS SHALL SEPARATE DIMMING CONTROLS FOR DIRECT AND INDIRECT LIGHTING
	1. SEE SHEETS A003 AND A004 FOR GENERAL NOTES.
	 REFER TO SHEET A001 FOR SYMBOLS AND ABBREVIATIONS LEGEND. ALL WORK SHALL COMPLY WITH CURRENTLY ADOPTED ICC, NFPA, IAPMO, ASME BY JURISDICTION HAVING AUTHORITY. LIGHT FIXTURES SHOWN ON PLAN ARE NEW U.O.N.
	 REVIEW SWITCH LOCATION WITH ARCHITECT PRIOR TO WIRING OR SETTING OF J-BOX FOR APPROVAL. SWITCHES AND DEVICE TYPE: MATCH EXISTING U.O.N. UNDER CABINET LIGHTING SHALL BE HARDWIRED TO A WALL SWITCH. ALL LIGHTING AND CONTROLS TO CONFORM TO TITLE 24 ENERGY CODE REQUIREMENTS.
	 REVIEW LOCATION OF ALL WALL DEVICES WITH ARCHITECT PRIOR TO INSTALL. INCLUDING BUT NOT LIMITED SWITCHES, OUTLETS, EXITING DEVICES, FIRE ALARM DEVISES, ETC. ALL NEW SPRINKLER HEADS WITHIN ALL NEW CEILING TYPES TO MATCH EXISTING / BE RECESSED / CONCEALED TYPE. WHERE CONCEALED TYPE HEADS OCCUR PROVIDE SPRINKLER HEAD CAP TO MATCH
	CEILING COLOR. 11. ALL NEW SQUARE CEILING DIFFUSERS TO BE PAINTED STEEL 'PLAQUE' TYPE DIFFUSER U.O.N. 12. PROVIDE CEILING ACCESS PANELS AS REQUIRED BY LOCAL GOVERNING AGENCIES FOR REQUIRED ACCESS ABOVE CEILING EQUIPMENT. PROVIDE PAINTED METAL ACCESS PANEL. PROVIDE SPECS FOR ARCHITECTS
	N.I.C. NOT IN CONTRACT
	EXISTING GYPSUM BOARD CEILING TO REMAIN. UPGRADE AS REQUIRED TO MEET CURRANT SEISMIC CODE.
	NEW GYPSUM BOARD CEILING
	EXISTING 2X2 SUSPENDED CEILING GRID AND ACOUSTIC TILES TO REMAIN. REPLACE DAMAGED GRID AND MISSING, DAMAGED, CHIPPED, OR STAINED TILES WITNER NOW. U.O.N. IF TILES ARE NOT UNIFORM, INSTALL NEW TILES IN ENTIRE ROOM AND
	RELOCATE TILES TO MAINTAIN A UNIFORM APPEARANCE. UPGRADE GRID AS REQUINTO MEET CURRENT SEISMIC CODE.
	LIGHT FIXTURE AND TAG. REFER TO SHEET A720.
	►X WALL MOUNTED EXIT SIGN. HATCH INDICATES ILLUMINATED FACE, ARROW
	 INDICATES DIRECTION. SEE ALSO FIRE DEPARTMENT NOTES. SEE DETAIL CEILING MOUNTED EXIT SIGN. HATCH INDICATES ILLUMINATED FACE, ARROW INDICA
	DIRECTION. SEE ALSO FIRE DEPARTMENT NOTES.
REFLECTED CEILING PLAN - P-1 1/16" = 1'-0"	



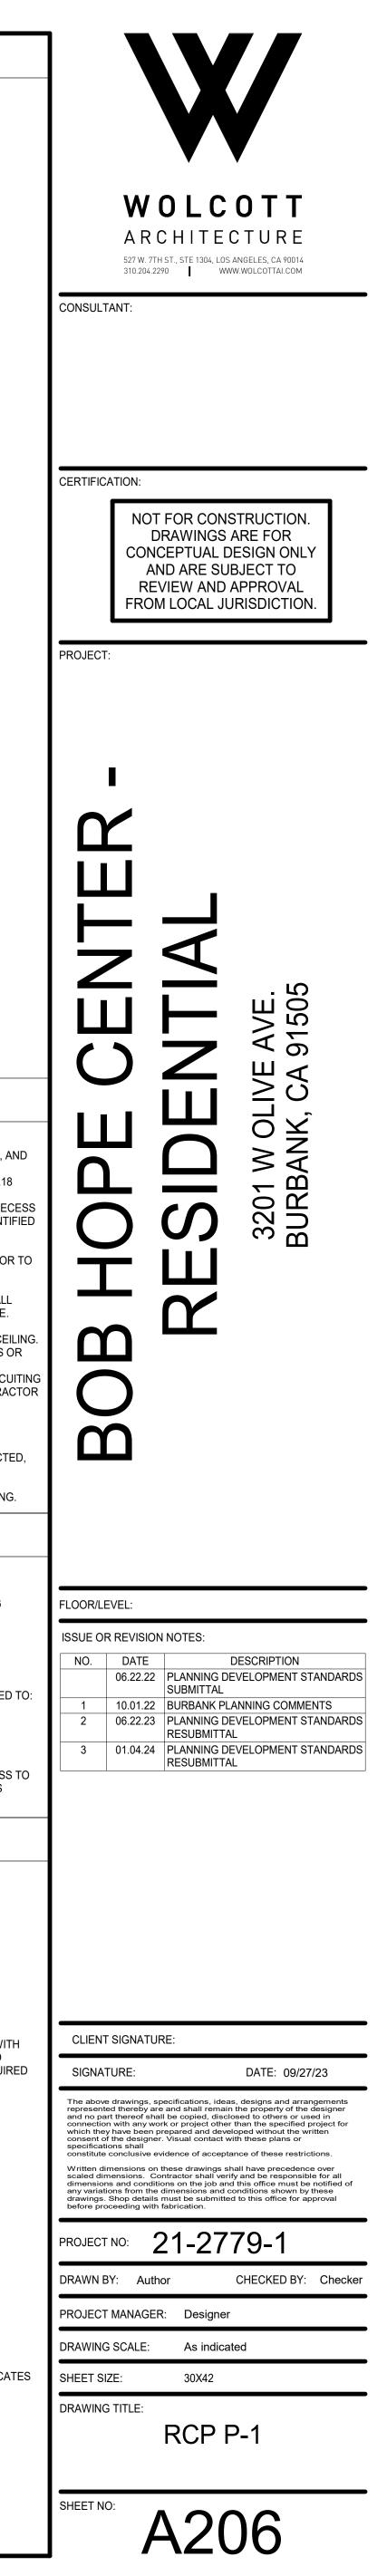

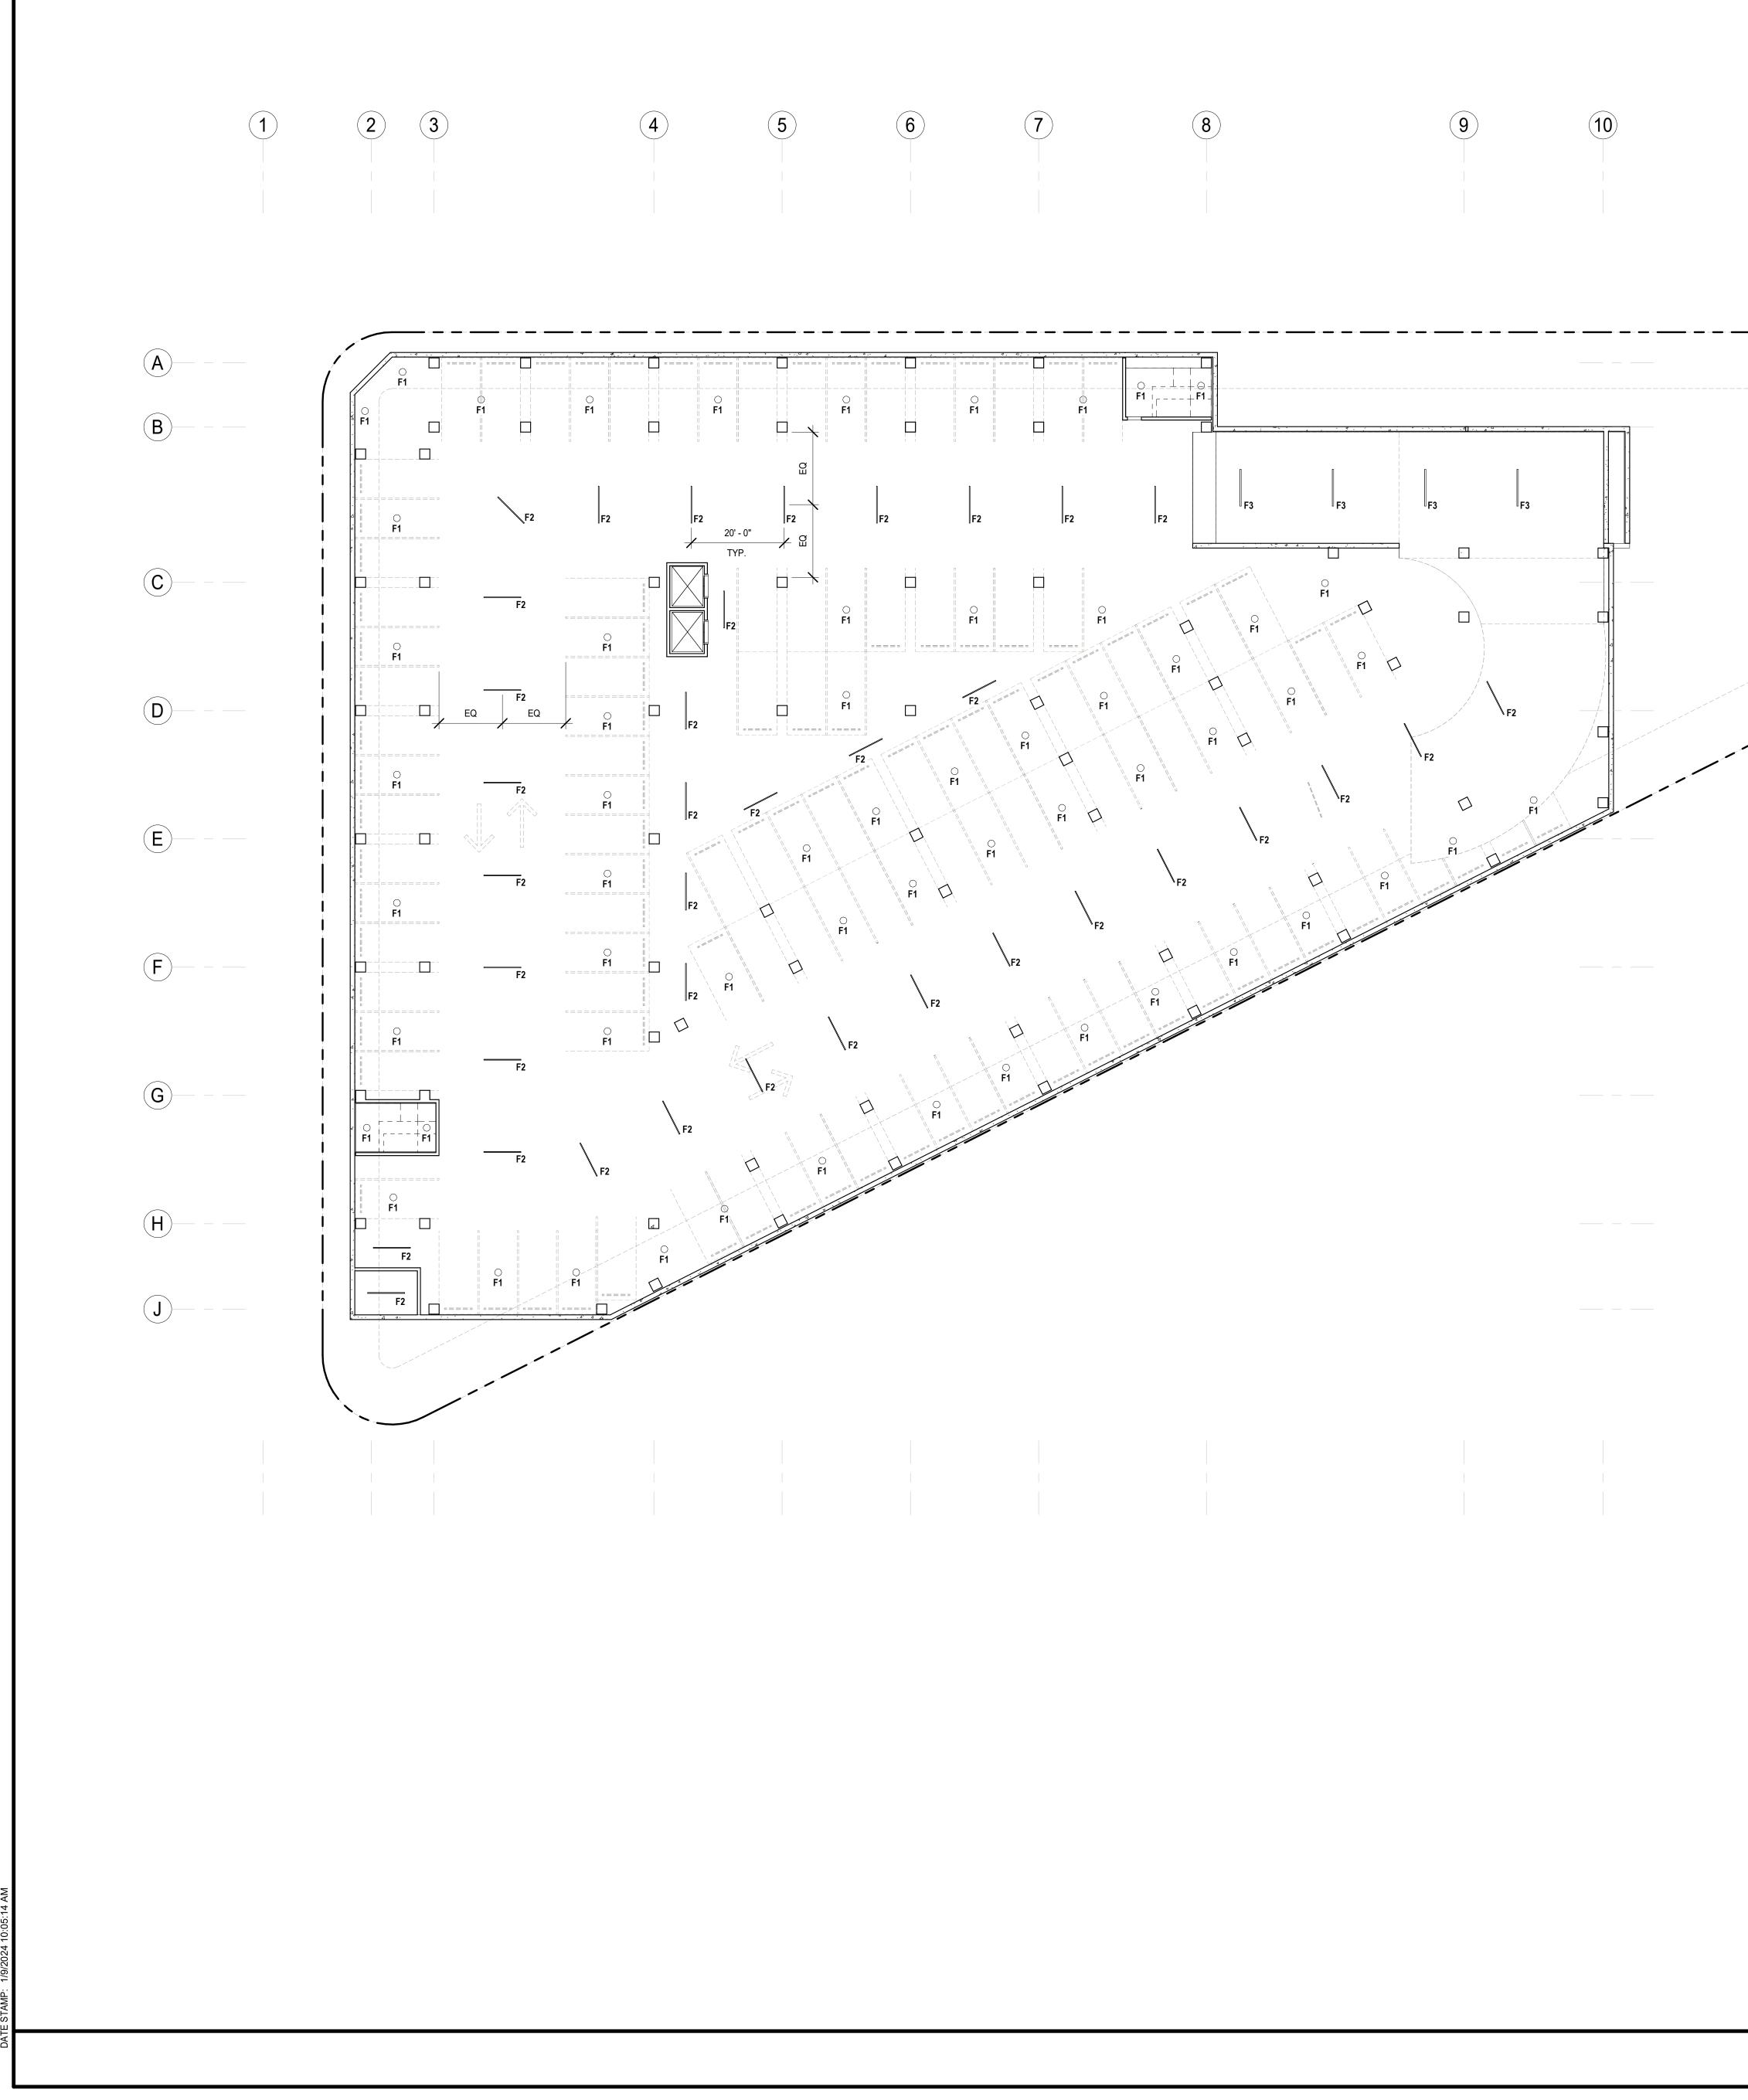

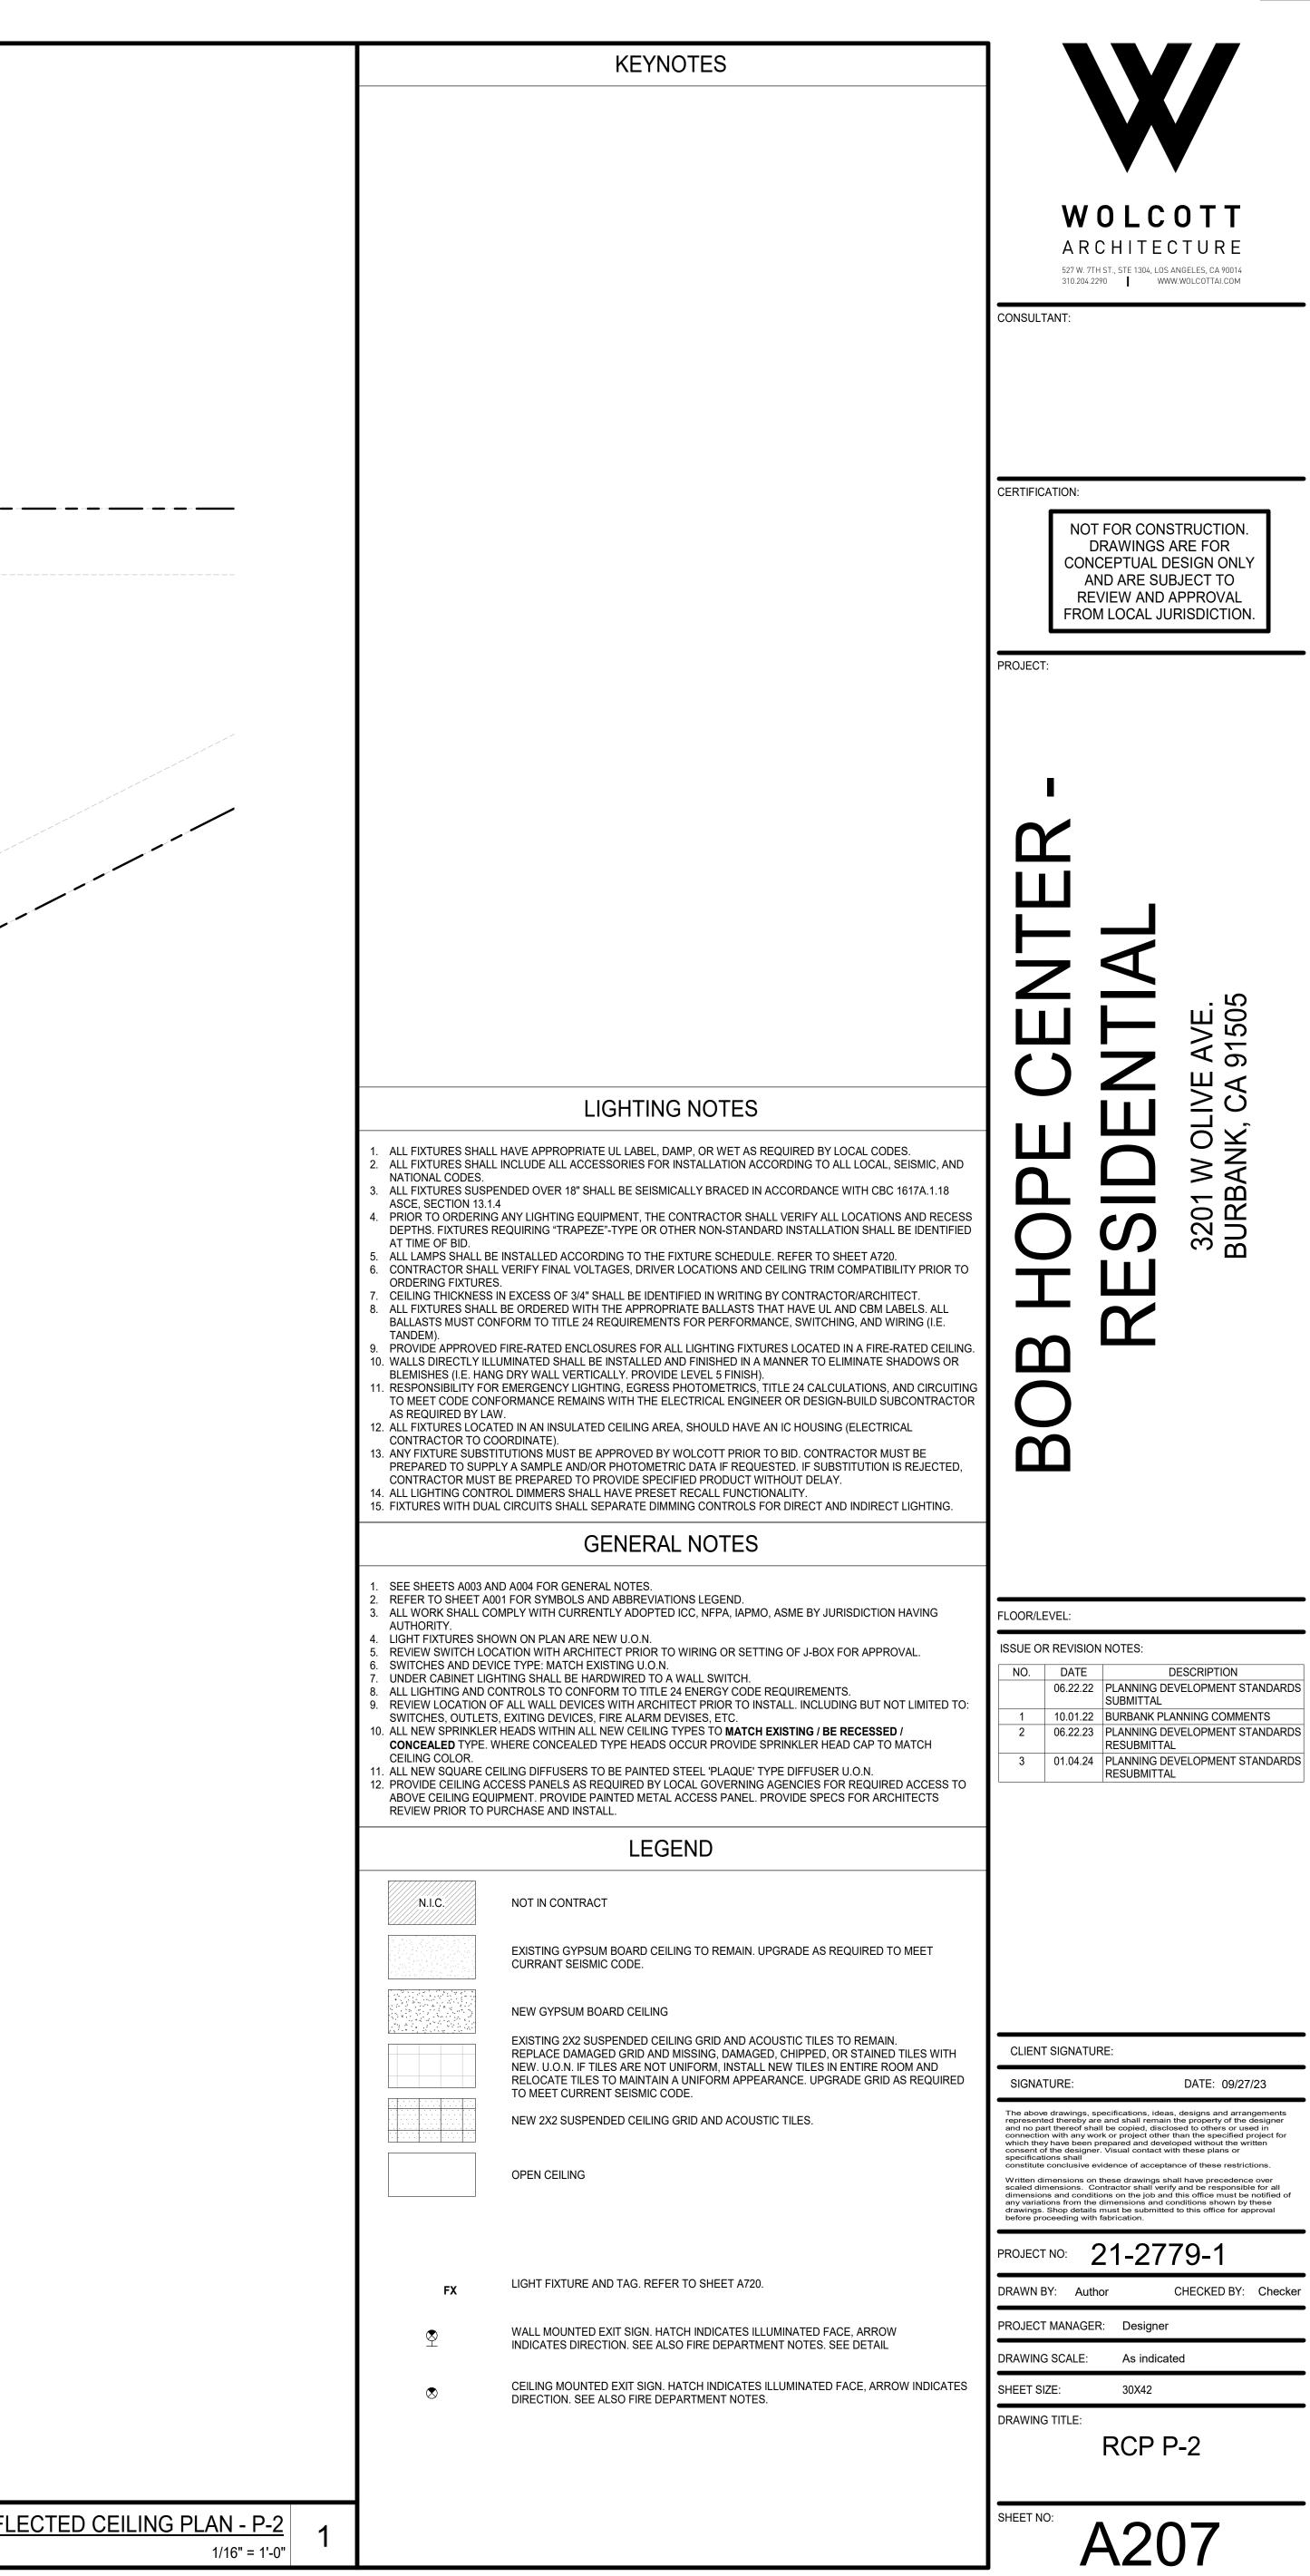

ED AT GROUND DEGREE E BUILDING R BMC	70.00°							 		•
	, t	 	 	— —	 	 	 	 	 	
I AREA: 16,700.80 SF REA: 9,114.27 SF			TYP.							

	KEYNOTES	
NOTES - DAVIS COLORS, DARK GREY (CARBON) 8084 - COLOR TO MATCH PT-1 COLOR TO MATCH PT-2 - PAINTED PT-1	2601 (N) EXTERIOR WALL MOUNTED LIGHTING BY SISTEMALUX OR EQUIV.	 (N) EXTERIOR GLAZING (N) EXTERIOR WINDOW (N) EXTERIOR DOOR SY SEE MATERIAL FINISH L NO MECHANICAL VENTIFEET FROM THE NEARE LOCATED ANYWHERE (ALL PROJECT LIGHTING LIGHT STANDARDS SHAPUBLIC RIGHT-OF-WAY ENERGY CONSERVATIONESIGN AND OPERATIONESIGN AND OPERATIONE SHALL BE LIMITED TO A A RESIDENTIAL ZONE W PERCENT REFLECTIVIT BUILDING ELEVATIONS SHALL BE LIMITED TO A A RESIDENTIAL ZONE W PERCENT REFLECTIVIT

			(MP) 1	10 13' - 0 1/2" 4 EQ PNL
		CALIFORNIA ST.	8' - 9 1/2" 10' - 9 1/2" 9' - 6" 1' - 2 1/2" 1' - 2 1/2" 9' - 6"	
				6 8. 91/2. 12.1/2. 109.1/2. 12.1/2. 109.1/2. 12.1/2. 109.1/2. 12.1/2. 109.1/2
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- 3	7' - 0 EQ P	" 'NL	4	6' - 2 EQ	3" PNL	 6' 2 EC	5 - 3"	-	, 7' - 2 EQ	- 3"	WF 1	(4		(MP 2	M	P 1				2 A40	0	W			3 _{T.0}
					_				/			+			' - 11" Q PNL	•			7' 2 EC	- 9" ? PNL	6' - 0 SLD I	DR		9' 3 EC	- 0" Q PNL		
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' - 2 1/2"	2' - 1"	6' - 0"	6' - 0"	7' - 2"	3'-0" DOOR 2601 TYP.	3' - 0"	CN 1	10' - 2"

	KEYNOTES	GENERAL NOTES
NOTES - DAVIS COLORS, DARK GREY (CARBON) 8084 - COLOR TO MATCH PT-1 COLOR TO MATCH PT-2 - PAINTED PT-1 PAINTED PT-1	2601 (IN) EXTERIOR WALL MOUNTED LIGHTING BY SISTEMALUX OR EQUIV.	 (N) EXTERIOR GLAZING SYSTEMS BY ARCADIA OR EQUIV. MFR. (N) EXTERIOR WINDOW SYSTEMS BY ARCADIA OR EQUIV. MFR. SEE MATERIAL FINISH LEGEND FOR OTHER MATERIAL FINISHES NO MECHANICAL VENTING SHALL FACE A RESIDENTIAL ZONE, UNLESS SUCH MECHANICAL VENTING SHALL BE LOCATED ANYWHERE ON THE BUILDING WITHIN 50 FEET FROM THE NEAREST RESIDENTIALLY ZONE PROPERTY. FURTHERNORE, NO MECHANICAL VENTING SHALL BE LOCATED ANYWHERE ON THE BUILDING WITHIN 50 FEET FROM THE NEAREST RESIDENTIALLY ZONE PROPERTY. ALL PROJECT LIGHTING SHALL BE COMPATIBLE WITH THE BUILDING ARCHITECTURE AND ADJACENT LIGHT STANDARDS IN THE PUBLIC (GHT-OF-WAY AND ADJACENT PROJECTS. ENERGY CONSERVATION SHALL BE COMPATIBLE WITH THE BUILDING ARCHITECTURE AND ADJACENT LIGHT STANDARDS IN THE PUBLIC (GHT-OF-WAY AND ADJACENT PROJECTS. ENERGY CONSERVATION SHALL BE COMPATIBLE WITH THE BUILDING ARCHITECTURE AND ADJACENT WITH THE LATEST TECHNICAL AND OPERATIONAL ENERGY CONSERVATION CONCEPTS. BUILDING ELEVATIONS FACING A RESIDENTIAL ZONE WITH 50 PROFENT OR MORE OF THE BUILDING SURFACE IN GLASS SHALL BE LIMITED TO A MAXIMUM OF 15 PERCENT OR NORE OF THEOR OF MORE OF THE BUILDING SURFACE IN GLASS SHALL BE LIMITED TO A MAXIMUM OF 15 PERCENT OF SURFACE IN GLASS SHALL BE LIMITED TO A MAXIMUM OF 20 PERCENT REFLECTIVITY FOR THOSE MATERIALS. BUILDING FUNCTIONS MATERIALS. BUILDING WITH LESS THAN 50 PERCENT OF SURFACE IN GLASS SHALL BE LIMITED TO A MAXIMUM OF 20 PERCENT REFLECTIVITY FOR THOSE MATERIALS.

FINISH SYMBOL GLAZING

VCT


W

WD

WS WΤ

SEALED CONCRETE STATIC DISSIPATIVE TILE SOLID SURFACING STAINLESS STEEL STONE SHEET VINYL TILE VINYL TILE VINYL COMPOSITION TILE WALL COVERING WOOD WAINSCOT WINDOW TREATMENT

1. SEE SHEETS A003 AND A004 FOR GENERAL NOTES.

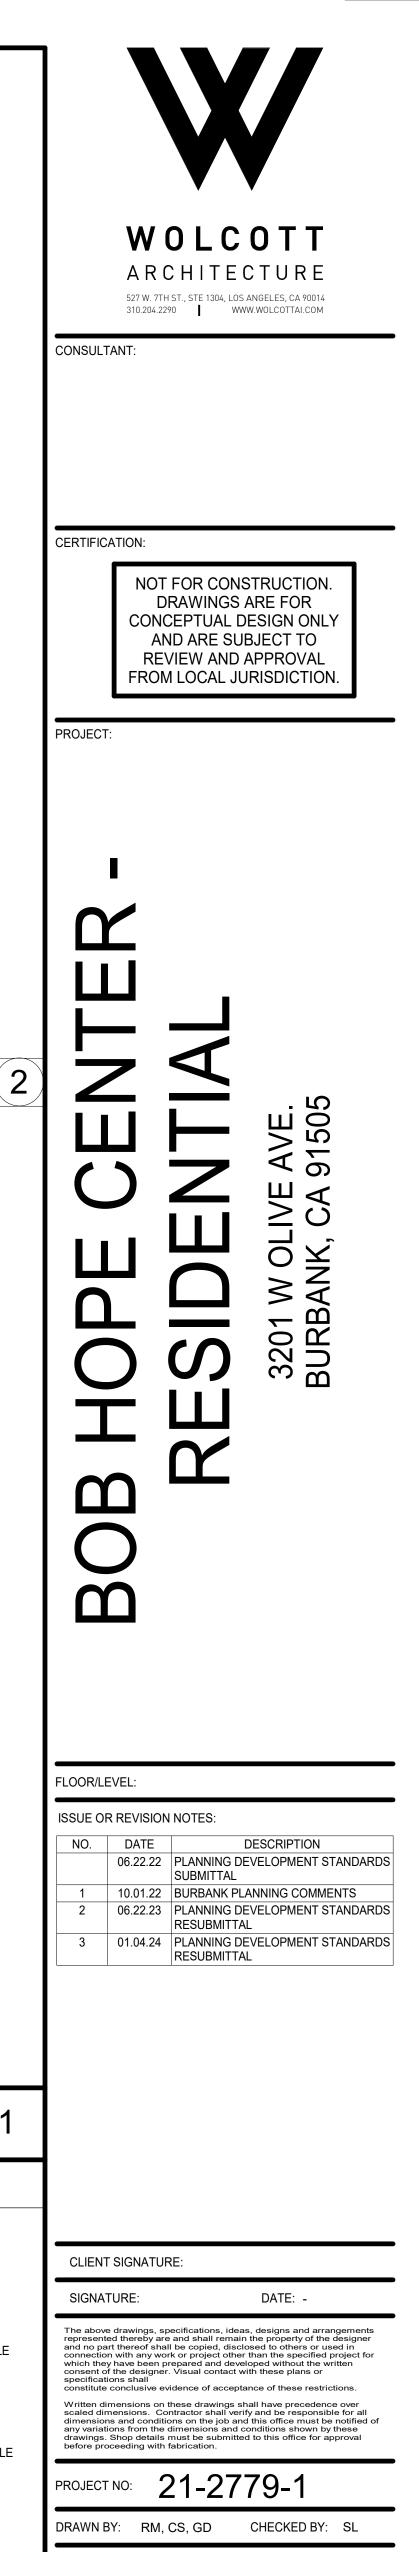

PROJECT MANAGER: CC DRAWING SCALE: 1/8" = 1'-0" SHEET SIZE: 30X42 DRAWING TITLE: ENLARGED EXTERIOR ELEVATIONS

A301

SHEET NO:





AME: Autodesk Docs://R22_BHC-Residential/21-2779-1 BobHopeCenter-144 Un 213MP: 1/0/2024 10:07:06 호M

	D	ST 1	E				G
6' - 0" SLD DR	9' - 9 1/2" 4 EQ PNL		15' - 7" 5 EQ PNL	15' - 5" 5 EQ PN		14' - 8 1/2" 4 EQ PNL	6' - 10" 2 EQ PNL
		* *	* * *	11 11 11	6. e.		
			* * * *	11 11 11	10' - 9 1/2"		
					1'-2 1/2"		
					12 1/2"		
	* *			11 II II	10' - 9 1/2"		
□EF3				<i>1</i>			
ROLL-UP SCREENING GA OADING PER 10-1-2107(E	/		- 6" 6' - 0" Q PNL SLD DR	8' - 2" 2 EQ PNL	/ /	5' - 0" 5' - 6" 8' - 2" LD DR 2 EQ PNL 2 EQ PNL	3' - 0" DOOR 5LD DR
18'- 11 1 7 EQ PN		6' - 0" SLD DR	18' - 0 1/2" 6 EQ PNL	/		6' - 0" D SLD DR 4 EQ PNL	MP 1 1 1
							9' - 9" 3 EQ PNL
	1/2" 9' - 6"		11 11 11	11 11			
11 11 11 11	10' - 9 1/2"		* * *	* *			
	9 1/2" 1' - 2						
11 11 11 11	- 10' -				77		

"	"	"	"	"	"		10'-91/2" 1'-21/2		+		*		*	**	**	*						"	"	"	"	•			N
		EF3		F3	•	-	EF3	EF		E	EF3	EF3			1			 			-				EF3		EF3		i
				((CN 1))							601) YP.													WD 1)	(


	KEYNOTES	
NOTES	2601 (N) EXTERIOR WALL MOUNTED LIGHTING BY SISTEMALUX OR EQUIV.	1. (N) EXTERIOR GLAZING
-	2001 (N) EXTENDIN WALL MOUNTED LIGHTING BT SISTEMALOX ON EQUIV.	2. (N) EXTERIOR WINDOW
DAVIS COLORS, DARK GREY (CARBON) 8084		3. (N) EXTERIOR DOOR SY
-		4. SÉE MATERIAL FINISH L
COLOR TO MATCH PT-1		5. NO MECHANICAL VENTI FEET FROM THE NEARE
COLOR TO MATCH PT-2		LOCATED ANYWHERE (
-		6. ALL PROJECT LIGHTING
PAINTED PT-1		LIGHT STANDARDS SHA PUBLIC RIGHT-OF-WAY
		7. ENERGY CONSERVATIO
		DESIGN AND OPERATIO
		8. BUILDING ELEVATIONS
		SHALL BE LIMITED TO A
		A RESIDENTIAL ZONE W
		PERCENT REFLECTIVIT
		GLAZING PRODUCTS: ARCADIA ACOUSTIC GLAZIN
		1/2", 1/4" INBOARD GLAZING

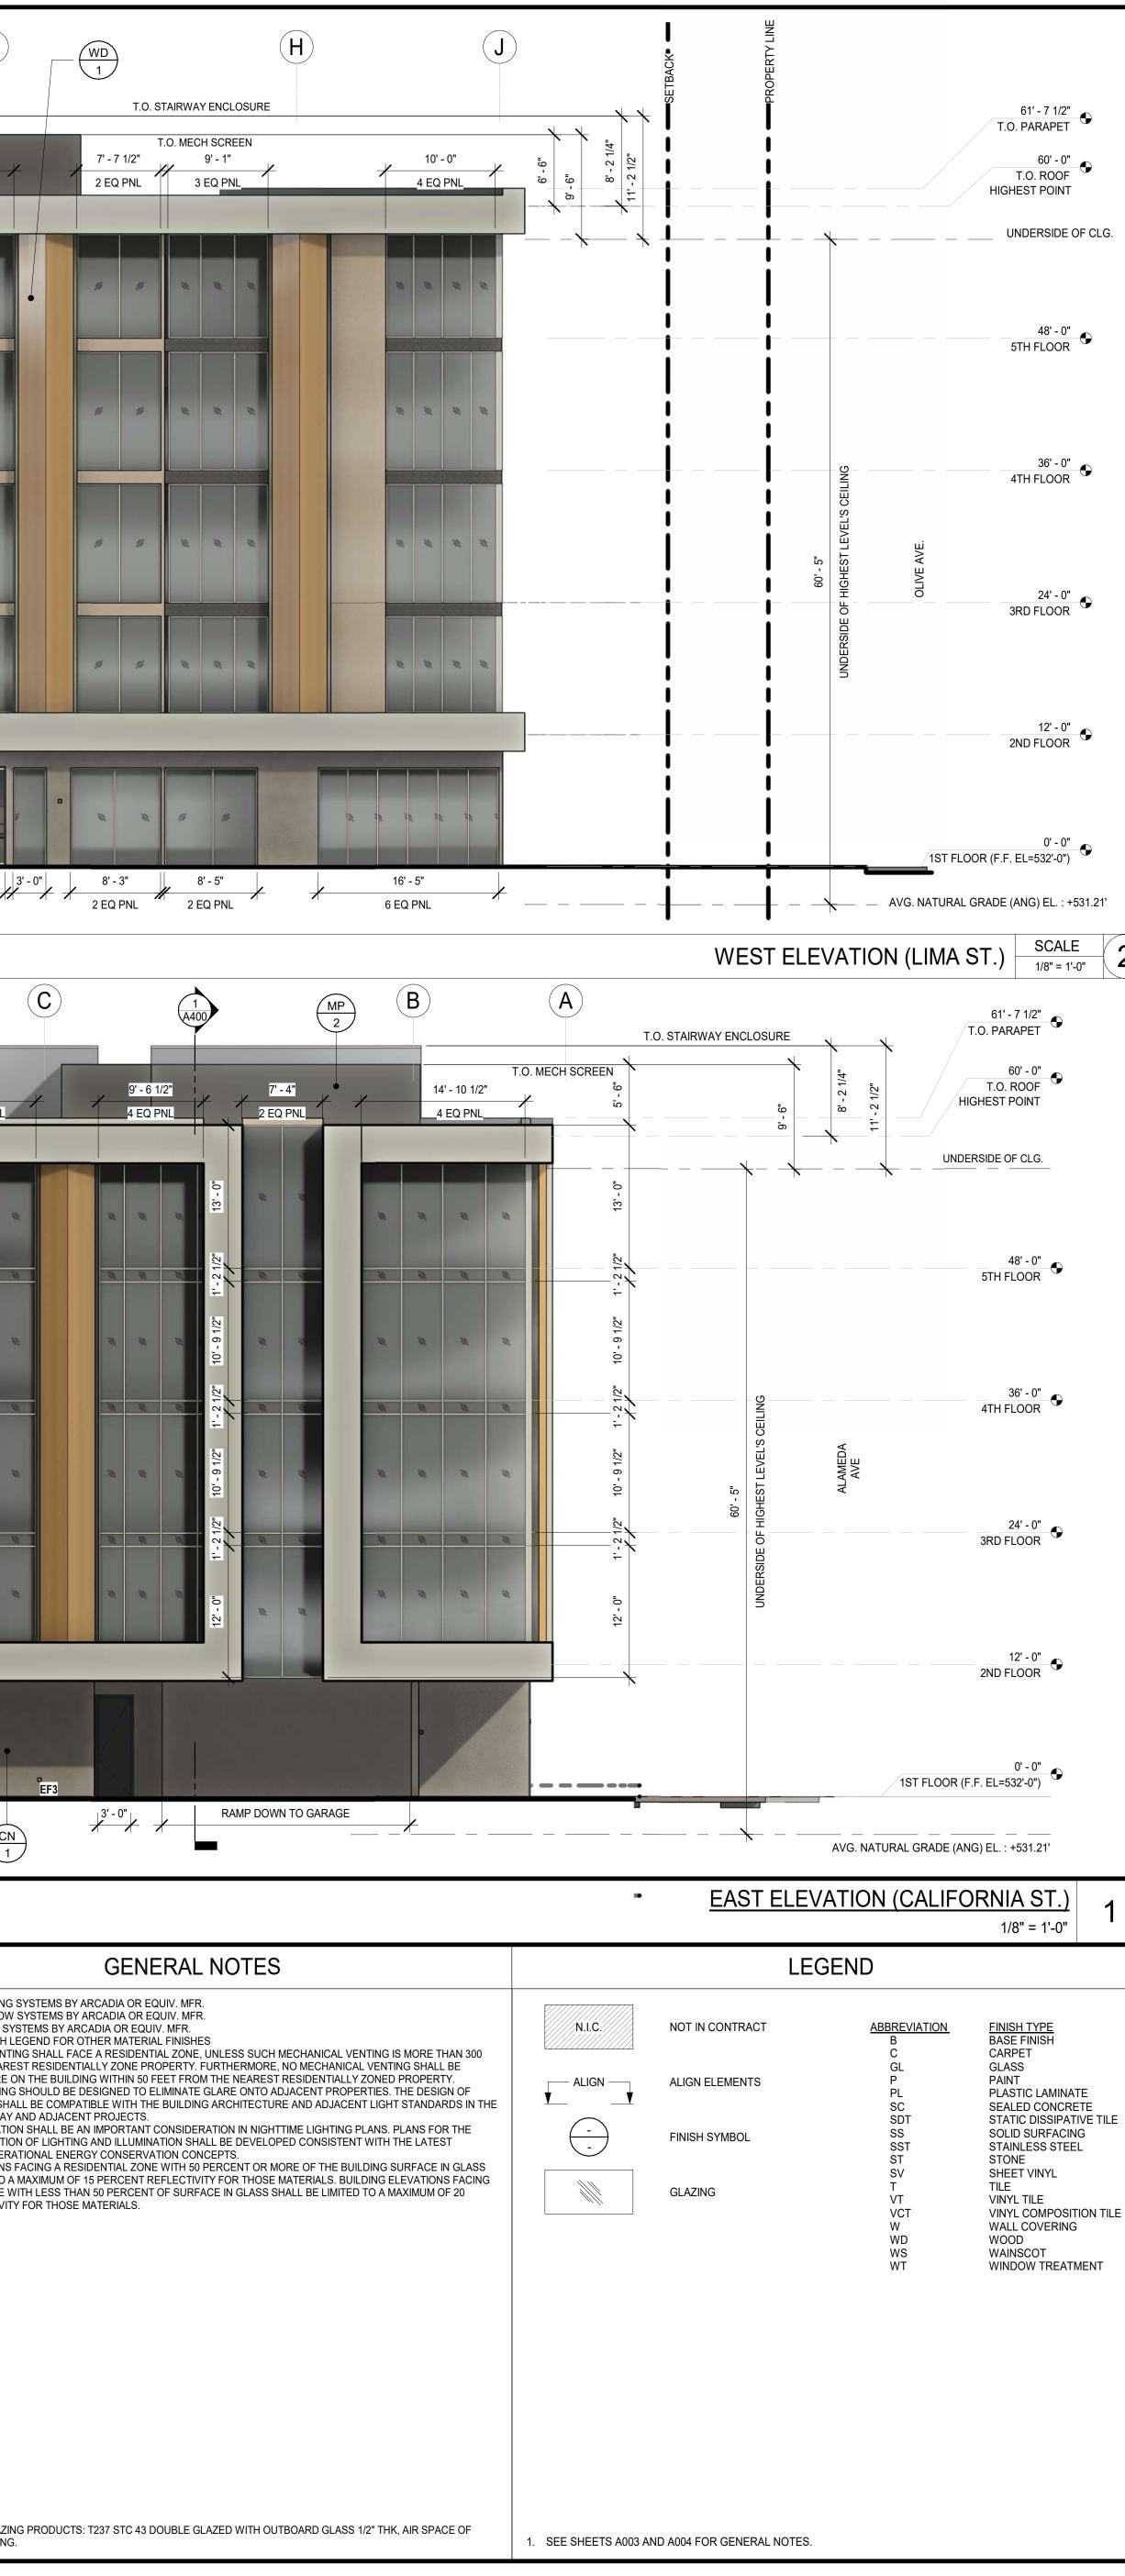

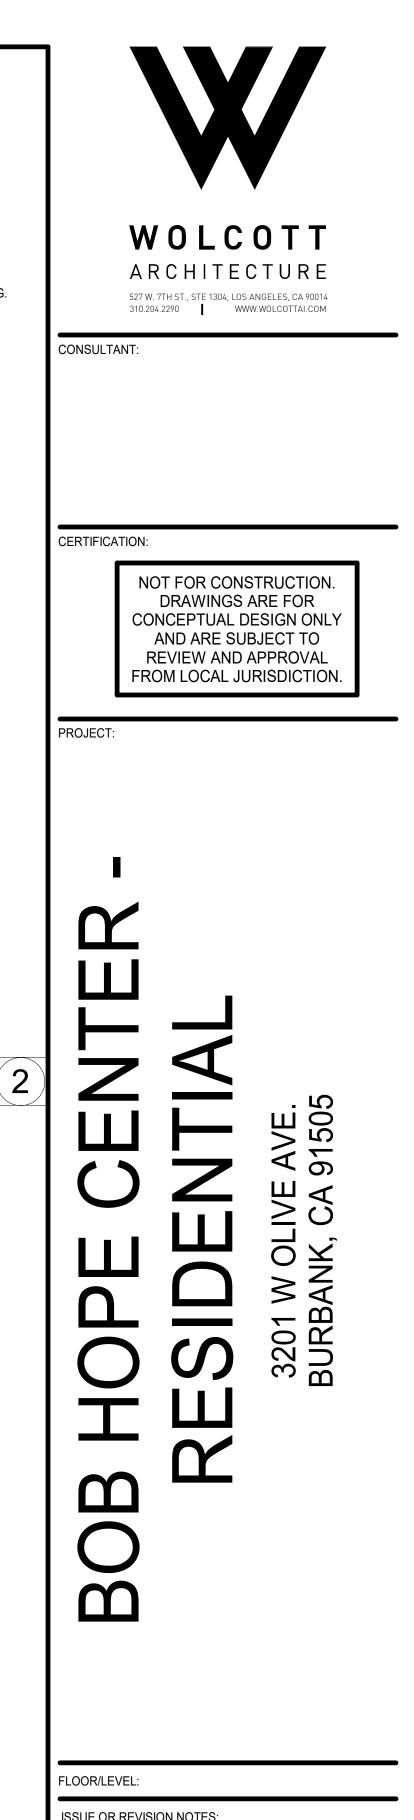

ISSUE OR REVISION NOTES.				
NO.	DATE	DESCRIPTION		
	06.22.22	PLANNING DEVELOPMENT STANDARDS SUBMITTAL		
1	10.01.22	BURBANK PLANNING COMMENTS		
2	06.22.23	PLANNING DEVELOPMENT STANDARDS RESUBMITTAL		
3	01.04.24	PLANNING DEVELOPMENT STANDARDS RESUBMITTAL		


CLIENT SIGNATURE:
SIGNATURE: DATE: -
The above drawings, specifications, ideas, designs and arrangements represented thereby are and shall remain the property of the designer and no part thereof shall be copied, disclosed to others or used in connection with any work or project other than the specified project for which they have been prepared and developed without the written consent of the designer. Visual contact with these plans or specifications shall constitute conclusive evidence of acceptance of these restrictions. Written dimensions on these drawings shall have precedence over scaled dimensions. Contractor shall verify and be responsible for all dimensions and conditions on the job and this office must be notified of any variations from the dimensions and conditions shown by these drawings. Shop details must be submitted to this office for approval before proceeding with fabrication.
PROJECT NO: 21-2779-1
DRAWN BY: RM, CS, GD CHECKED BY: SL
PROJECT MANAGER: CC
DRAWING SCALE: 1/8" = 1'-0"
SHEET SIZE: 30X42
DRAWING TITLE: ENLARGED EXTERIOR ELEVATIONS SHEET NO: A302

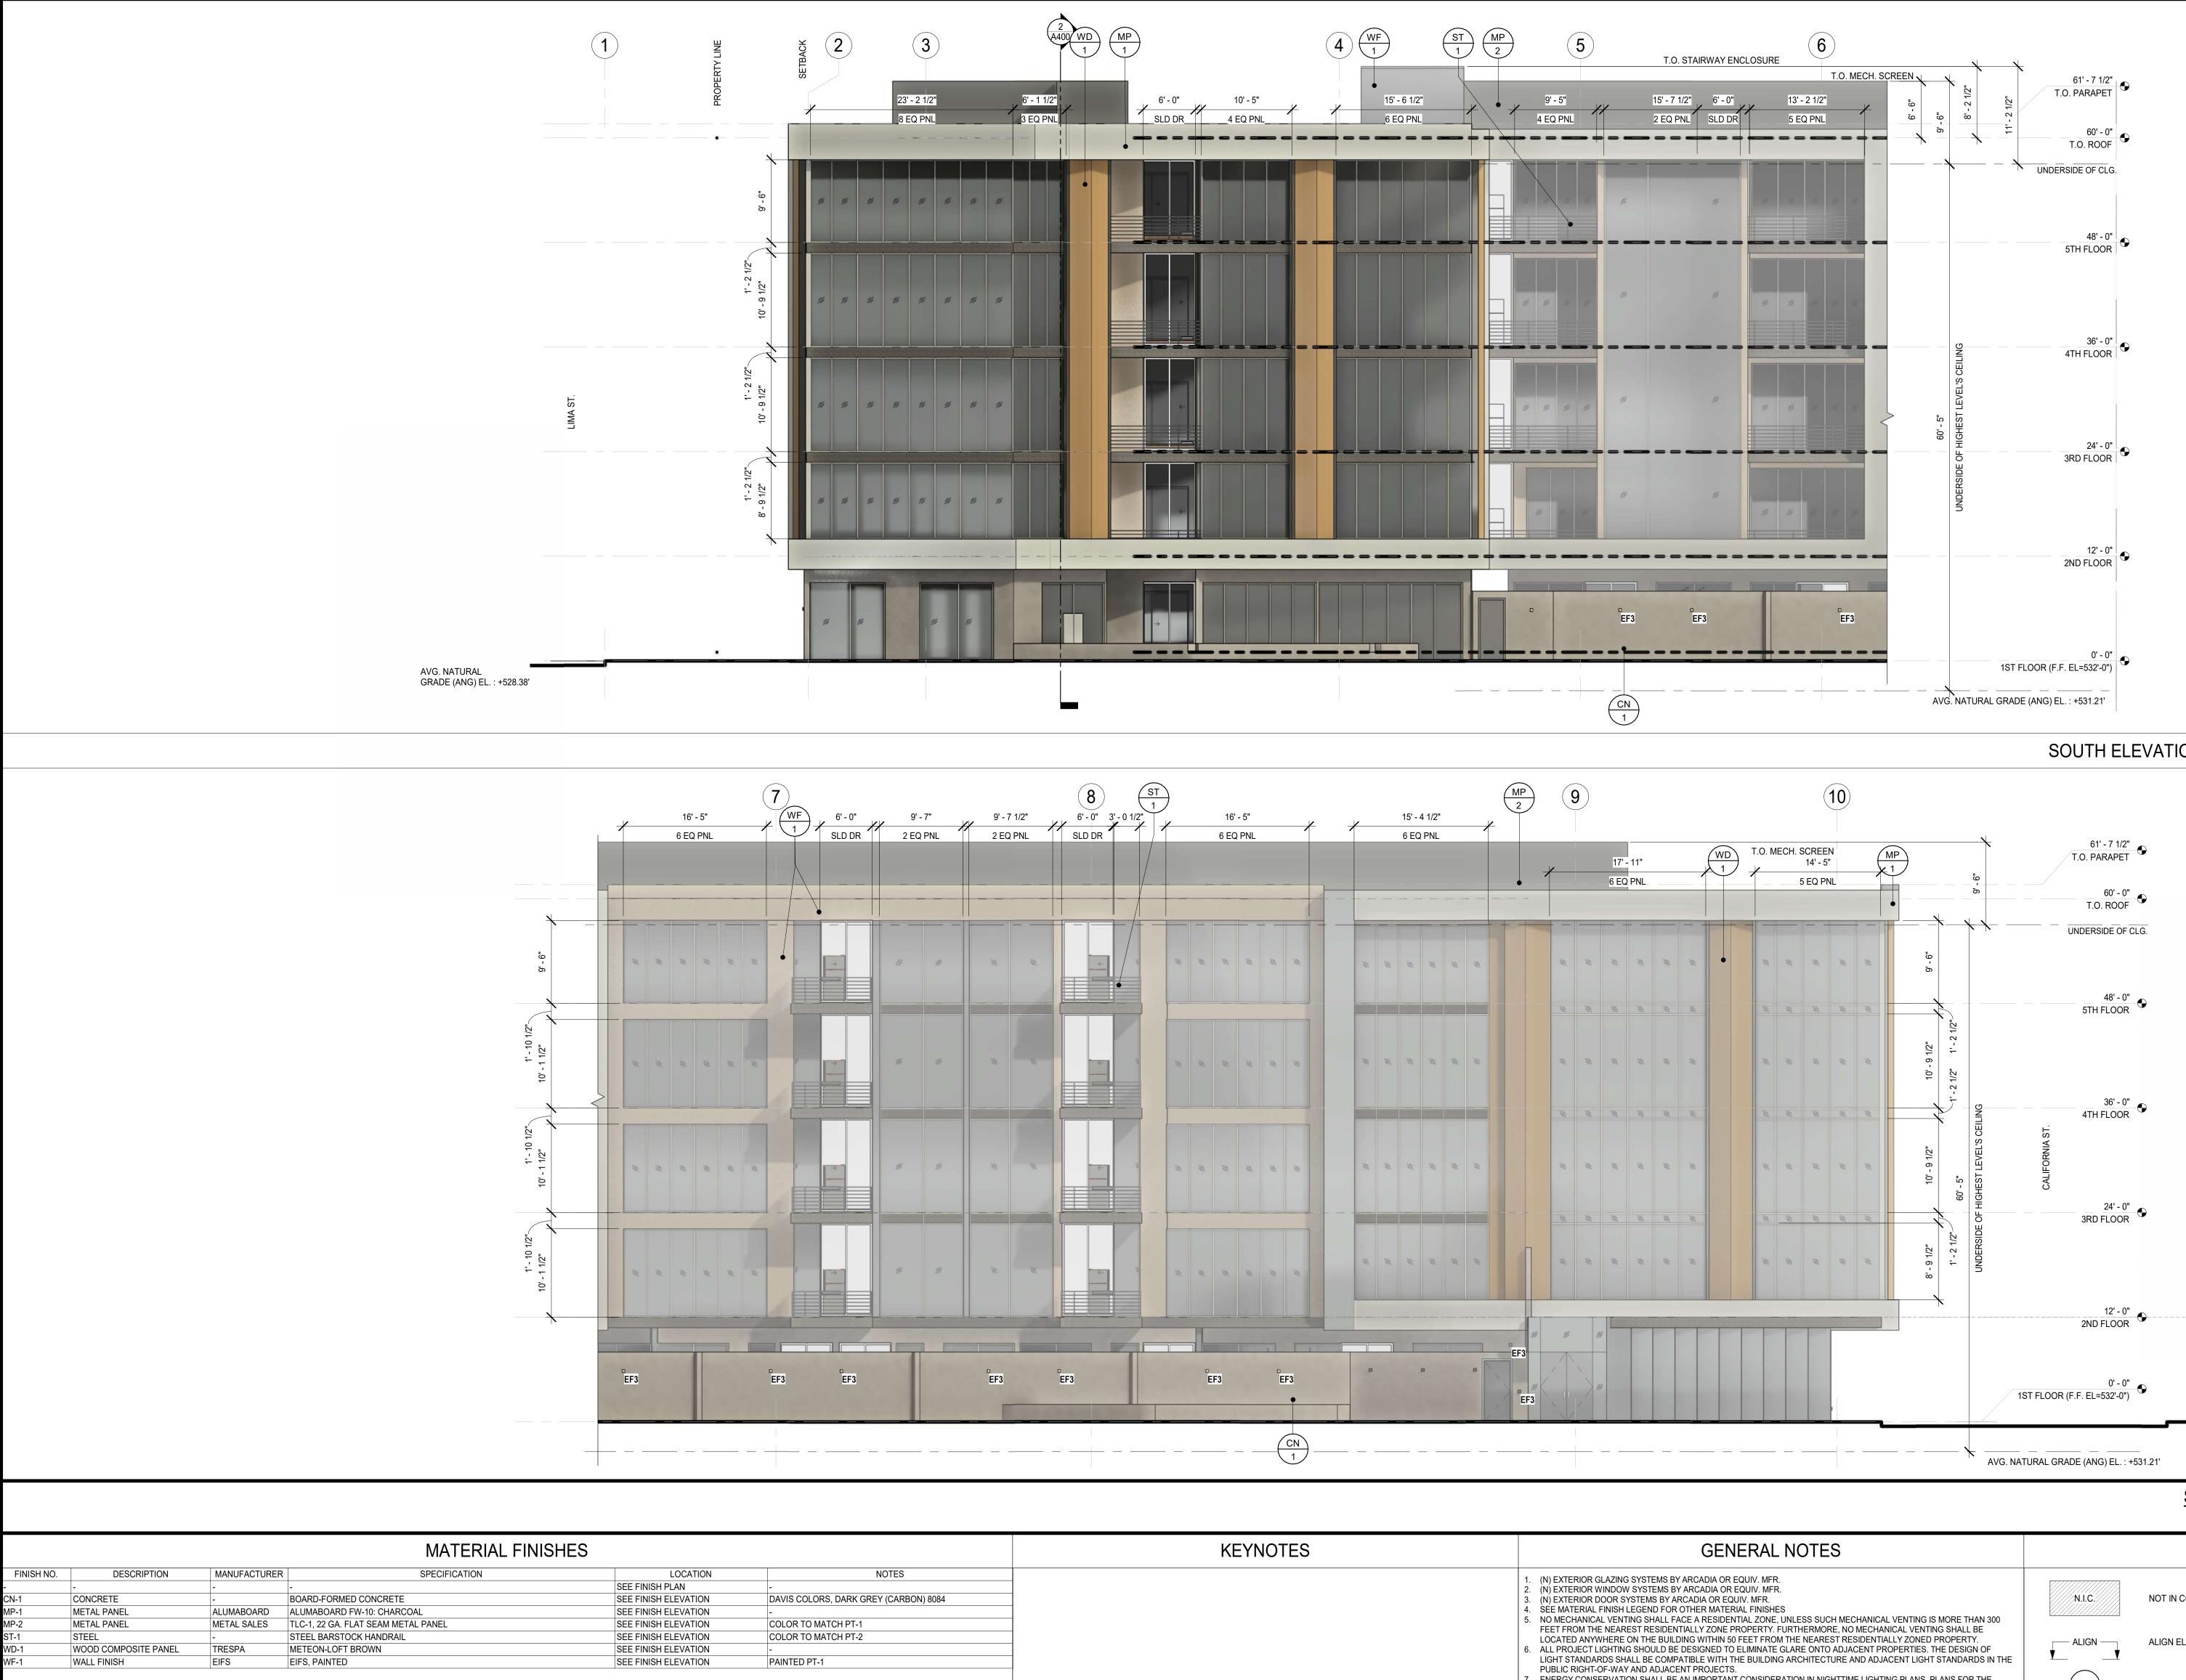

NAME: Autodesk Docs://R22_BHC-Residential/21-2779-1 BobHopeCenter-144 Units.r

	KEYNOTES	
NOTES		
-		 (N) EXTERIOR GLAZING (N) EXTERIOR WINDOW
DAVIS COLORS, DARK GREY (CARBON) 8084		(N) EXTERIOR DOOR SY
-		4. SEE MATERIAL FINISH L
COLOR TO MATCH PT-1		5. NO MECHANICAL VENTI FEET FROM THE NEARE
COLOR TO MATCH PT-2		LOCATED ANYWHERE (
-		6. ALL PROJECT LIGHTING
PAINTED PT-1		LIGHT STANDARDS SHA PUBLIC RIGHT-OF-WAY
		7. ENERGY CONSERVATIO
		DESIGN AND OPERATIO
		8. BUILDING ELEVATIONS SHALL BE LIMITED TO A
		A RESIDENTIAL ZONE W
		PERCENT REFLECTIVIT
		GLAZING PRODUCTS: ARCADIA ACOUSTIC GLAZIN
		1/2", 1/4" INBOARD GLAZING

SOUTH ELEVATION (W. OLIVE AVE.) - Callout 1

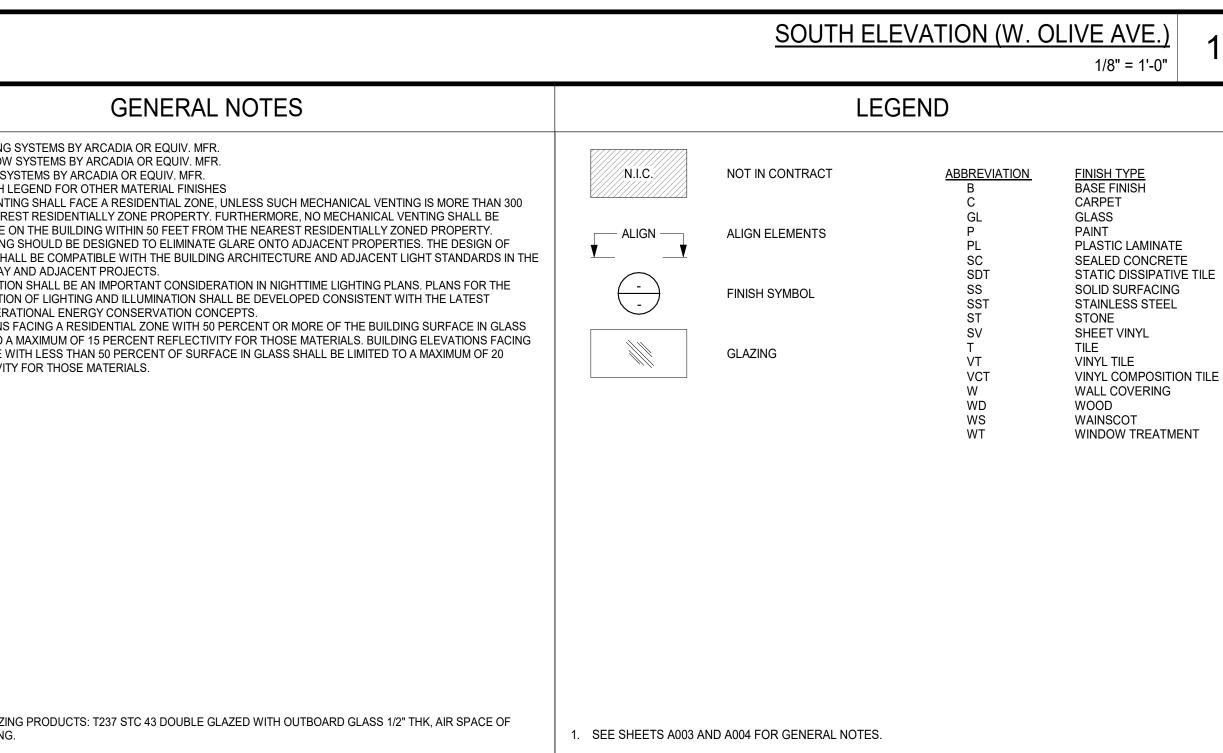




SCALE 1/8" = 1'-0"

> connection with any work or project other than the specified project for which they have been prepared and developed without the written consent of the designer. Visual contact with these plans or specifications shall constitute conclusive evidence of acceptance of these restrictions. Written dimensions on these drawings shall have precedence over scaled dimensions. Contractor shall verify and be responsible for all dimensions and conditions on the job and this office must be notified of any variations from the dimensions and conditions shown by these drawings. Shop details must be submitted to this office for approval before proceeding with fabrication.

> PROJECT NO: 21-2779-1 DRAWN BY: RM, CS, GD CHECKED BY: SL PROJECT MANAGER: CC DRAWING SCALE: 1/8" = 1'-0" SHEET SIZE: 30X42 DRAWING TITLE: ENLARGED EXTERIOR ELEVATIONS

> > A303


SHEET NO:

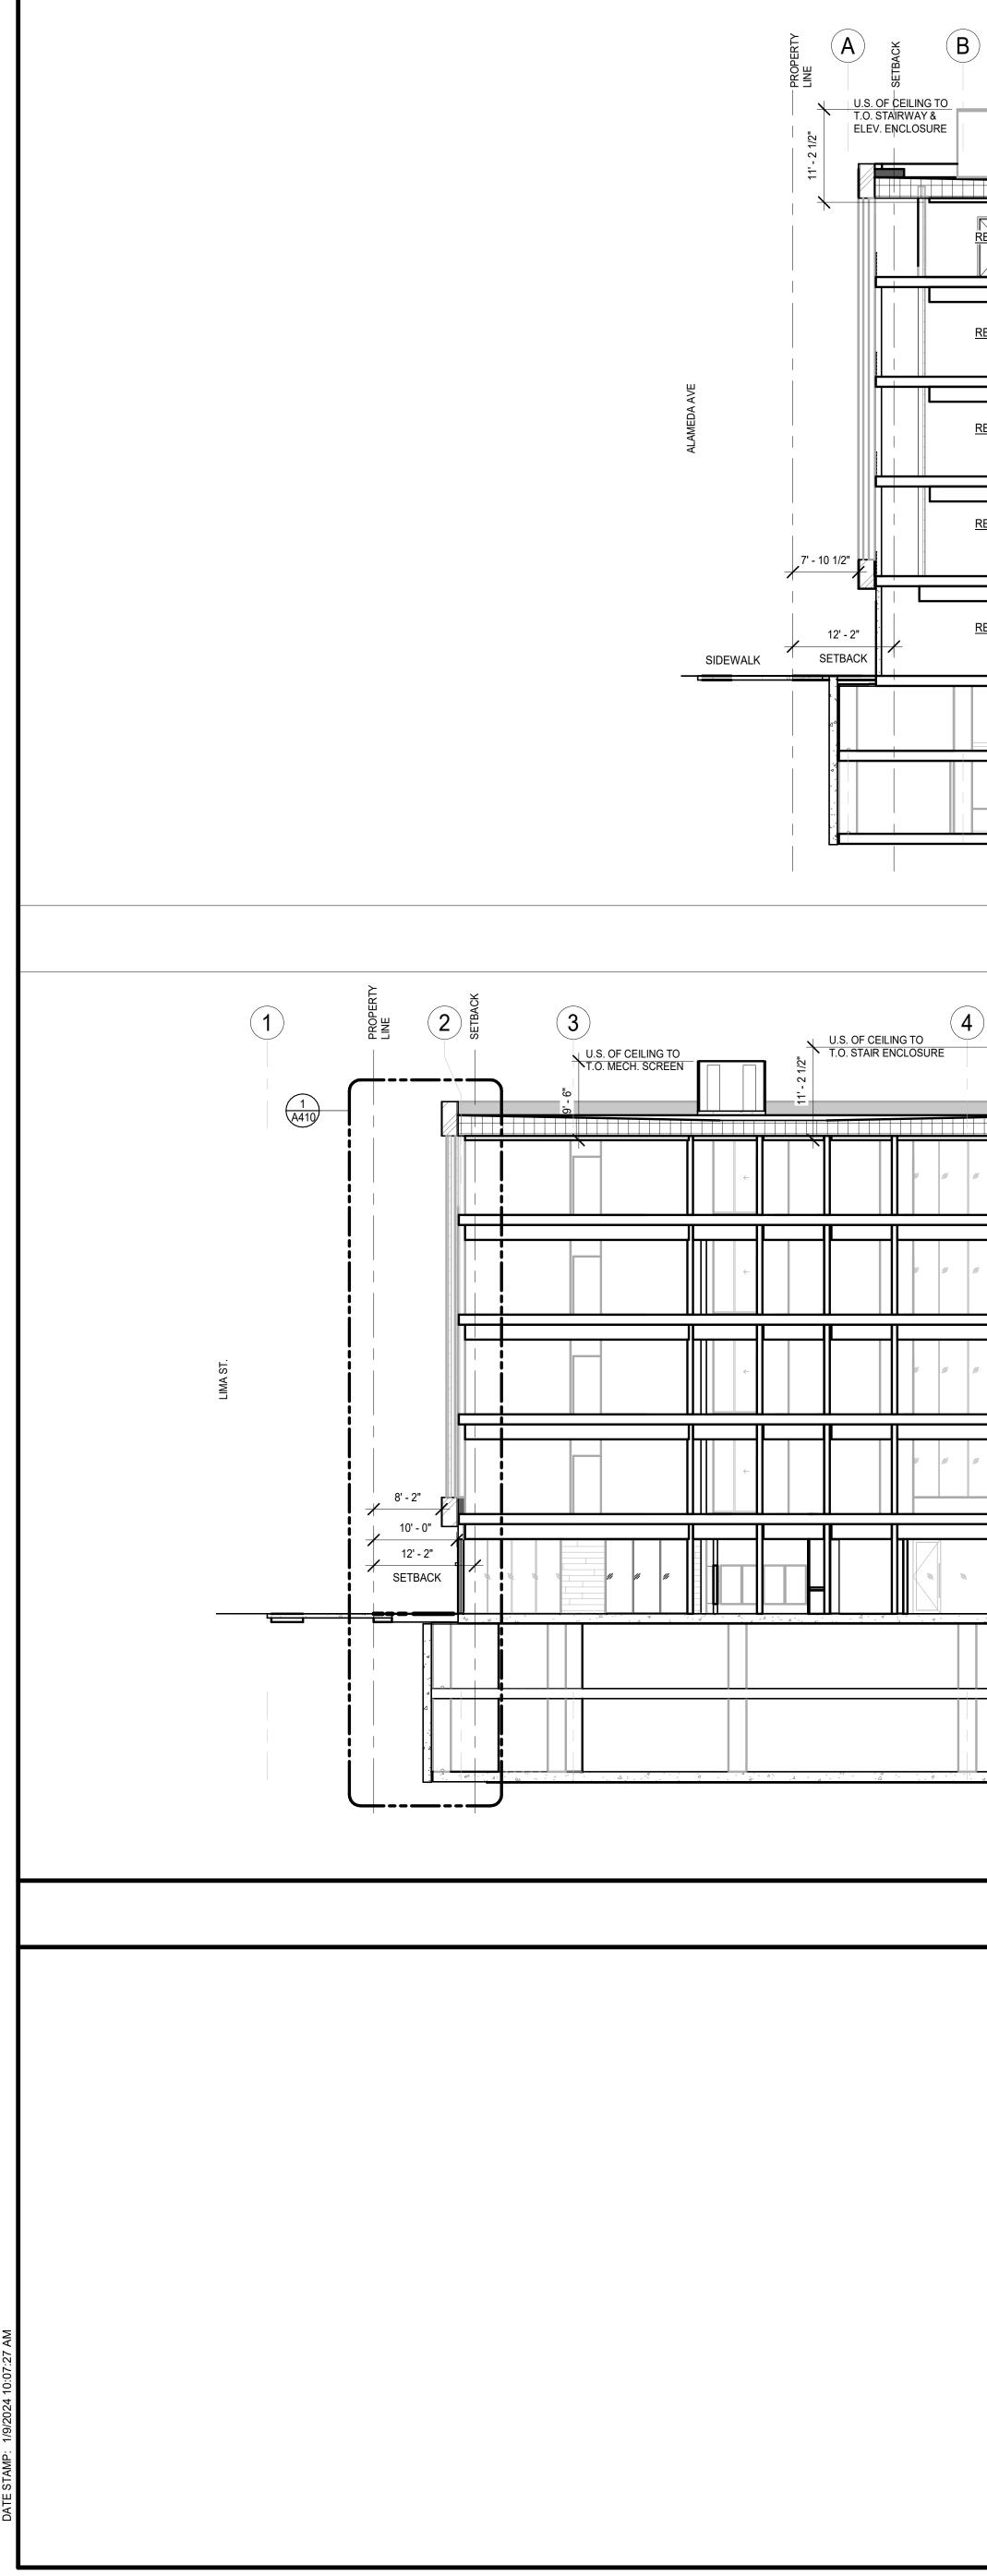

	C	D	E	F MECHANIC FINISH SPI MECHANIC MECHANIC	PEC MP-2
ESIDENTIAL FLOOR					
ESIDENTIAL FLOOR					
ESIDENTIAL FLOOR					
ESIDENTIAL FLOOR					
ESIDENTIAL FLOOR					
PARKING P-1					
PARKING P-2					

5 U.S. OF CEILING TO T.O. MECH. SCREEN	6 • •	7	U.S. OF CEILING TO T.O. MECH. SCREEN	8
		RKING P-1		

			<u>EAST-WEST SECTION</u> 3/32" = 1'-0"
	KEYNOTES	GENERAL NOTES	LEGEND
-		1. SEE SHEETS A003 AND A004 FOR GENERAL NOTES.	N.I.C. NOT IN CONTRACT
			ALIGN ALIGN ELEMENTS
			MATERIAL
			MATERIAL
			MATERIAL

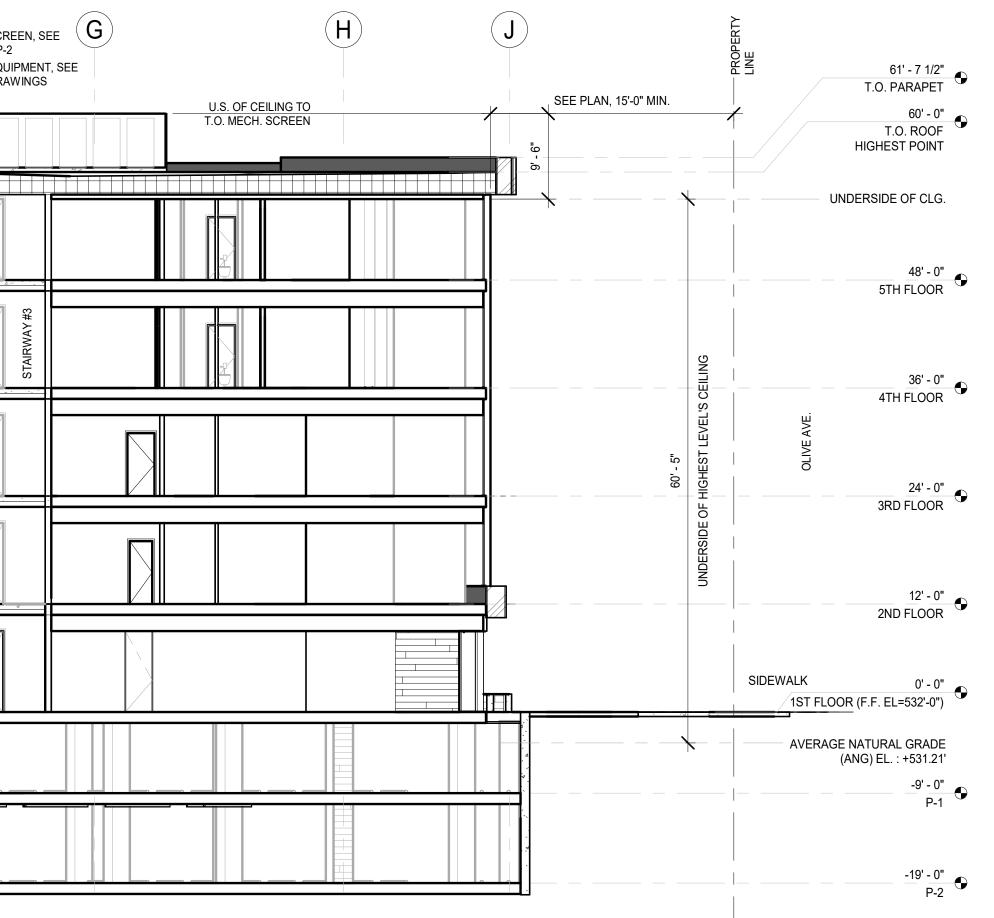

NORTH-SOUTH SECTION 3/32" = 1'-0"

10 9 MECHANICAL SCREEN, SEE FINISH SPEC MP-2 61' - 7 1/2" T.O. PARAPET MECHANICAL EQUIPMENT, SEE 60' - 0" T.O. ROOF HIGHEST POINT MECHANICAL DRAWINGS UNDERSIDE OF CLG. 48' - 0" 5TH FLOOR 36' - 0" 4TH FLOOR 24' - 0" 3RD FLOOR 12' - 0" 2ND FLOOR 0' - 0" 1ST FLOOR (F.F. EL=532'-0") AVERAGE NATURAL GRADE (ANG) EL. : +531.21' --9' - 0" P-1 -19'-0" P-2




which they have been prepared and developed without the written consent of the designer. Visual contact with these plans or specifications shall constitute conclusive evidence of acceptance of these restrictions. Written dimensions on these drawings shall have precedence over scaled dimensions. Contractor shall verify and be responsible for all dimensions and conditions on the job and this office must be notified of any variations from the dimensions and conditions shown by these drawings. Shop details must be submitted to this office for approval before proceeding with fabrication.


PROJECT NO: 21-2779-1 DRAWN BY: RM, CS, GD CHECKED BY: SL PROJECT MANAGER: CC DRAWING SCALE: As indicated SHEET SIZE: 30X42 DRAWING TITLE:

BUILDING SECTIONS

A400

SHEET NO:

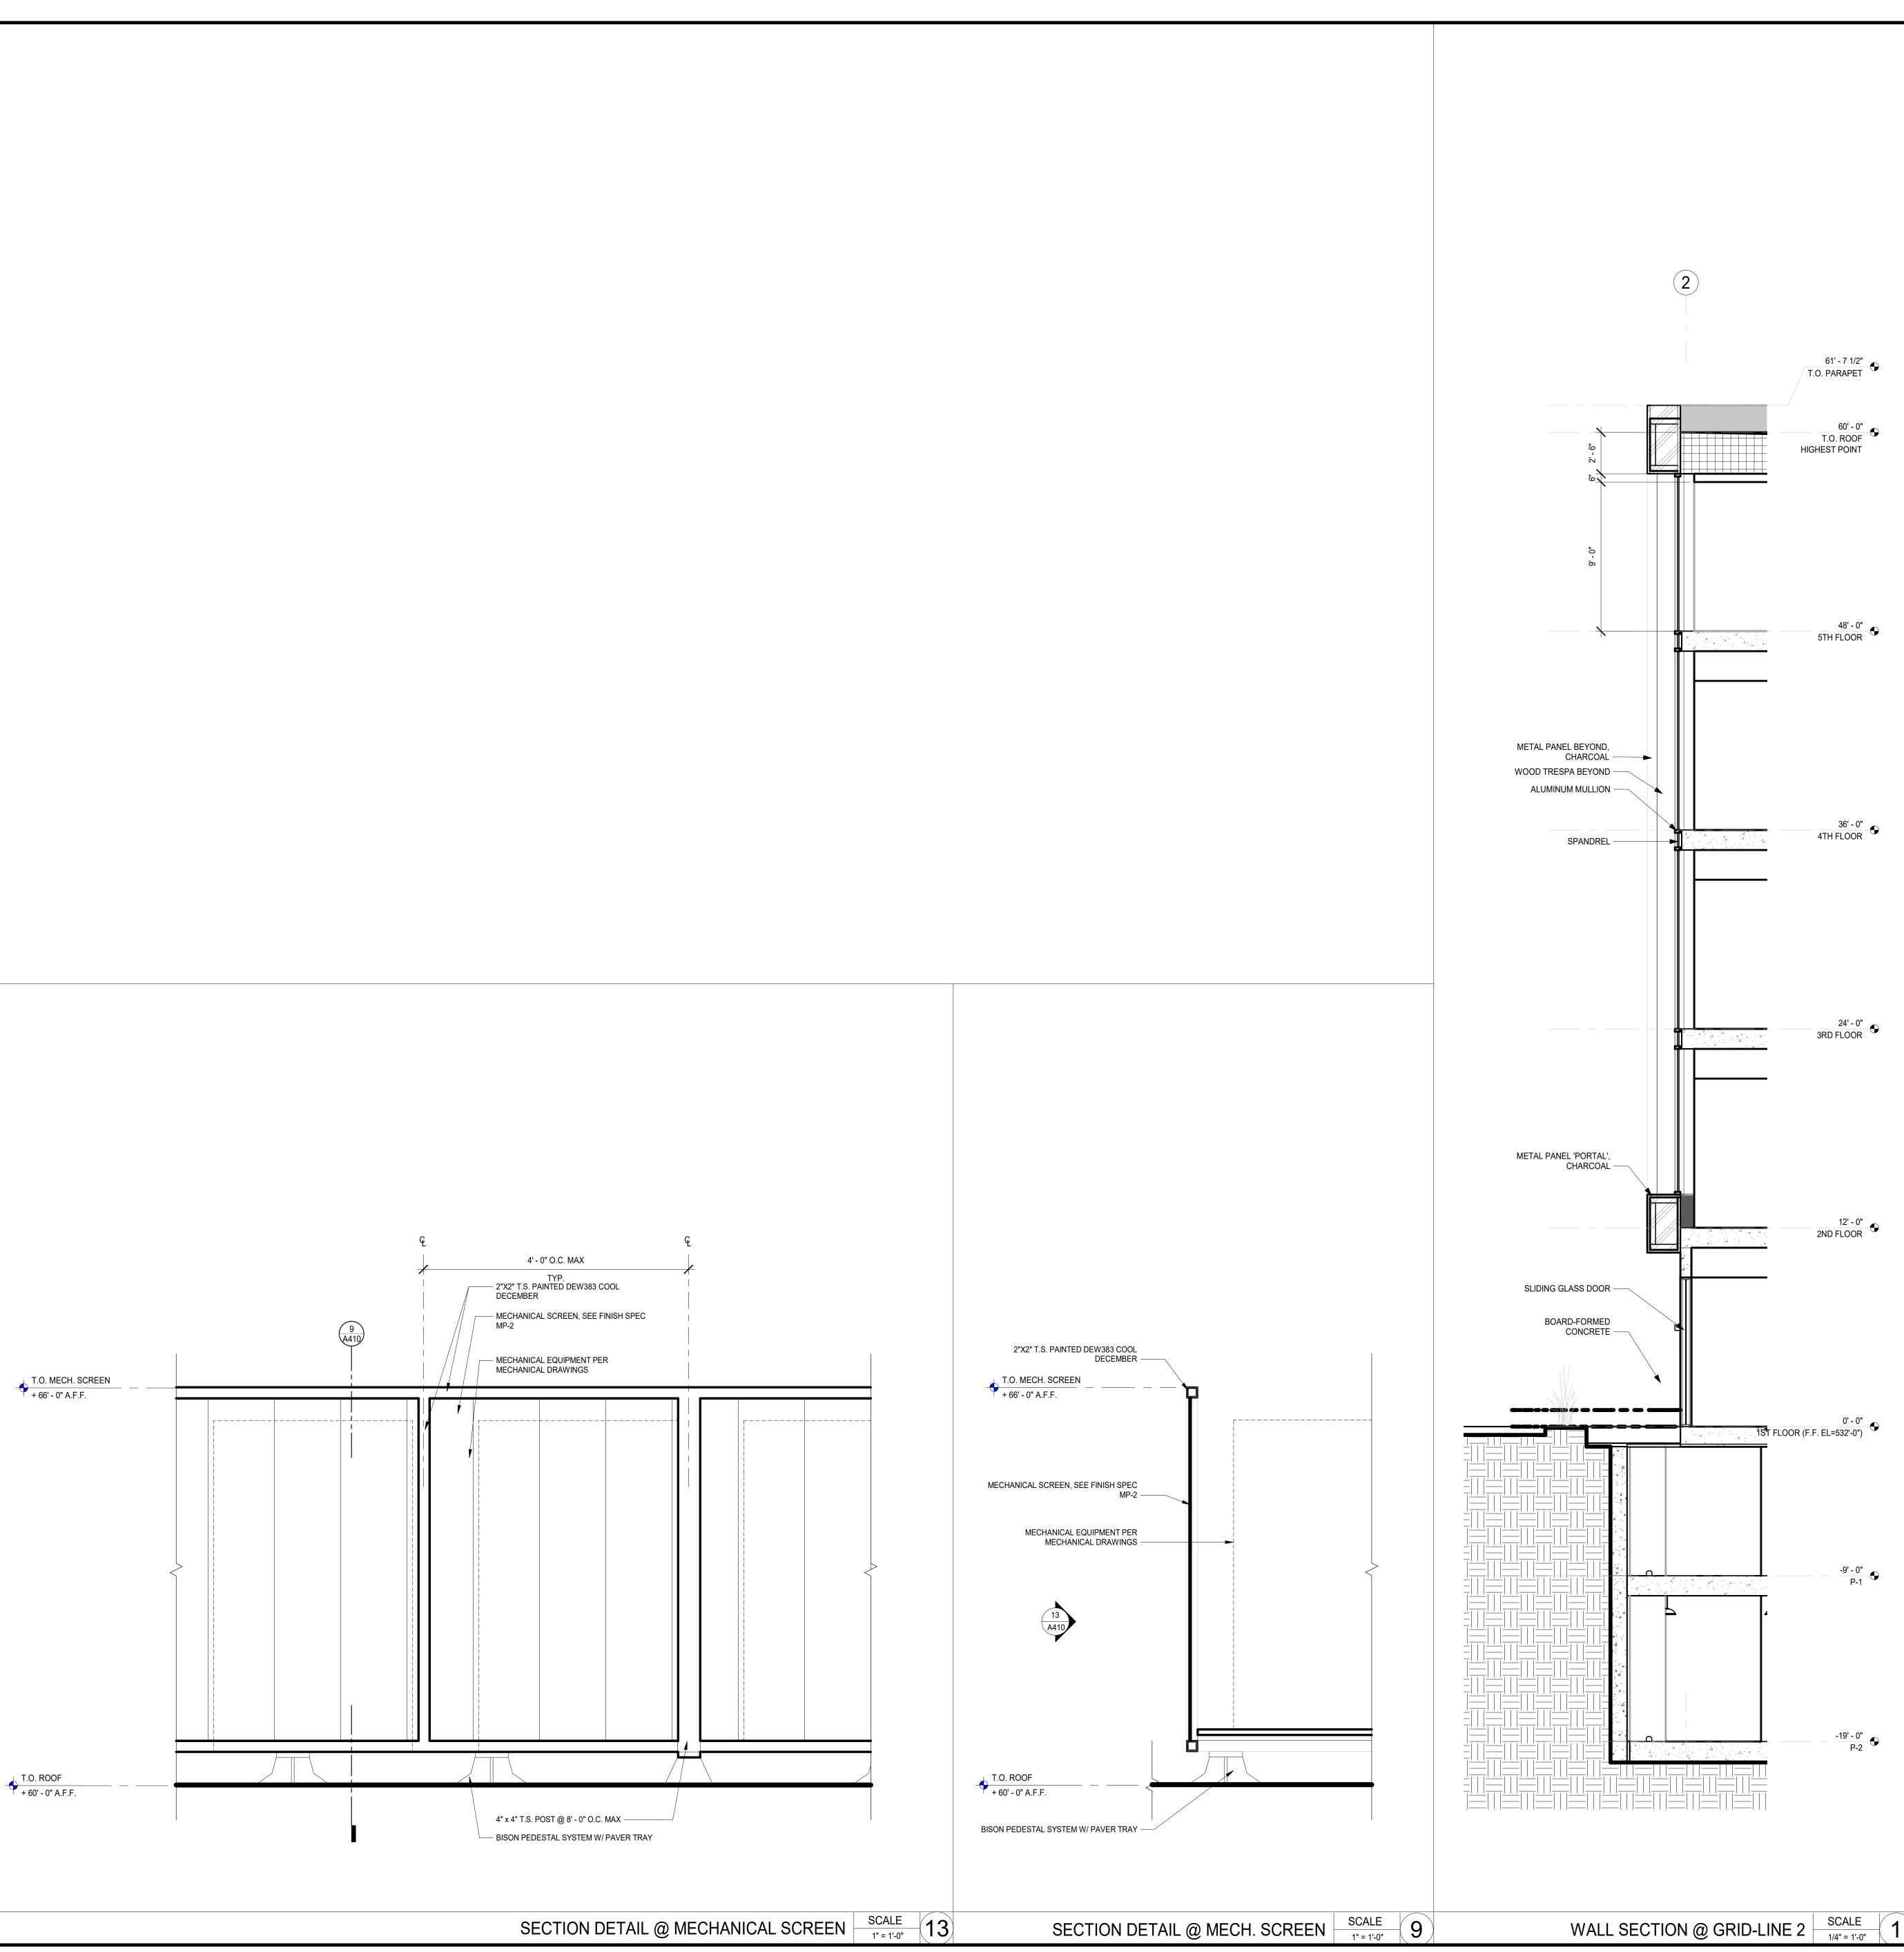

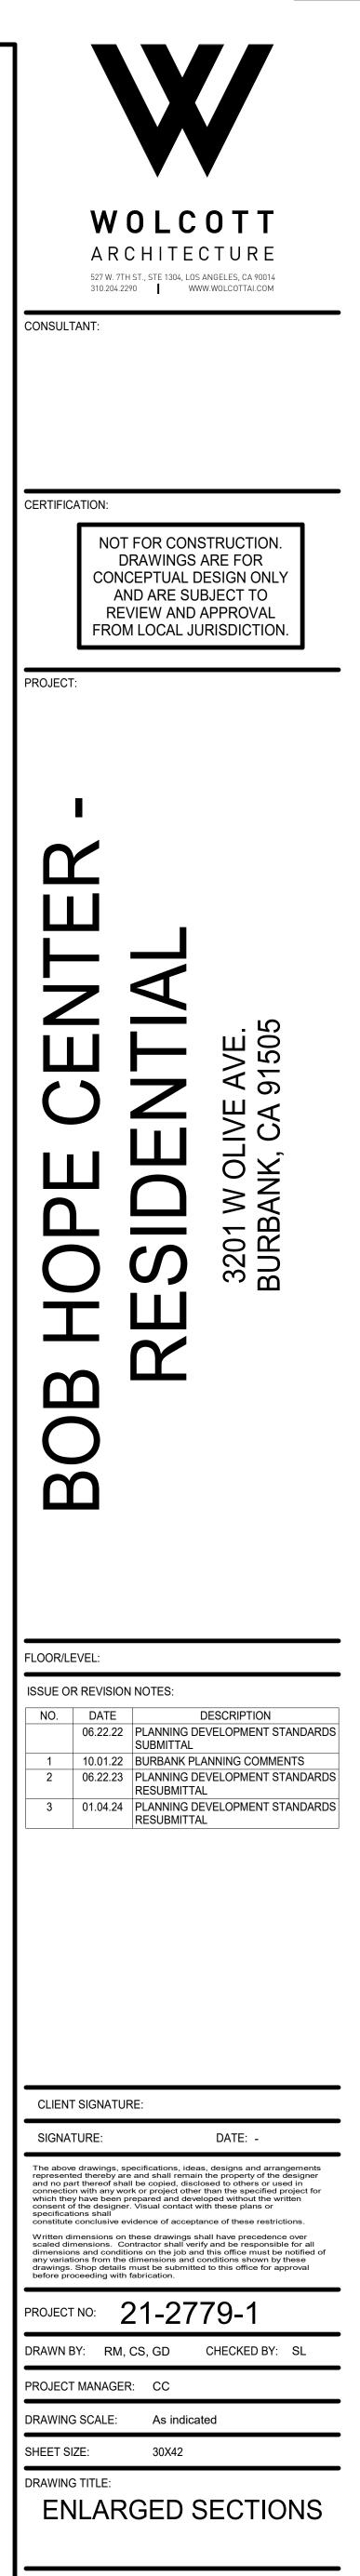

A410

NAME: Autodesk Docs://R22_BHC-Residential/21-2779-1 BobHopeCenter-144 Units.rvt





SHEET NO:

SHEET SIZE:


DRAWING TITLE:

A600


30X42


ENLARGED PLANS -

TYP. UNITS

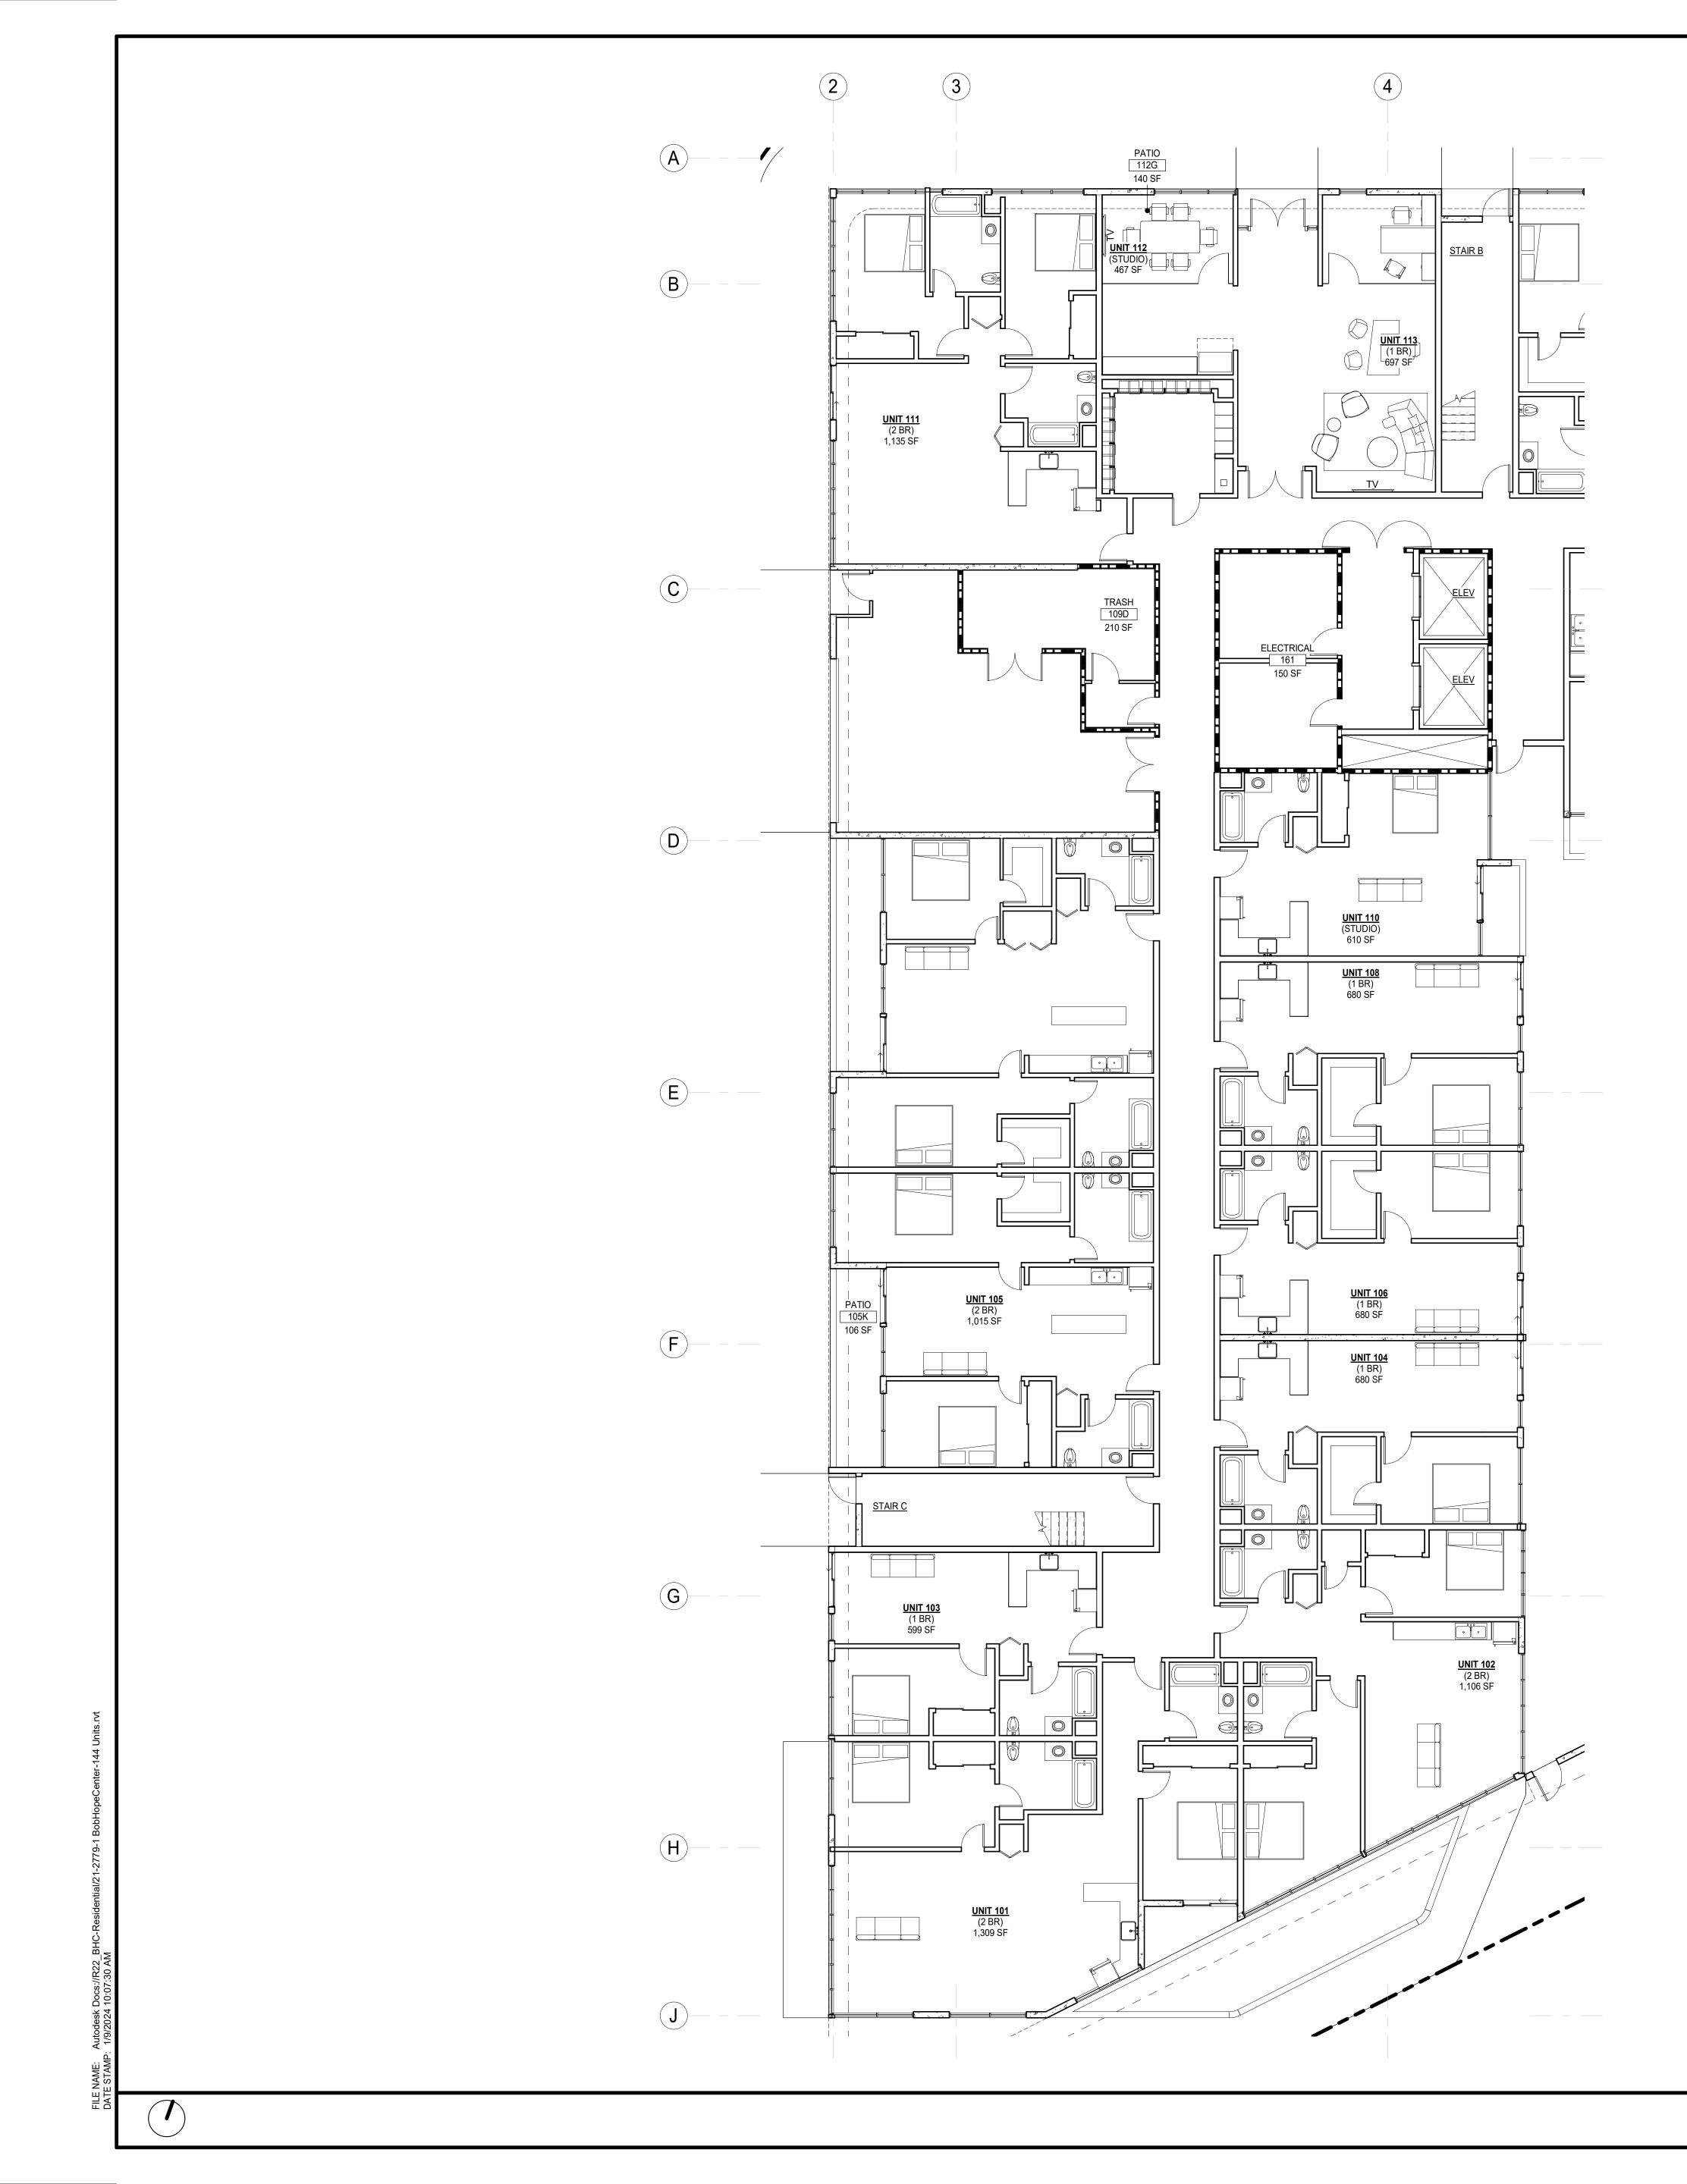



		KEYNO	TES	
		KEYPLAN A	AREA A	
			NOTES	
		GENERAL	NUTES	
	2. REFER TO SHEET A00	ID A004 FOR GENERAL NOTES. 01 FOR SYMBOLS AND ABBREVIATION		
	AUTHORITY. 4. IN NO CASE SHALL DI	MPLY WITH CURRENTLY ADOPTED IC	D BE SCALED FROM ANY	DRAWINGS. THE
	SUBSEQUENT WORK ARCHITECT'S ATTENT	. VERIFY ALL CONDITIONS AND DIMEN . CONTRACTOR SHALL BRING ANY DIS FION PRIOR TO PROCEEDING WITH AI	SCREPANCIES OR CLARII NY RELATED WORK.	FICATIONS TO THE
		E TO FACE STUD U.O.N. FINISH FLOOF CRETE UNDERLAYMENT U.O.N. CEILII		
	MATERIALS ARE INST	D "MIN." INDICATE A MINIMUM CLEARA "ALLED. ERS SHALL BE SO ARRANGED AND SP		
	CONDUITS AND DUCT STIFFENERS, BRACES	WORK WITH A MINIMUM OF CUTTING S, BACK-UP PLATES AND SUPPORTING OR SUSPENDED MECHANICAL AND E	5. CONTRACTOR SHALL P G BRACKETS AS REQUIR	ROVIDE AND INSTALL ALL ED FOR THE INSTALLATION OF
	ACCESSORIES, GRAE 8. ALL WOOD FRAMING		ARDANT TREATED WOOI	D COMPLYING WITH CBC
	SHEATHING, SILL PLA 9. ADJUST FRAMING CC	TES, TOP PLATES, ETC. INFIGURATION AT ALL FAN COIL UNIT	S WITHIN FLOOR/ CEILING	GASSEMBLY AS REQUIRED TO
	INFORMATION. 10. ALL WOOD FRAMING	D ASSEMBLY. REFER TO MECHANICA	BE PRESSURE TREATED.	
	12. ALL GYPSUM BOARD 13. REFER TO SHEET A80		SANDED, AND PRIMED TO	O LEVEL 4 FINISH U.O.N.
	15. REFER TO SHEET A7 SCHEDULES.	00 FOR DOOR SCHEDULE AND DETAIL 10 FOR FINISH, LIGHT FIXTURE, APPLI	ANCE, EQUIPMENT, AND	PLUMBING FIXTURE
	CARPORTS, GARAGE	SHIELDED TO ELIMINATE GLARE ONT S, PARKING AREAS, AND DRIVEWAYS ′ PER BMC 10-1-2017 (G)(2)		
		G TO STANDARDS PRESCRIBED BY TH NG LOTS USED FOR PUBLIC PARKING		
		IE BURBANK 2035 GENERAL PLAN THI OISE LEVELS US 45DBA MAX. PER TAI		
	TRANSPORTATION SC 20. THIS PROJECT WILL E	OURCES OF THE GENERAL PLAN. BE CONSTRUCTED INCORPORATING E ERGY, WATER, AND OTHER NATURAL	BUILDING DESIGN FEATU	RES THAT MINIMIZE THE
	AND ENERGY CODES			
		LEGEI	ND	
	N.1.C.	NOT IN CONTRACT	ALIGN —	ALIGN ELEMENTS
		EXISTING MILLWORK	RM NAME	ROOM NAME AND NUMBER
			#	ROOM NAME AND NOMBER
		NEW MILLWORK	F.E.C.	FIRE EXTINGUISHER CABINET
		EXISTING PARTITION		NEW PLUMBING FIXTURES
		EXISTING DOOR		
	C# -	— WALL TAG. REFER TO A800		
		NEW PARTITION PER PLAN		
	4" TYP.			
		NEW DOOR		
	< <u>1001</u> >	DOOR NUMBER. REFER TO A700		
		- WINDOW TAG. REFER TO A700 NEW GLAZING OR STOREFRONT		
		SYSTEM PER SCHEDULE.		
AREA A	$\langle \mathbf{A} \rangle$	NEW PLUMBING FIXTURE, APPLIANCE, OR EQUIPMENT. REFER TO A710		
1/8" = 1'-0"				

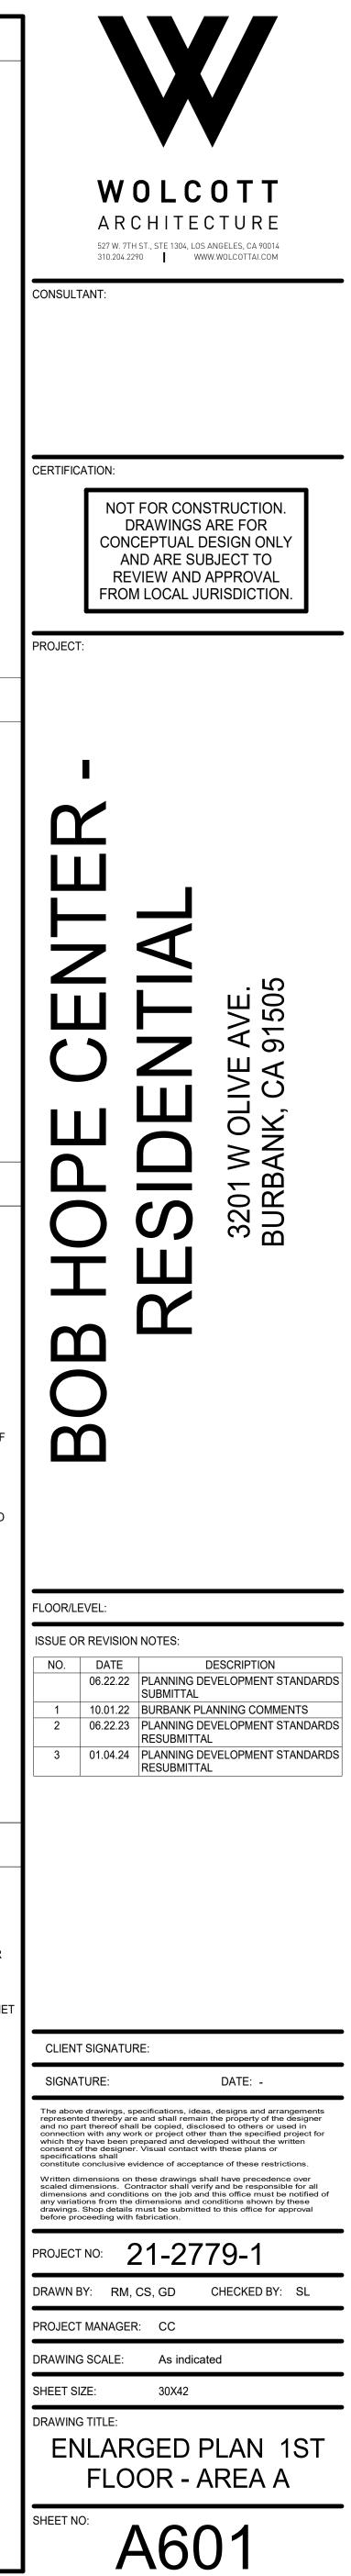

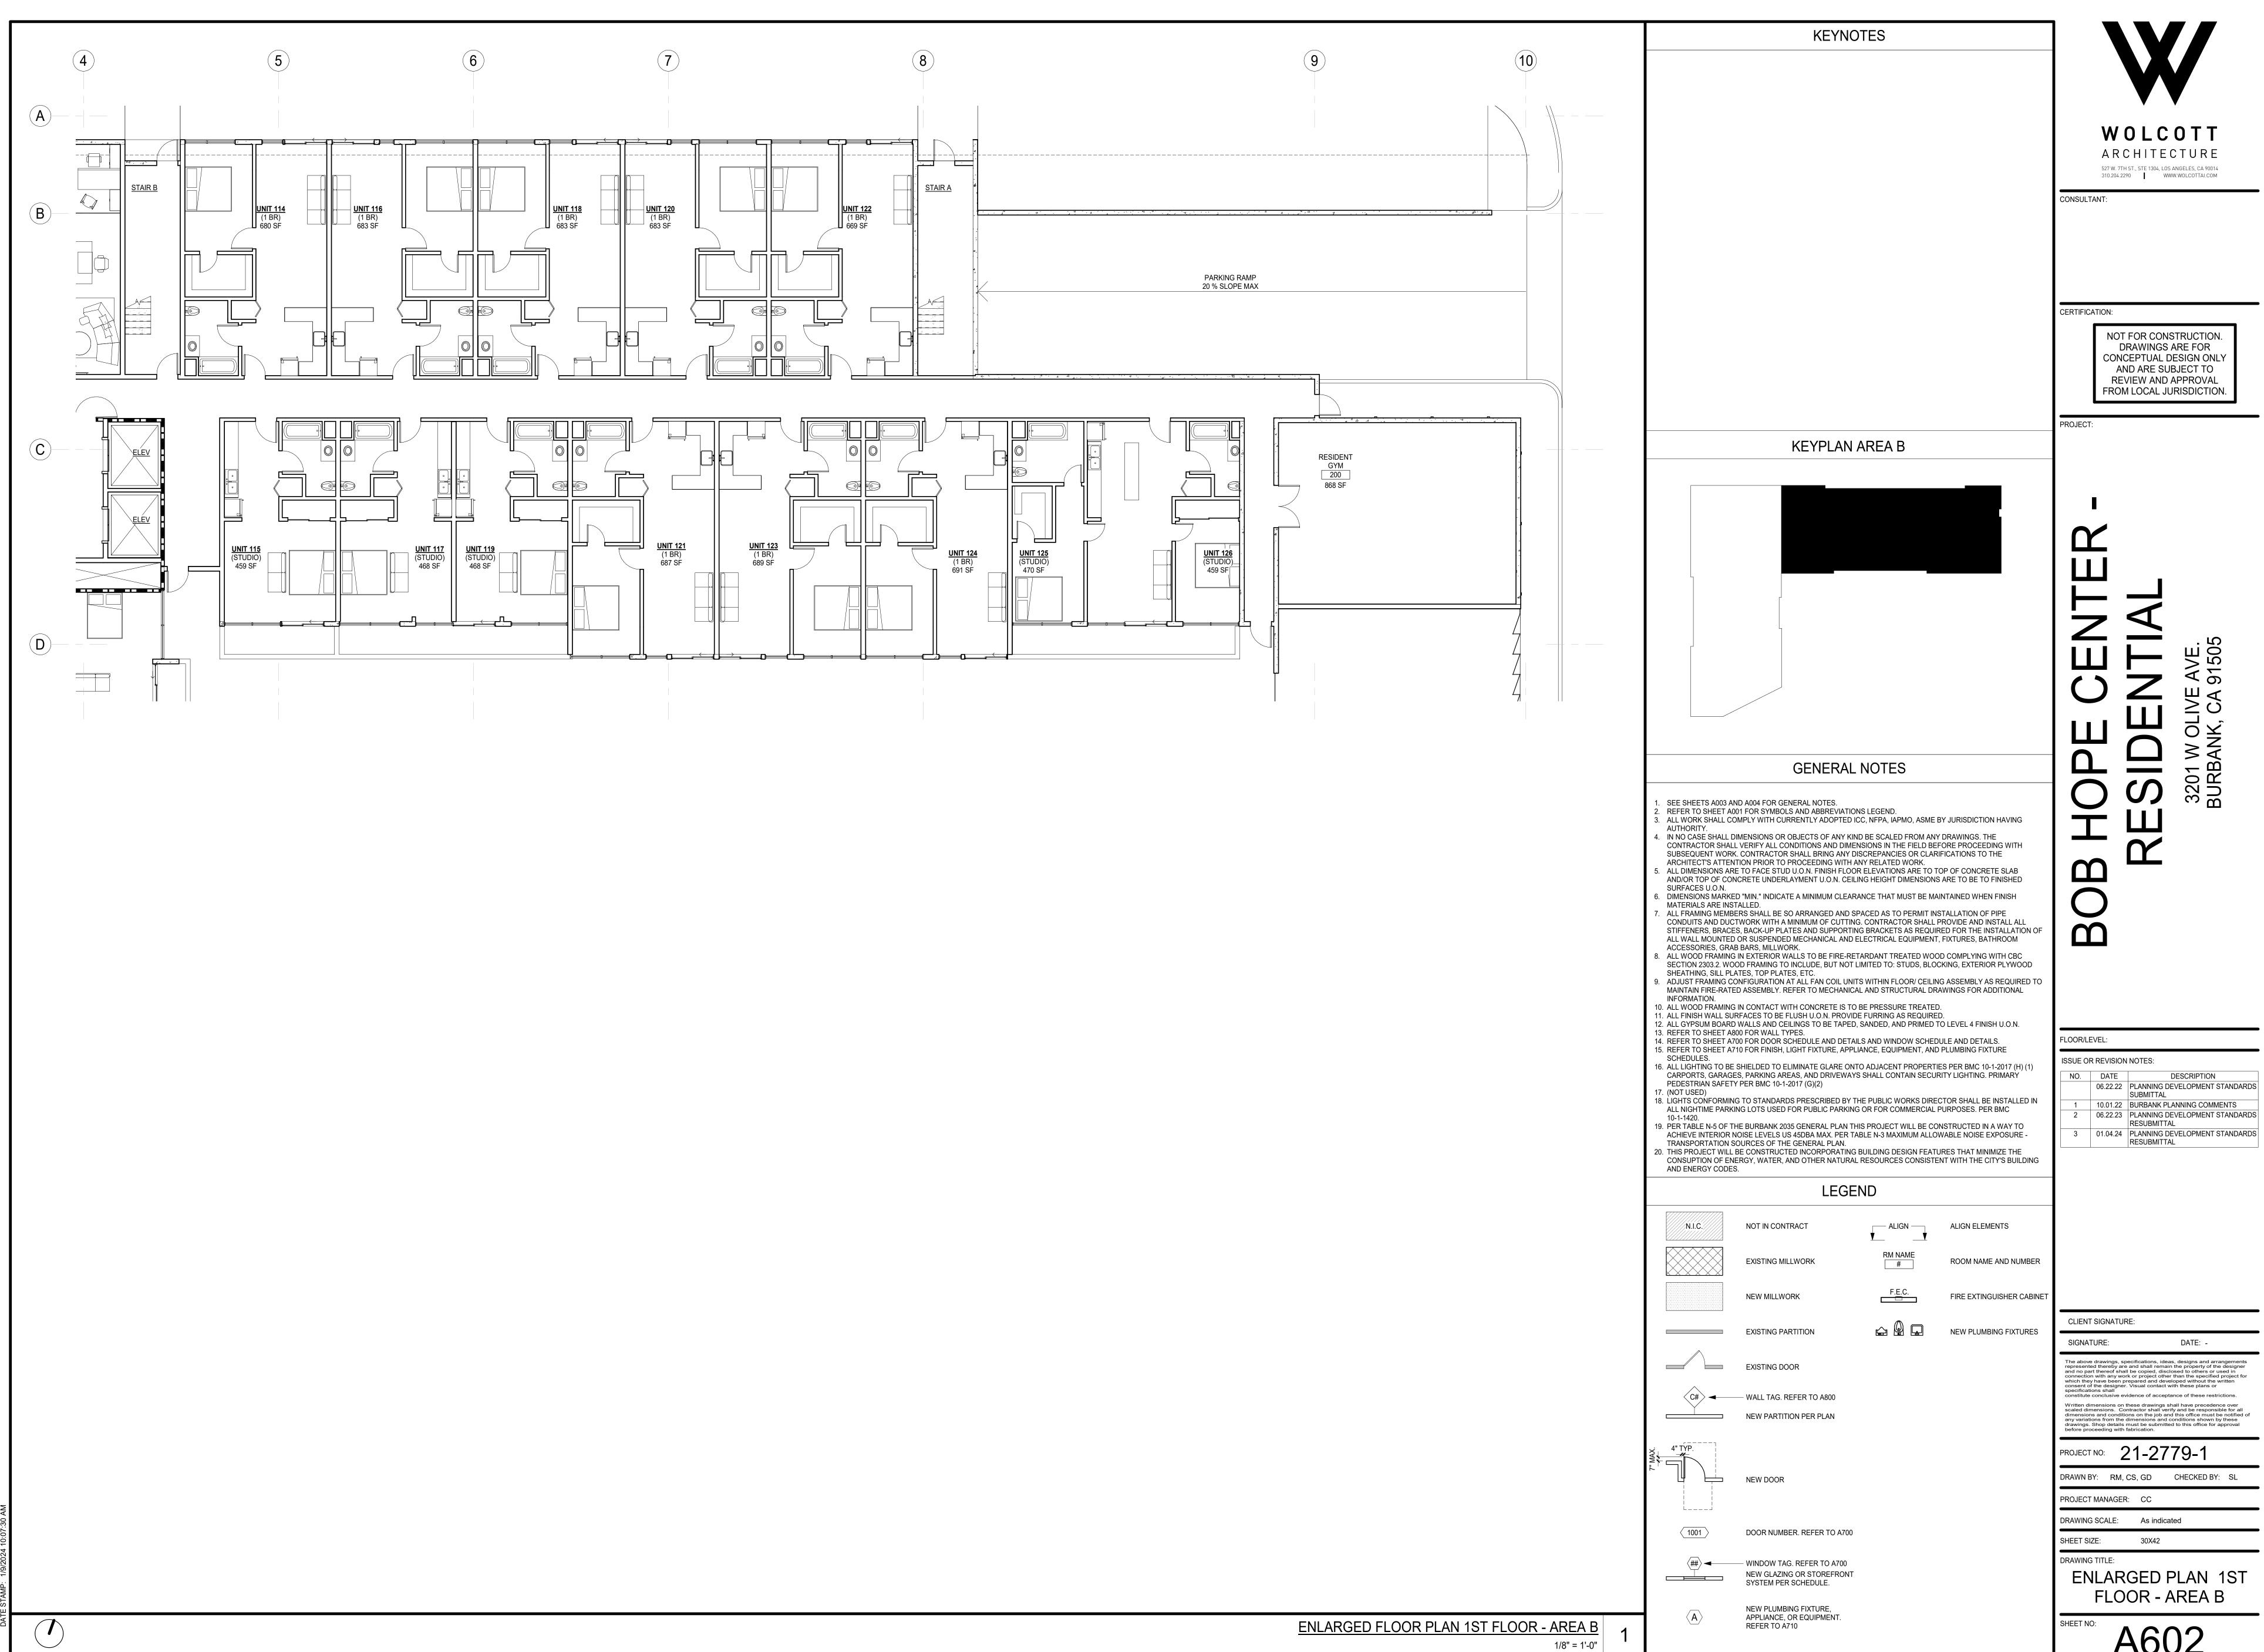


A602

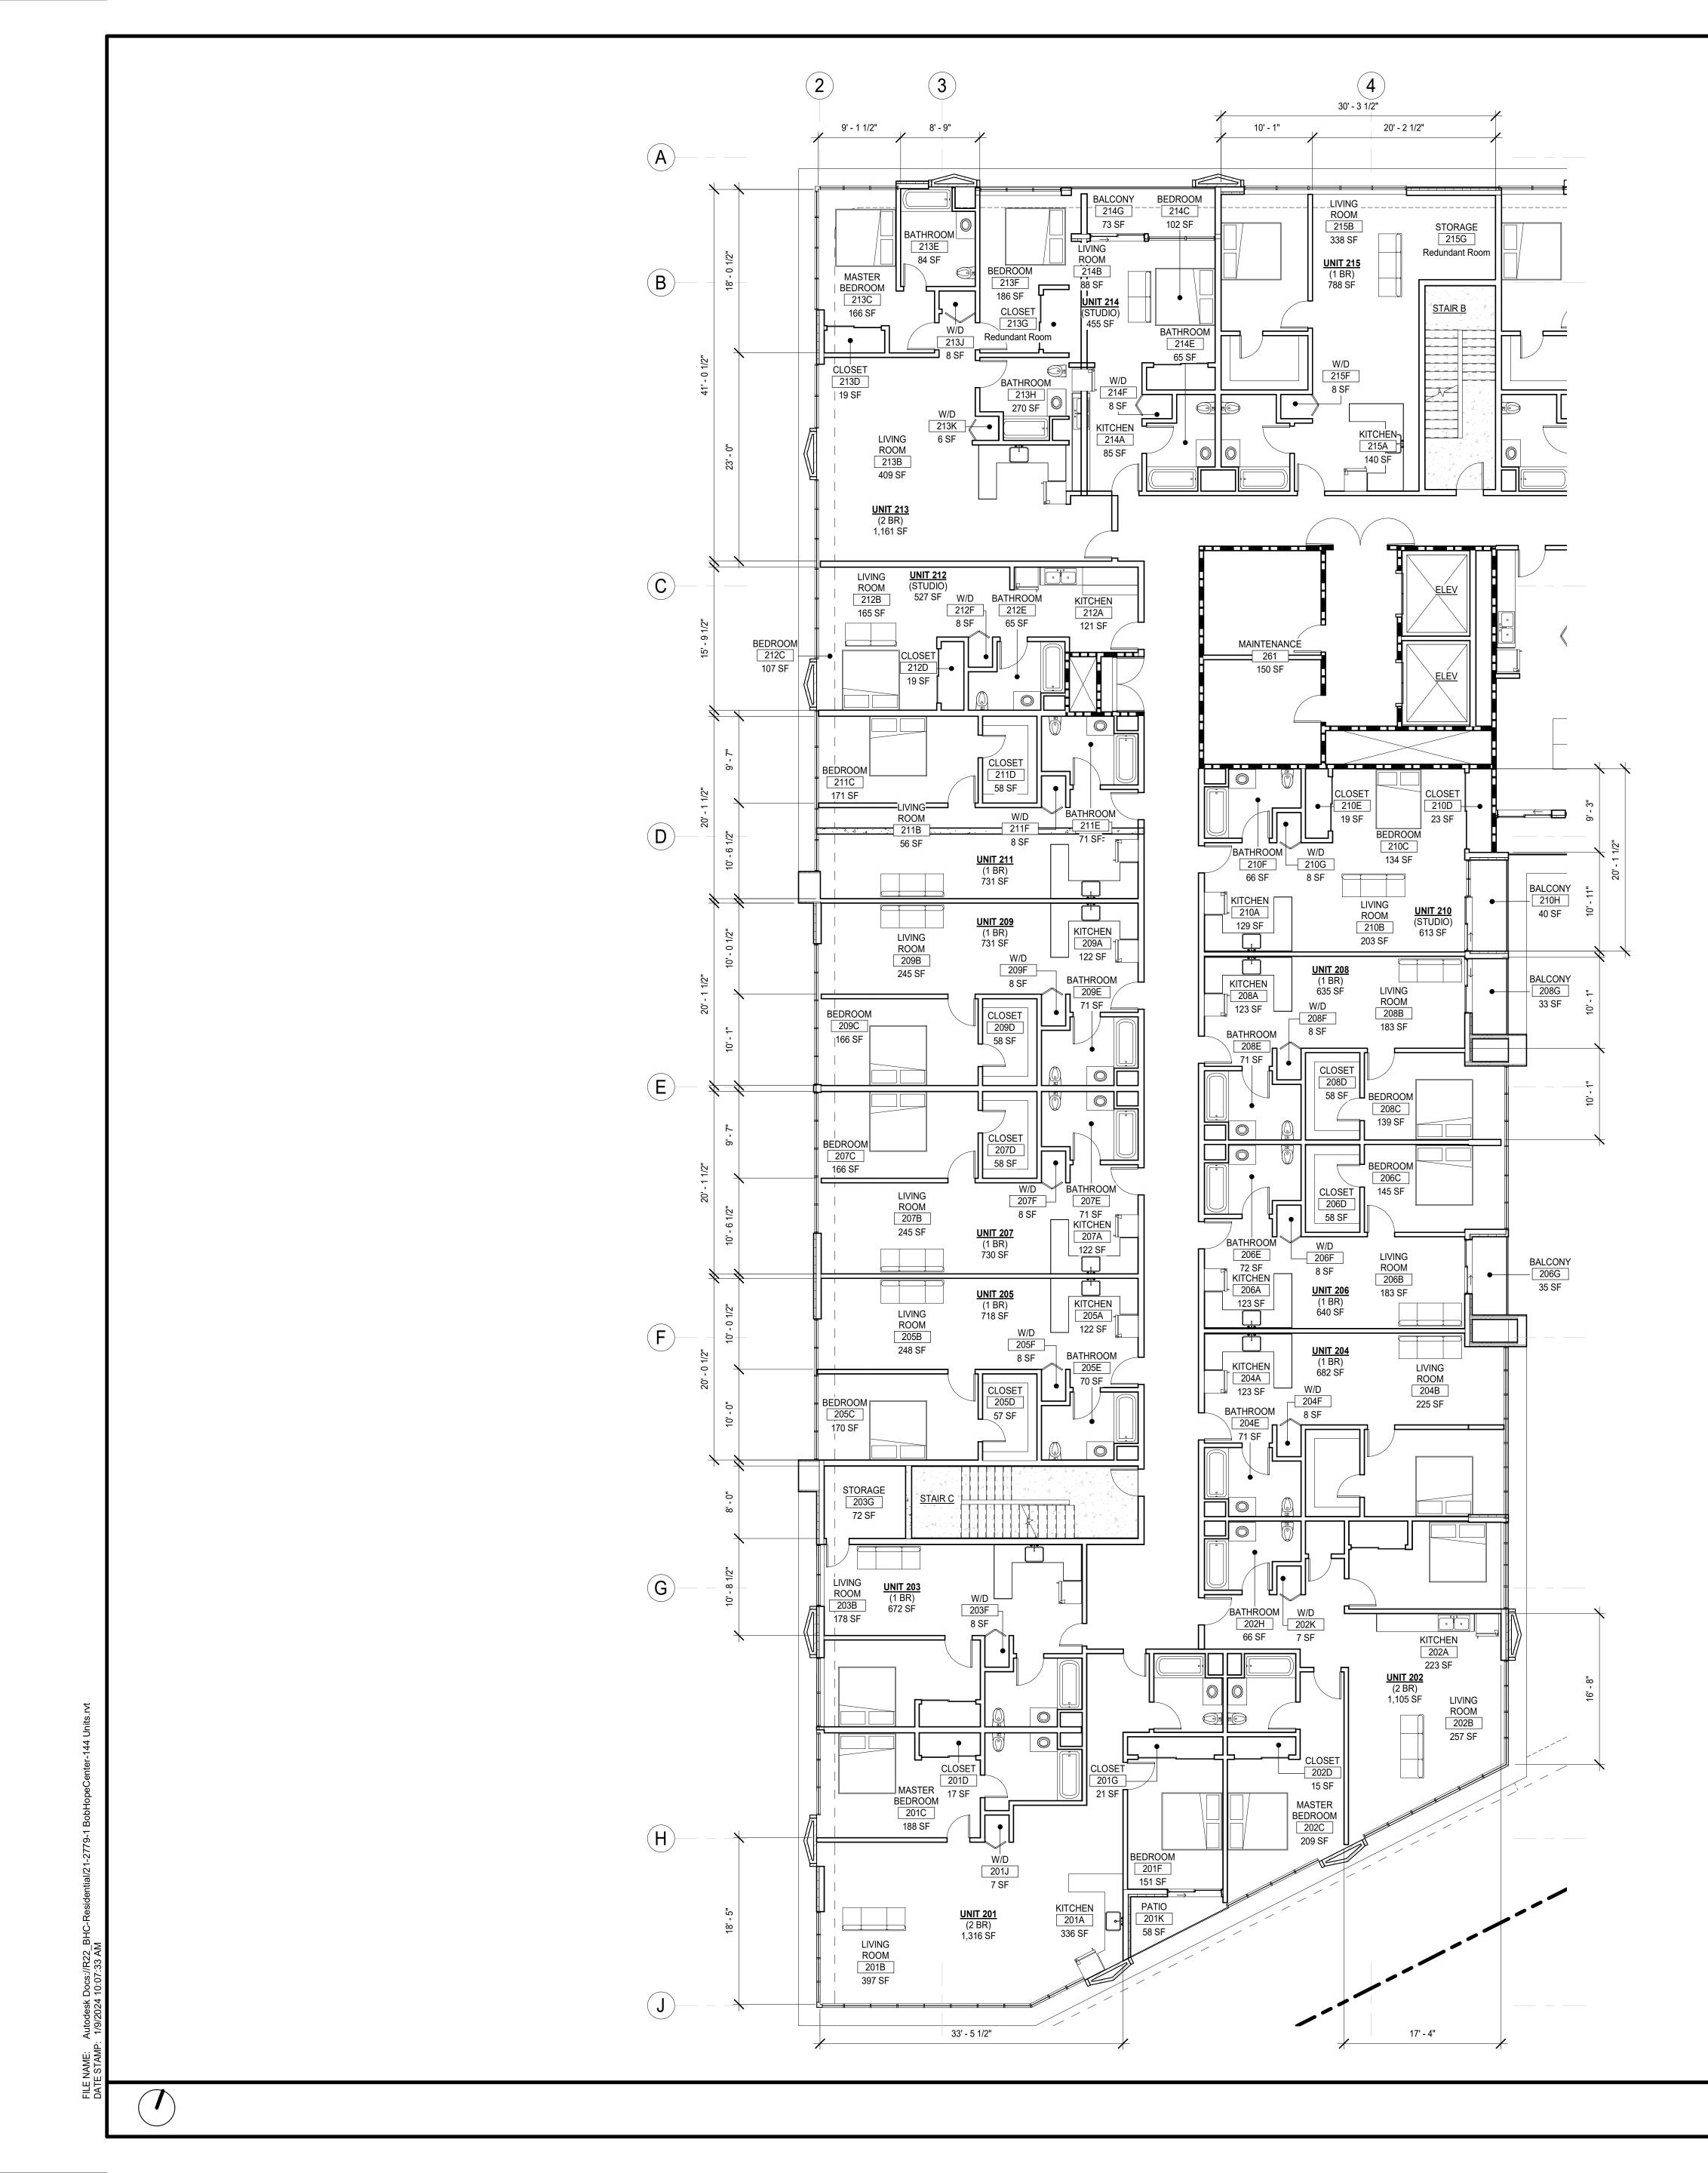

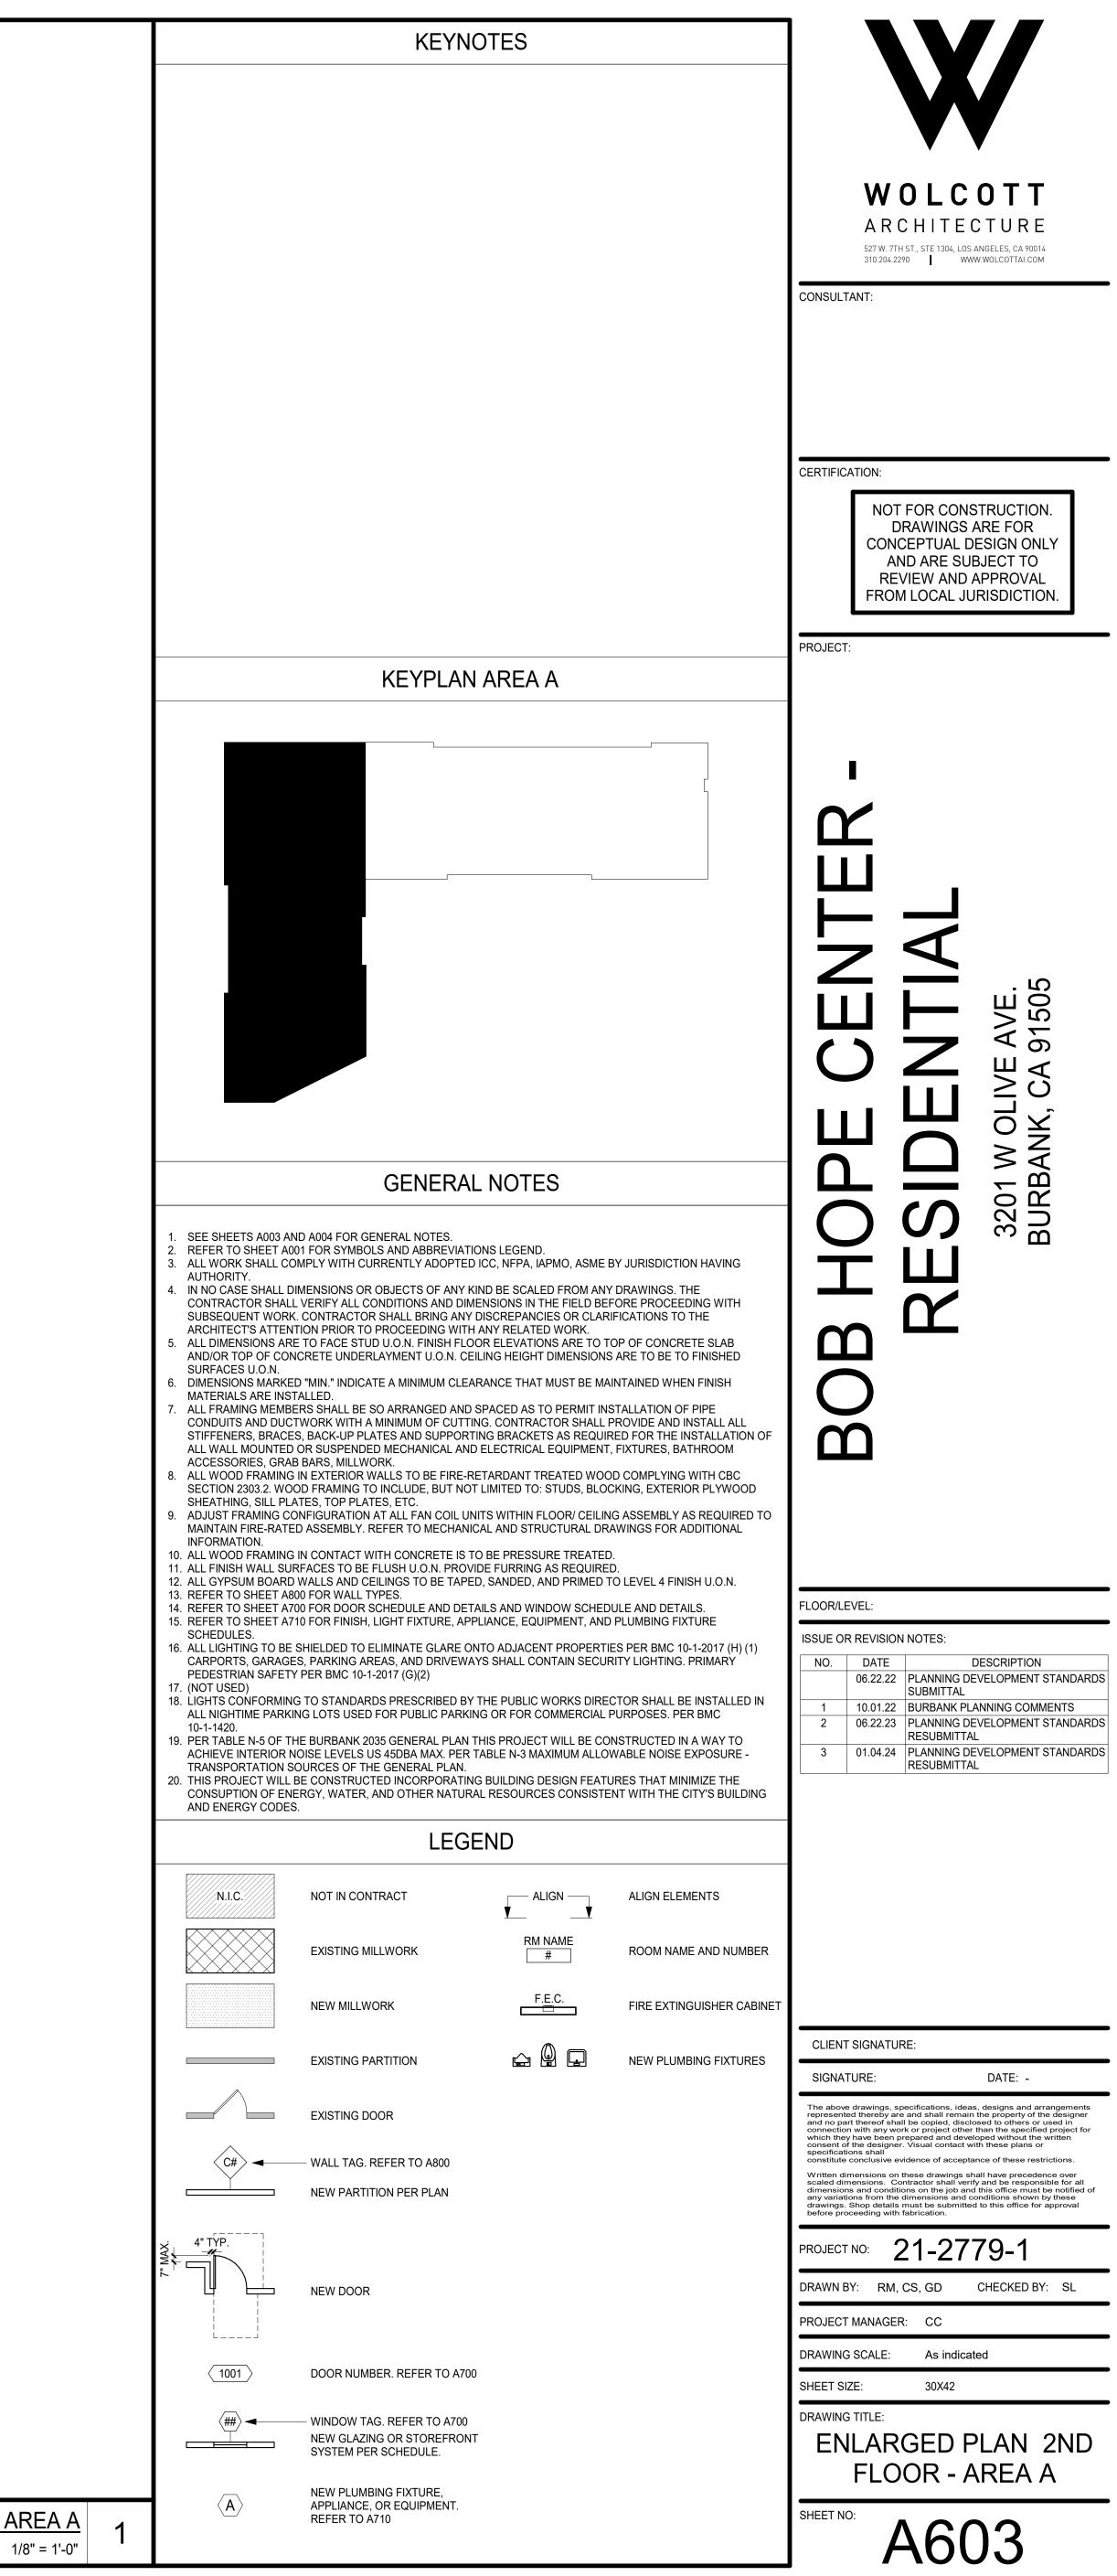



ARGED FLOOR PLAN 2ND FLOO	R - AREA A

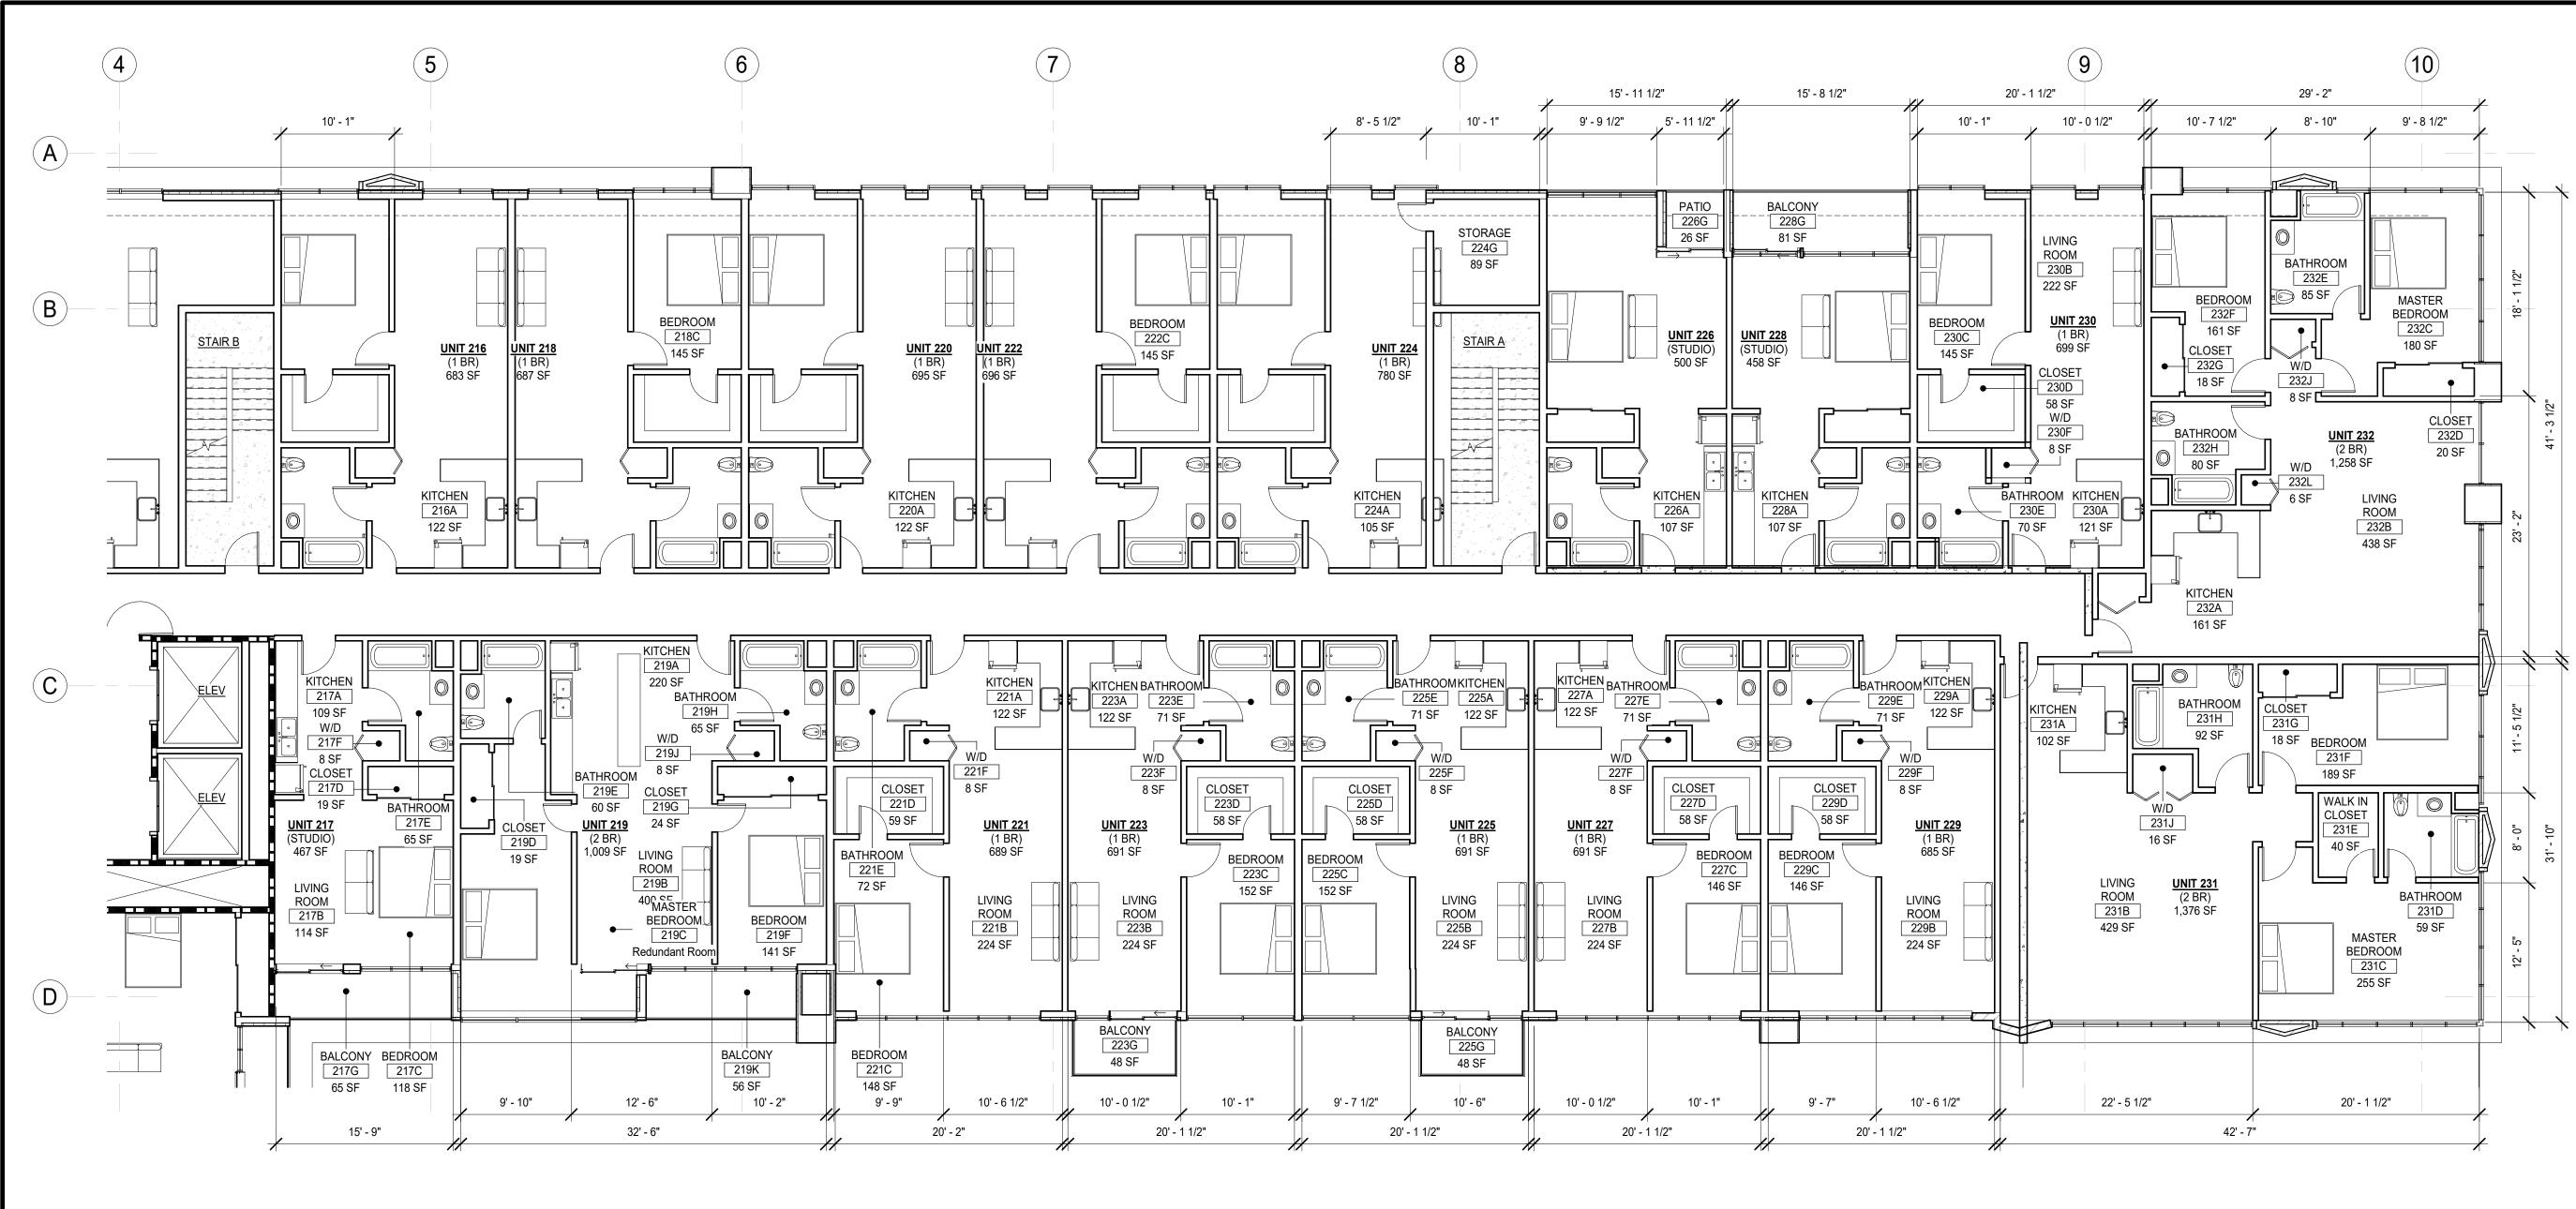





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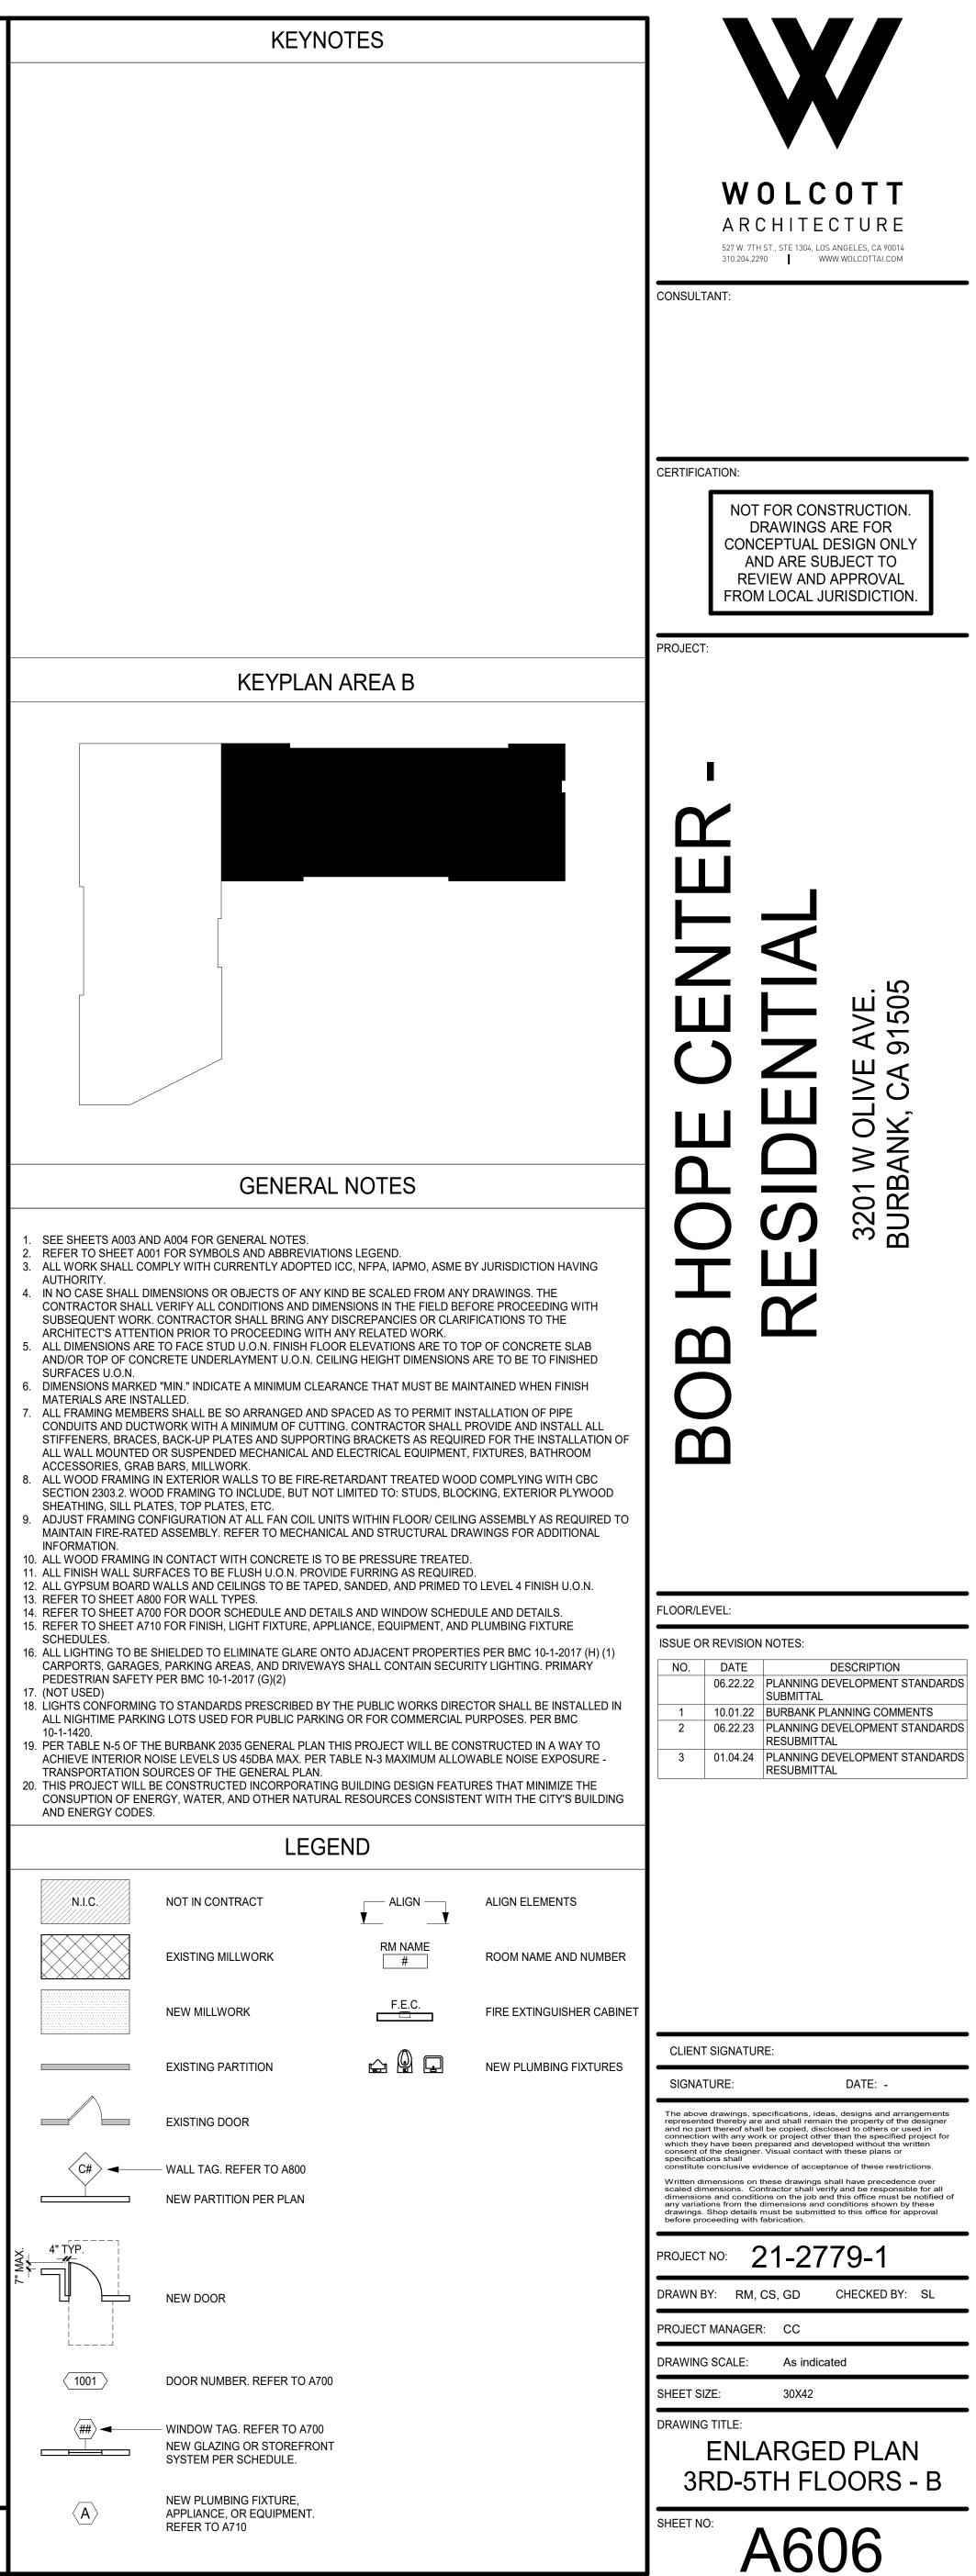
ENLARGED FLOOR PLAN 3RD-5TH FLOORS - AREA A

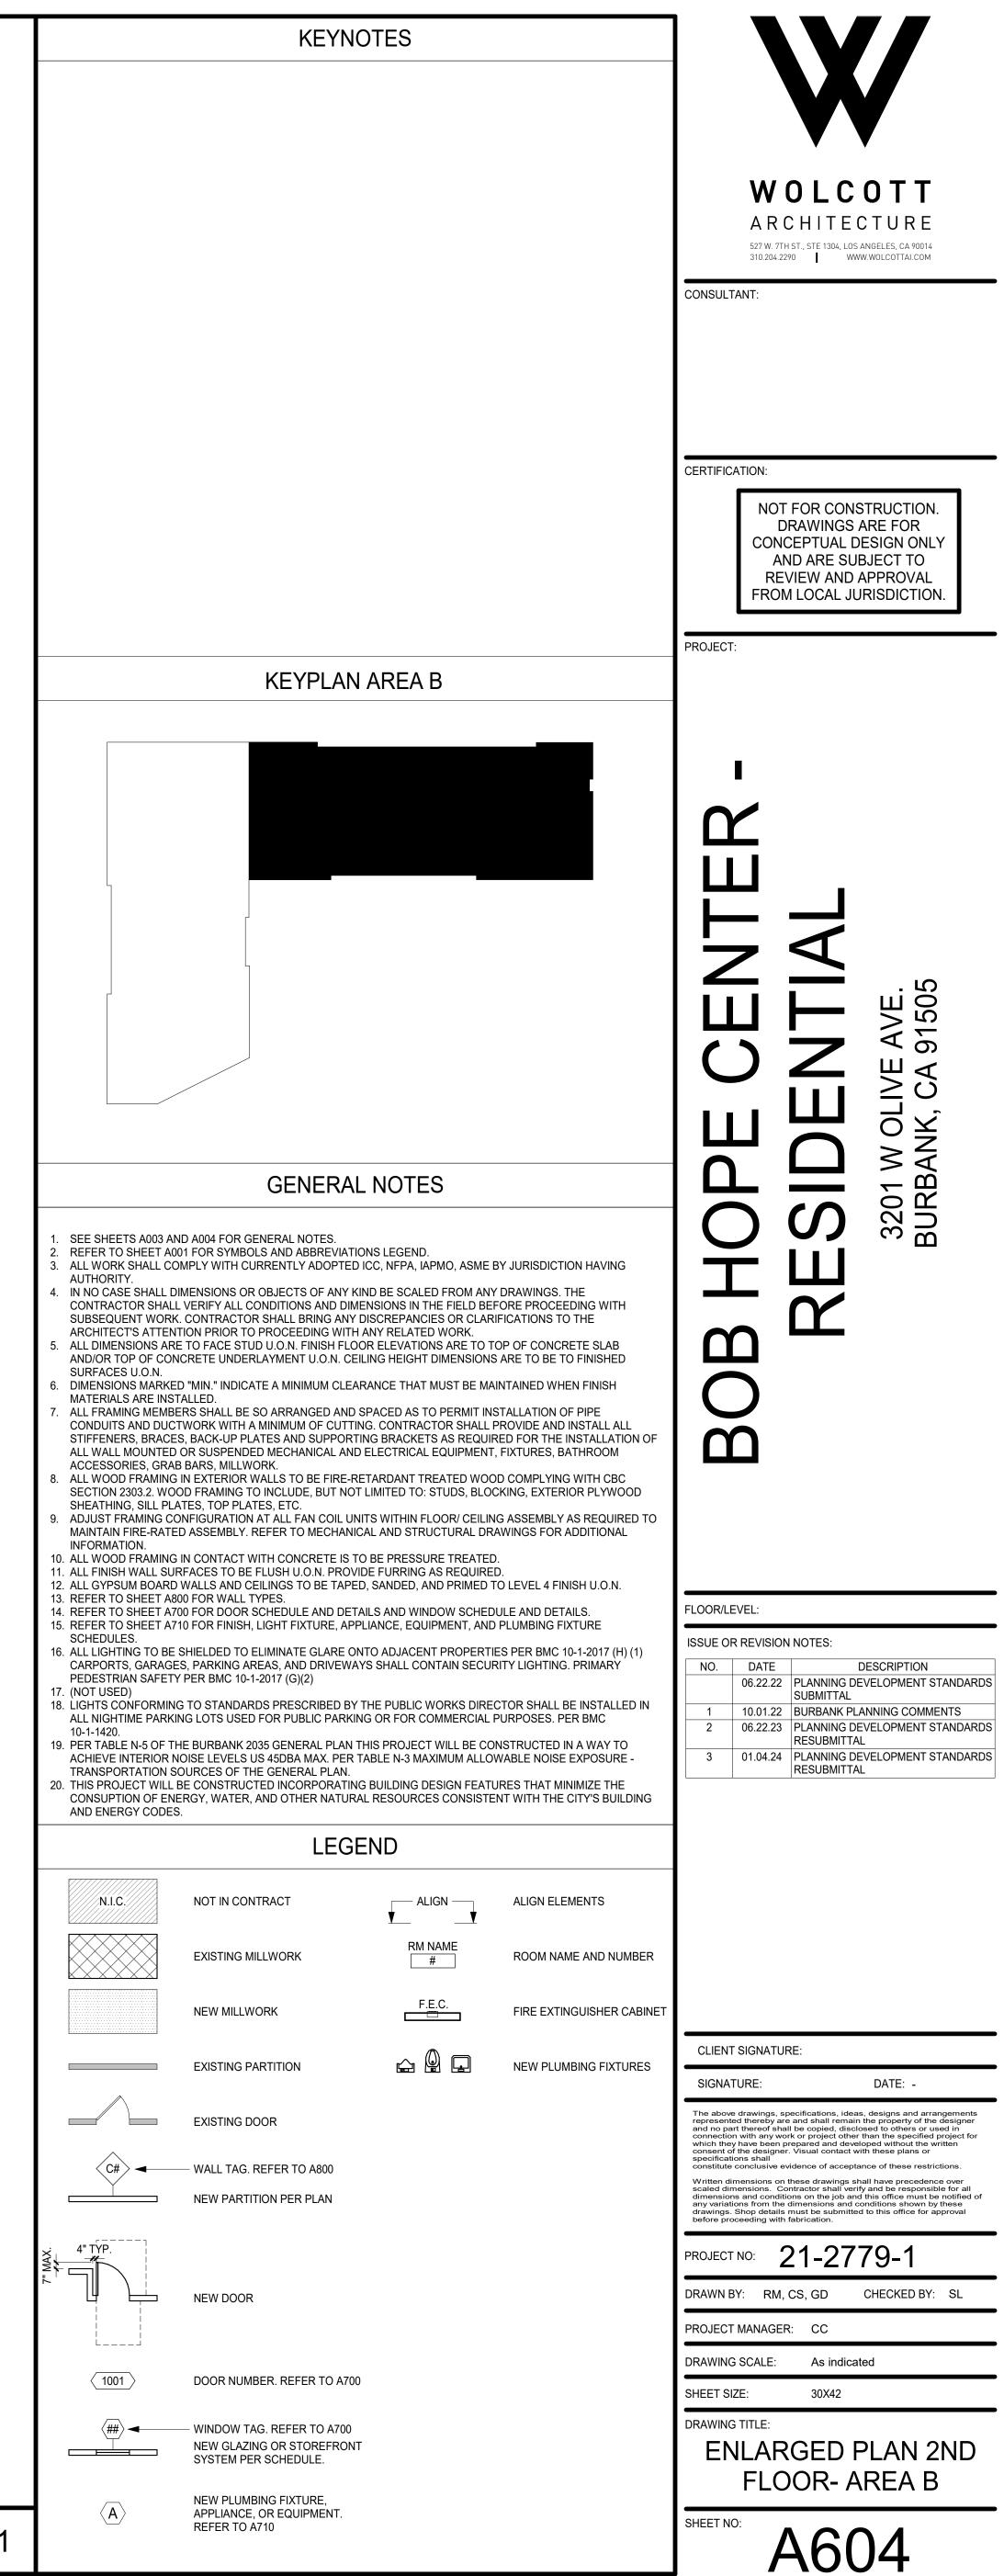


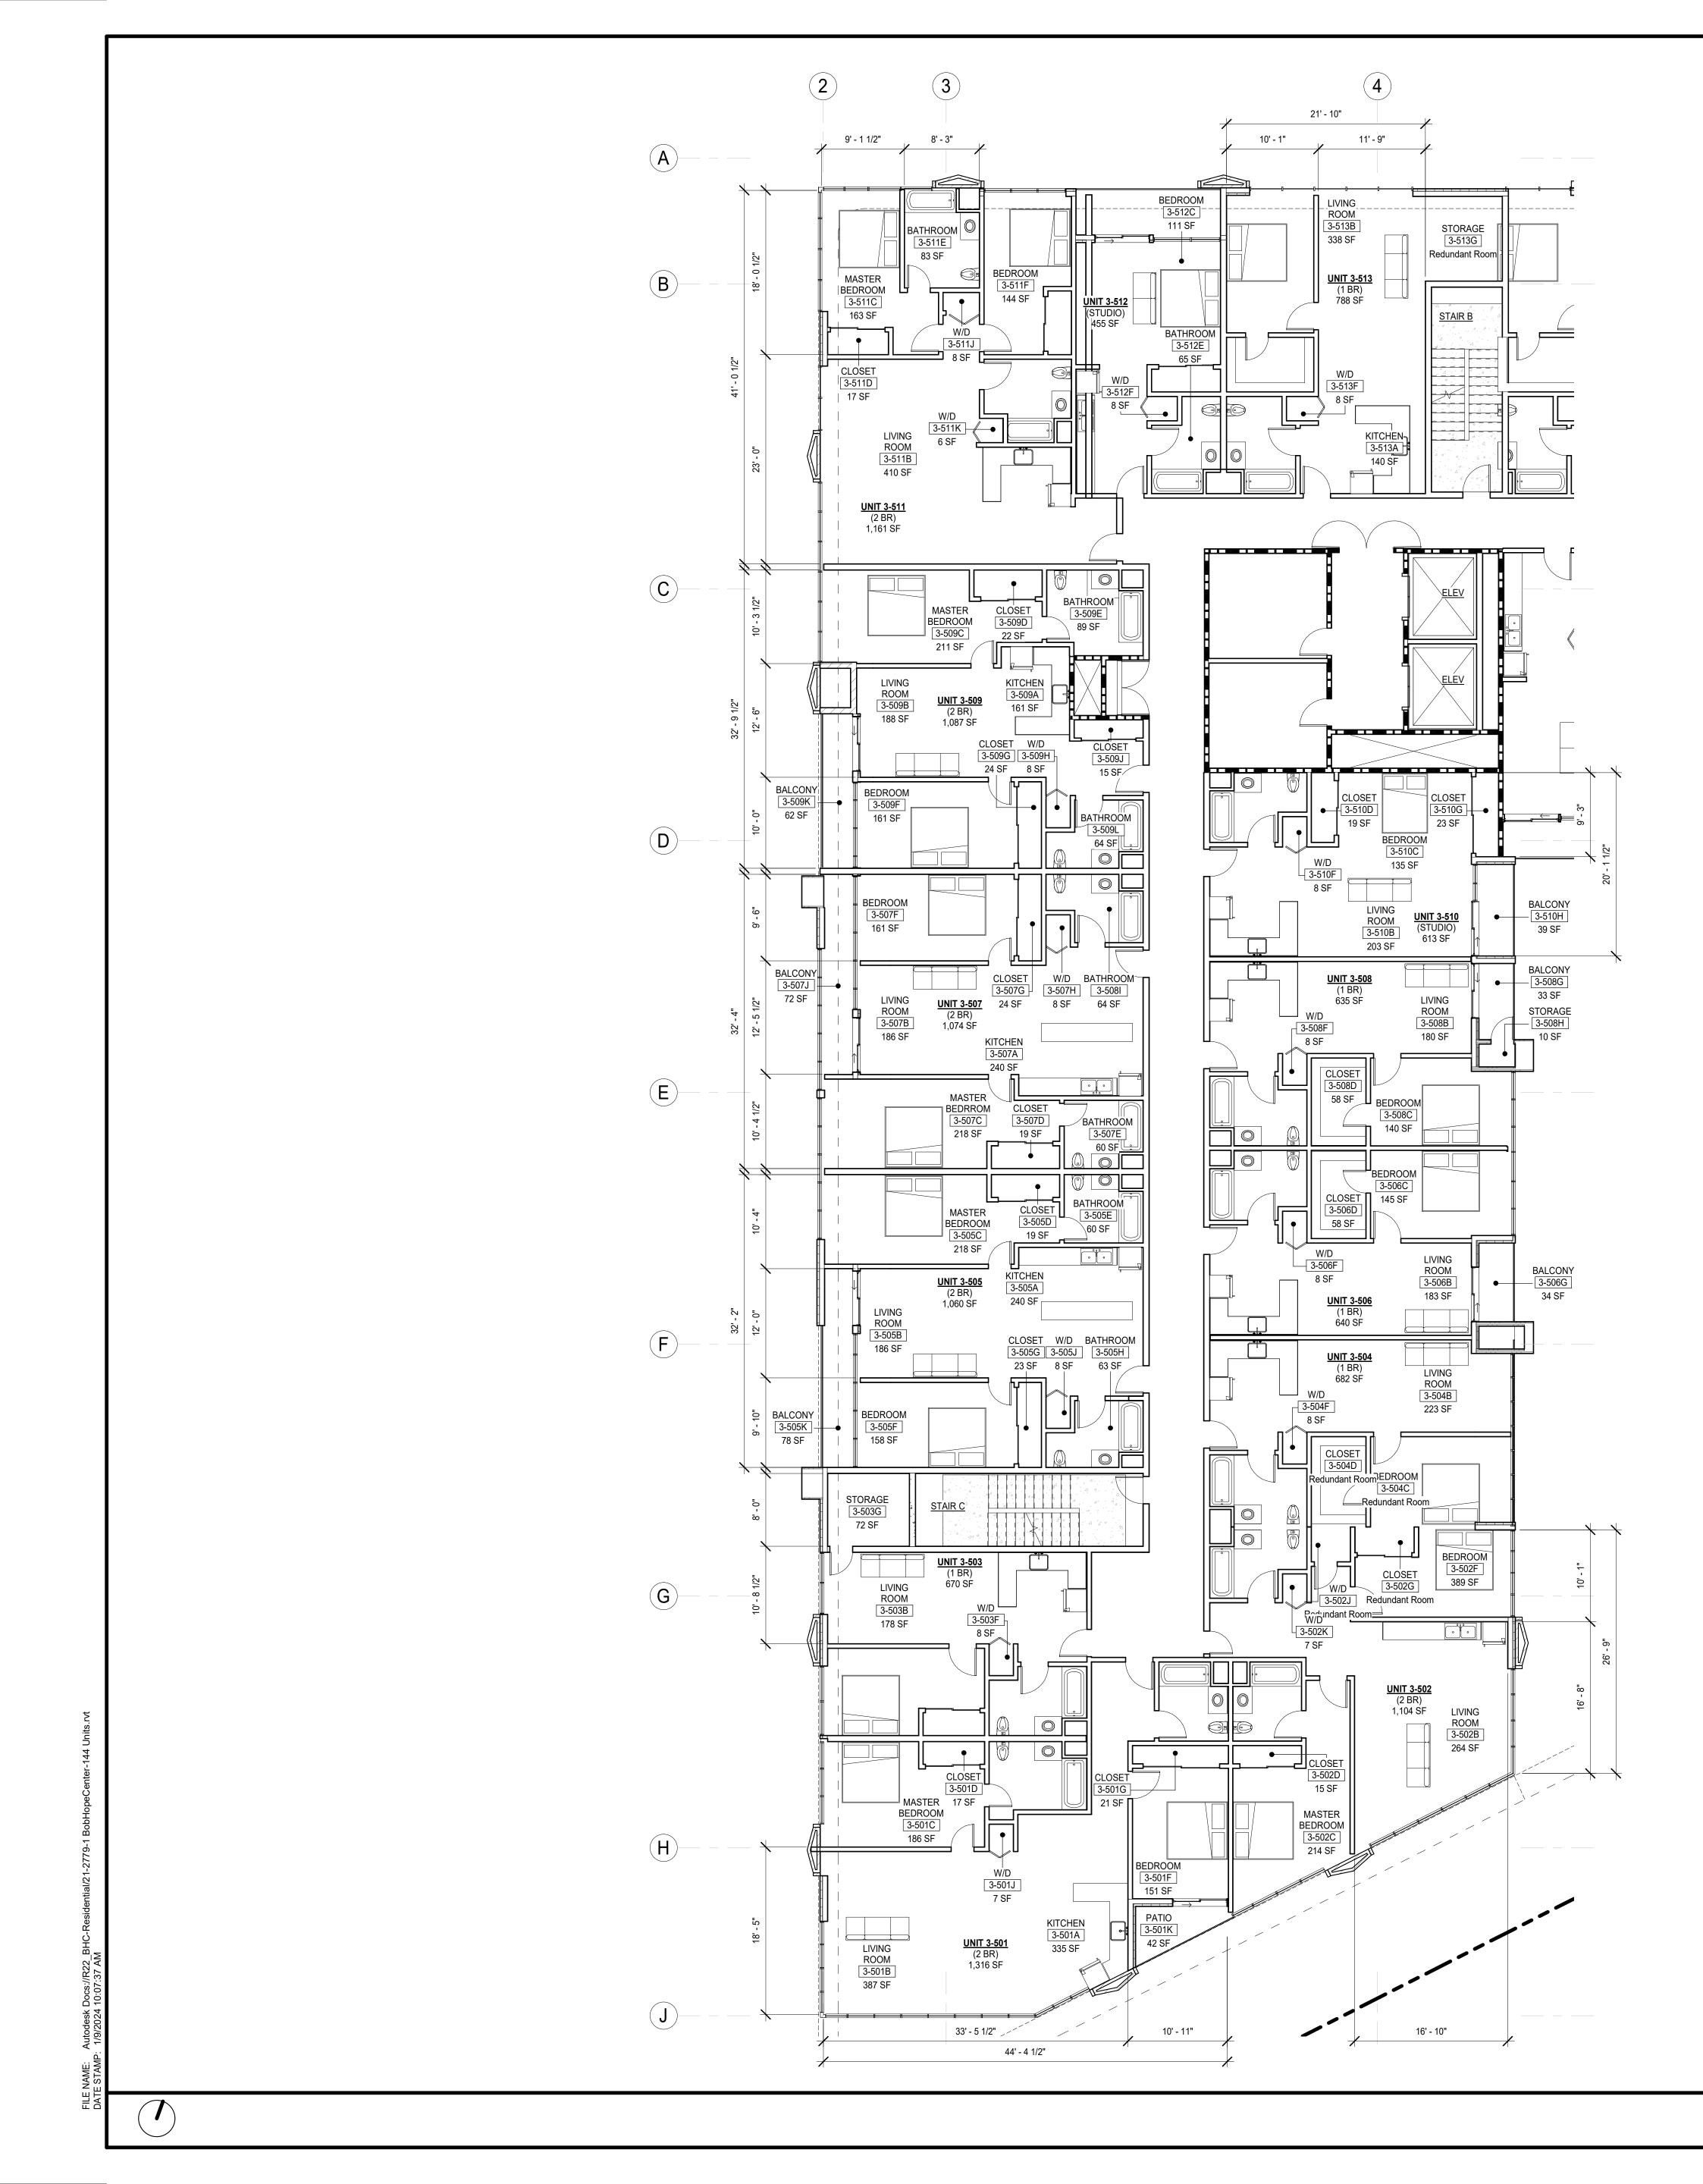

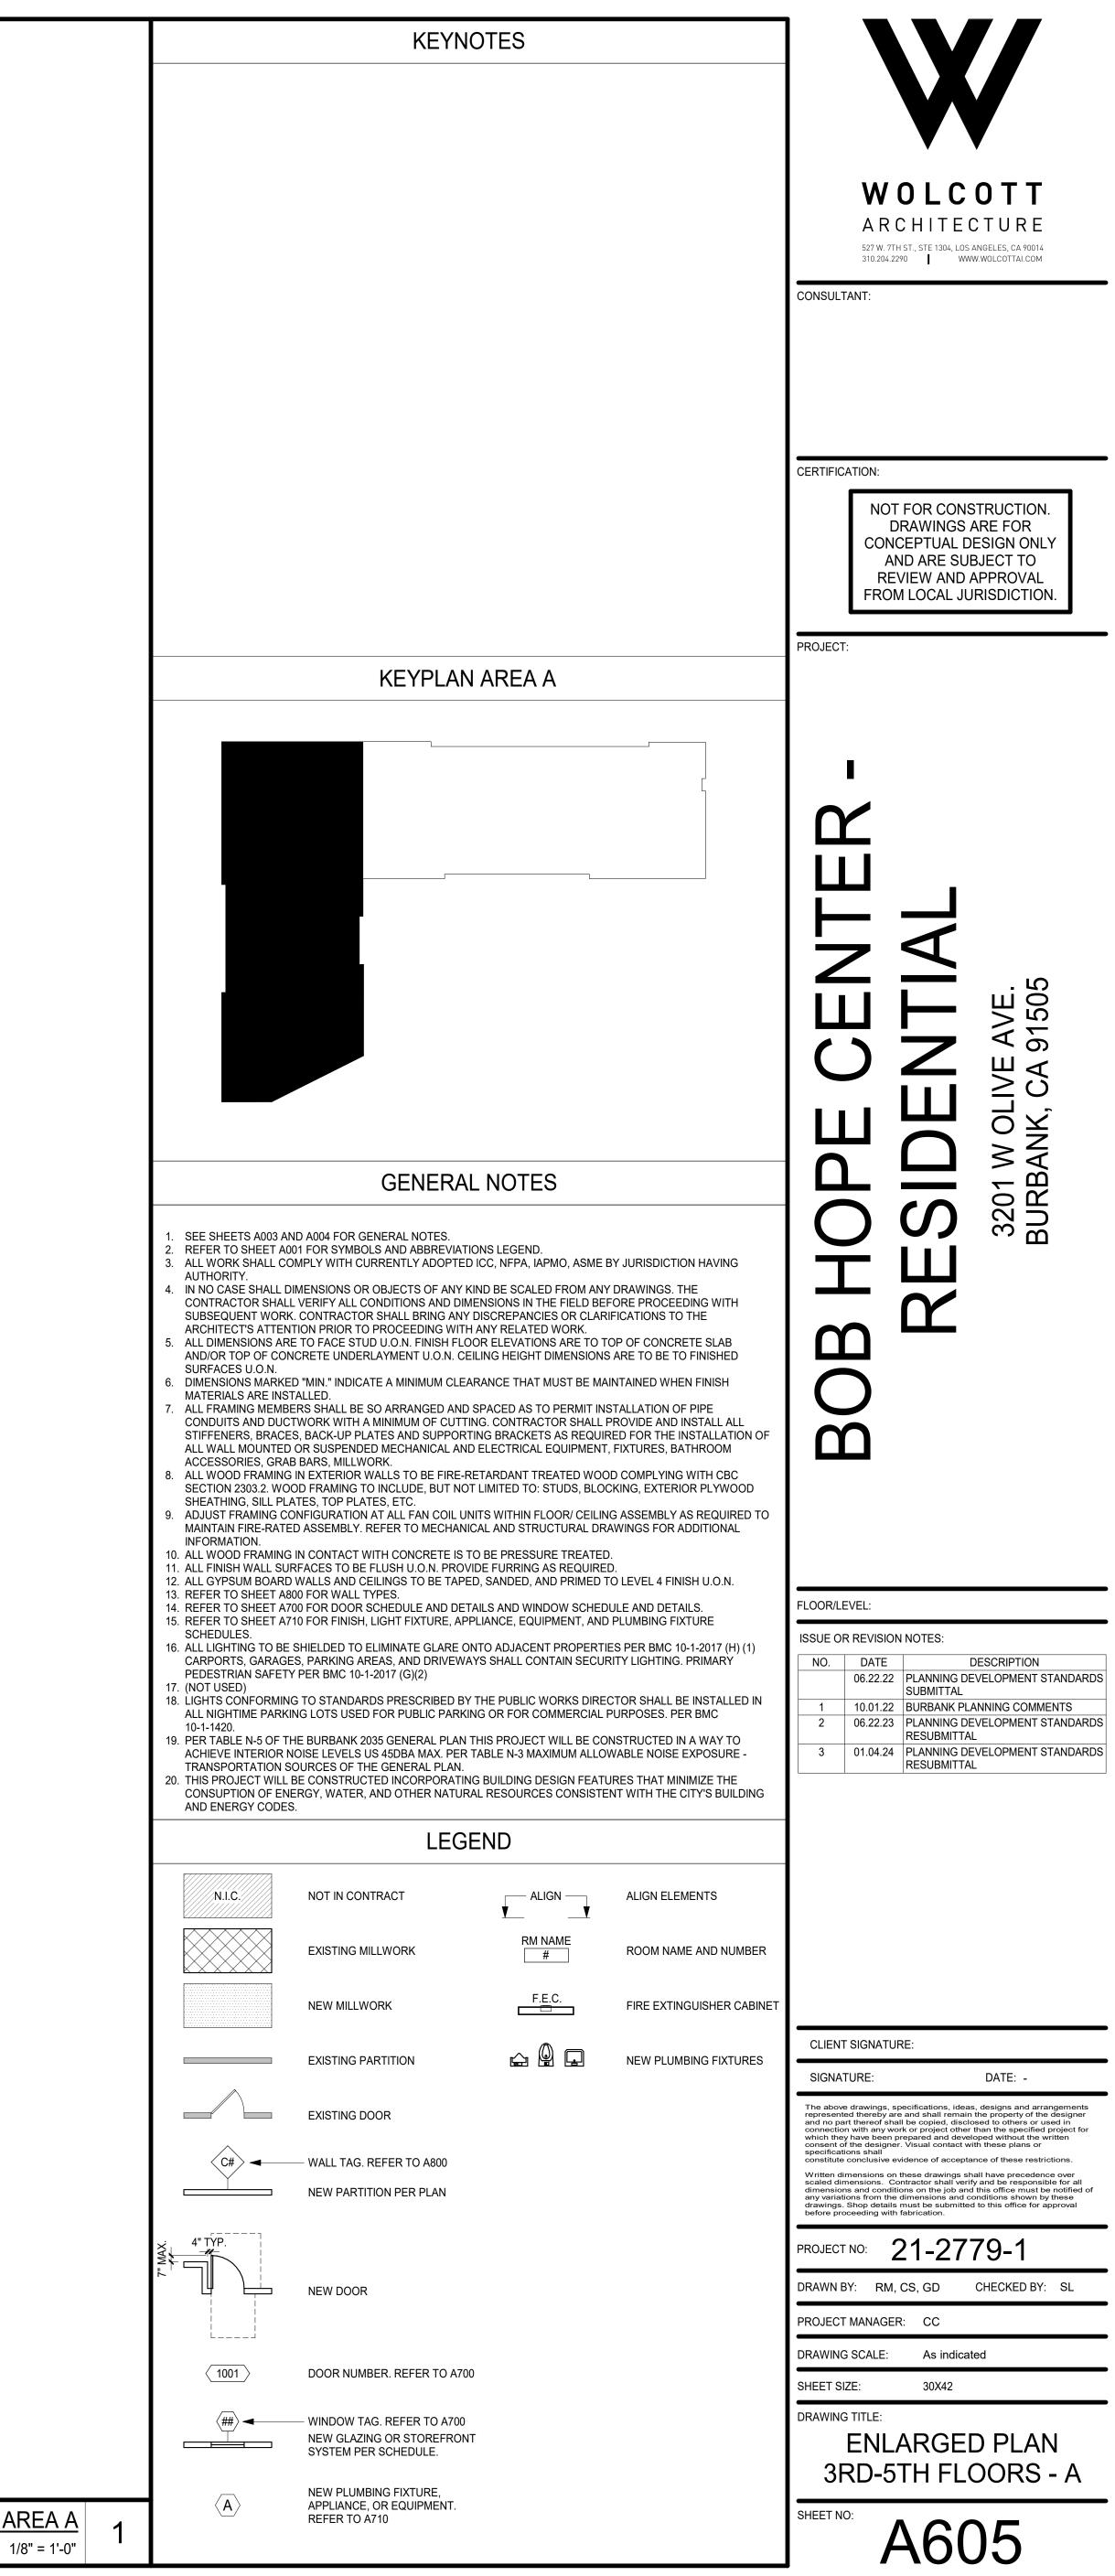
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1/8" = 1'-0"



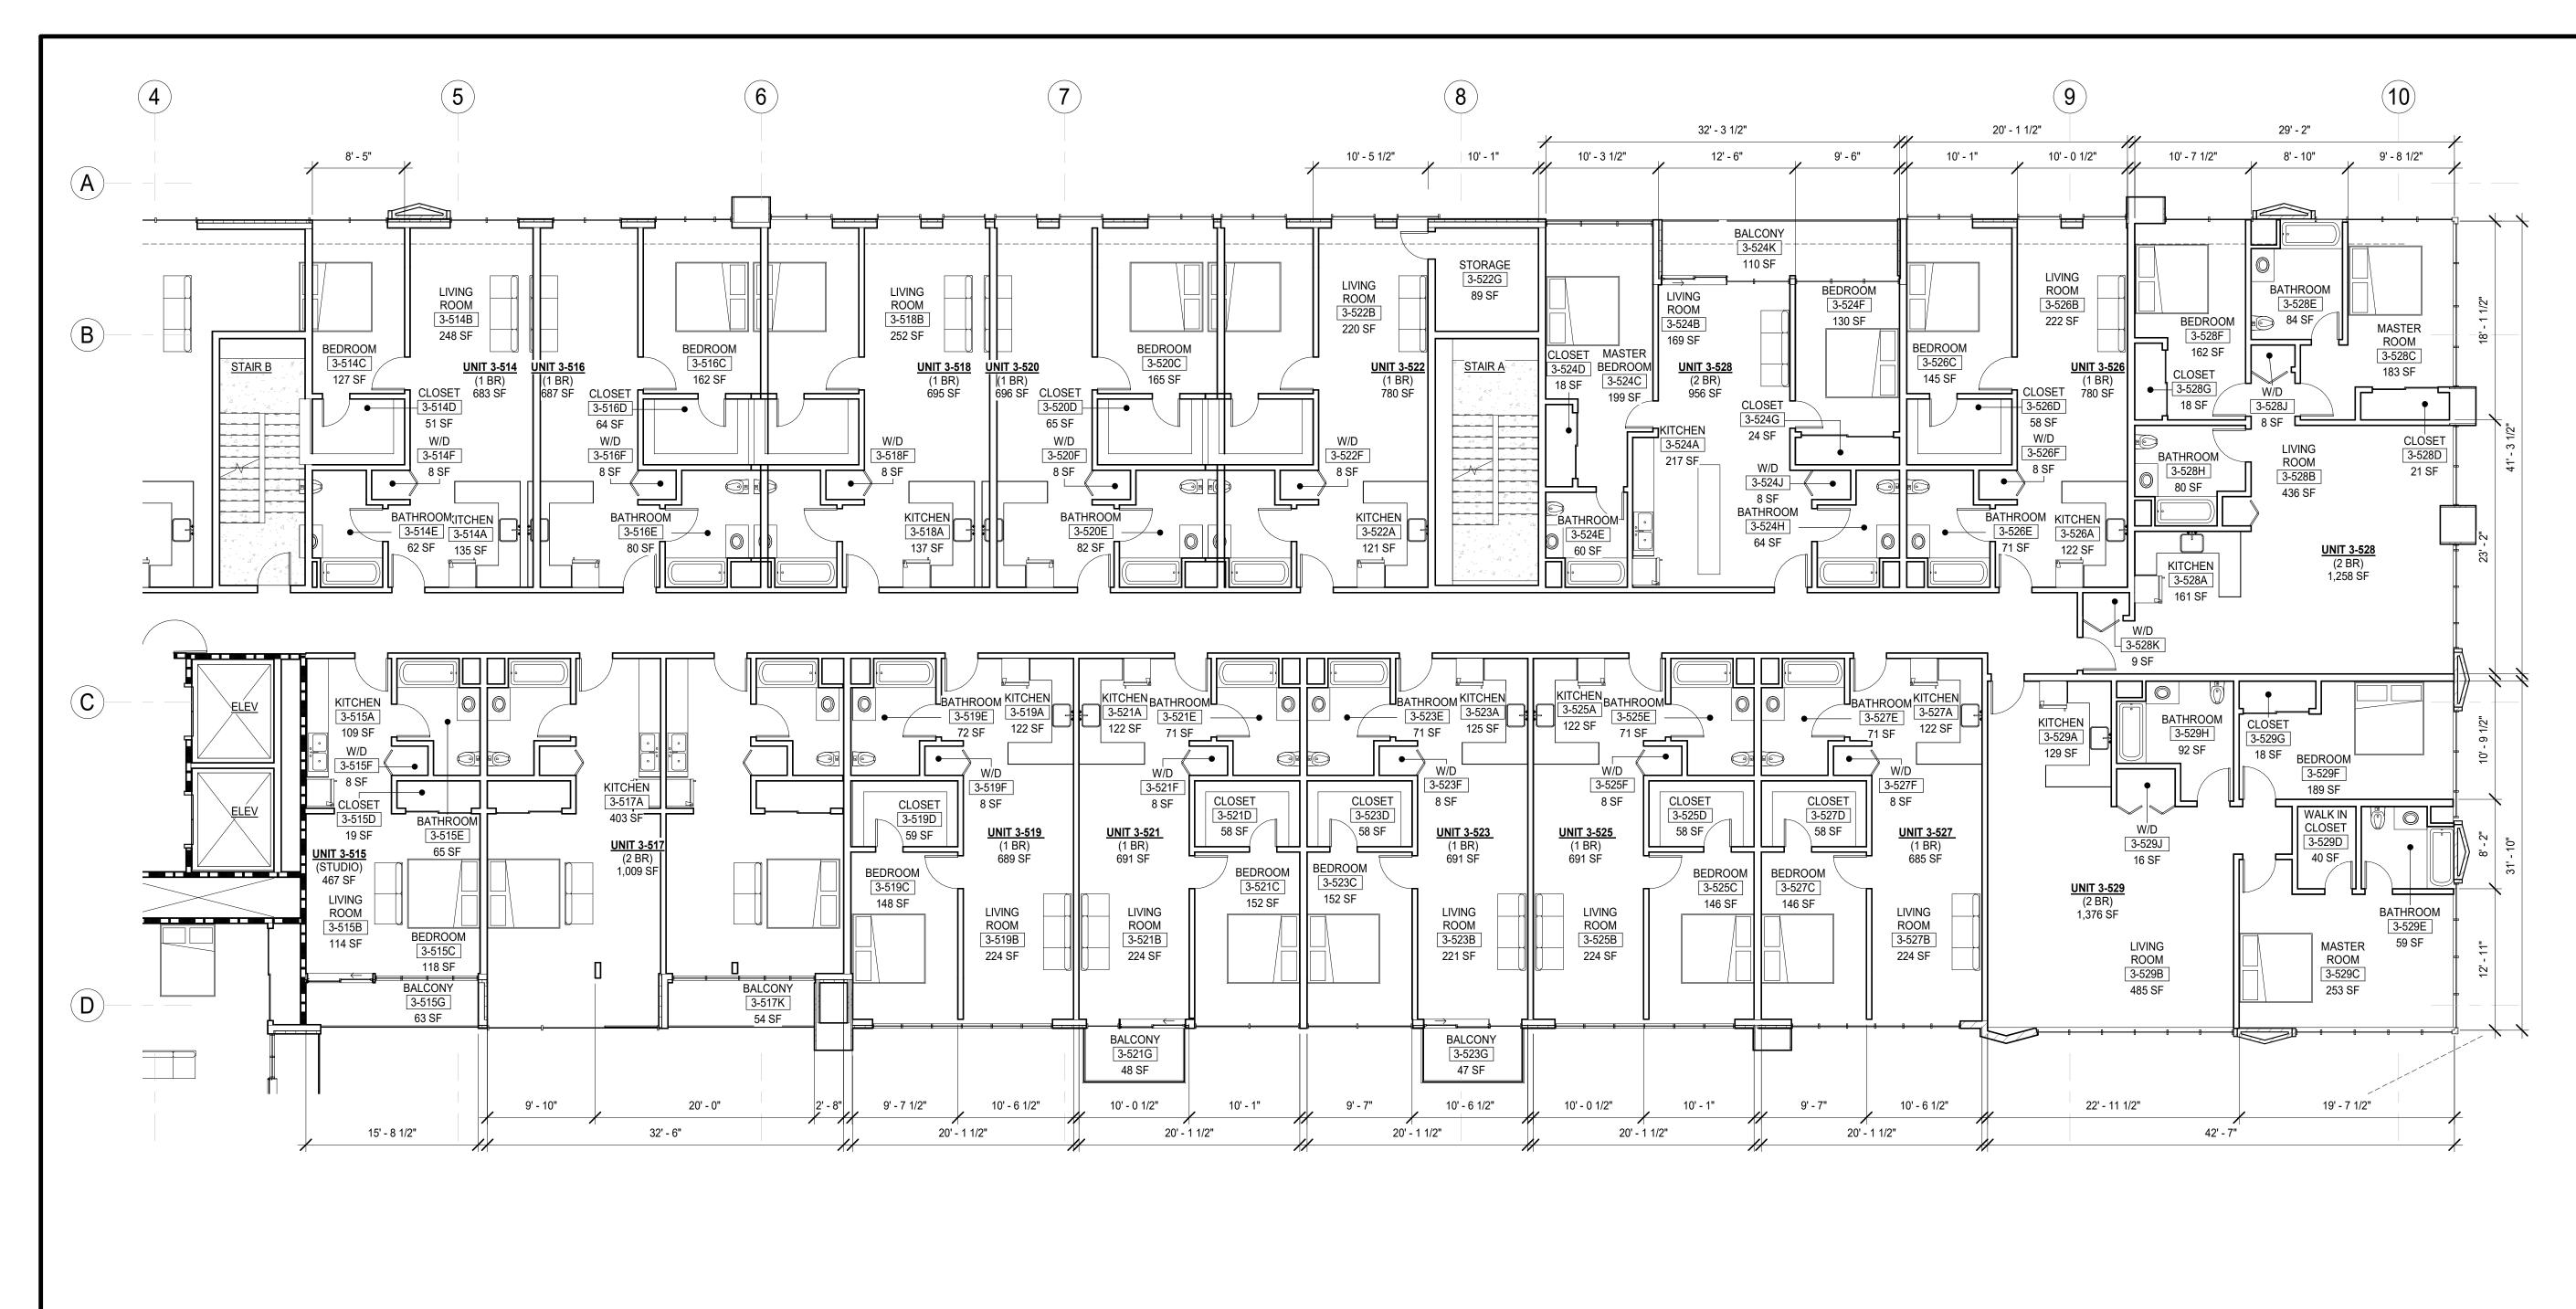


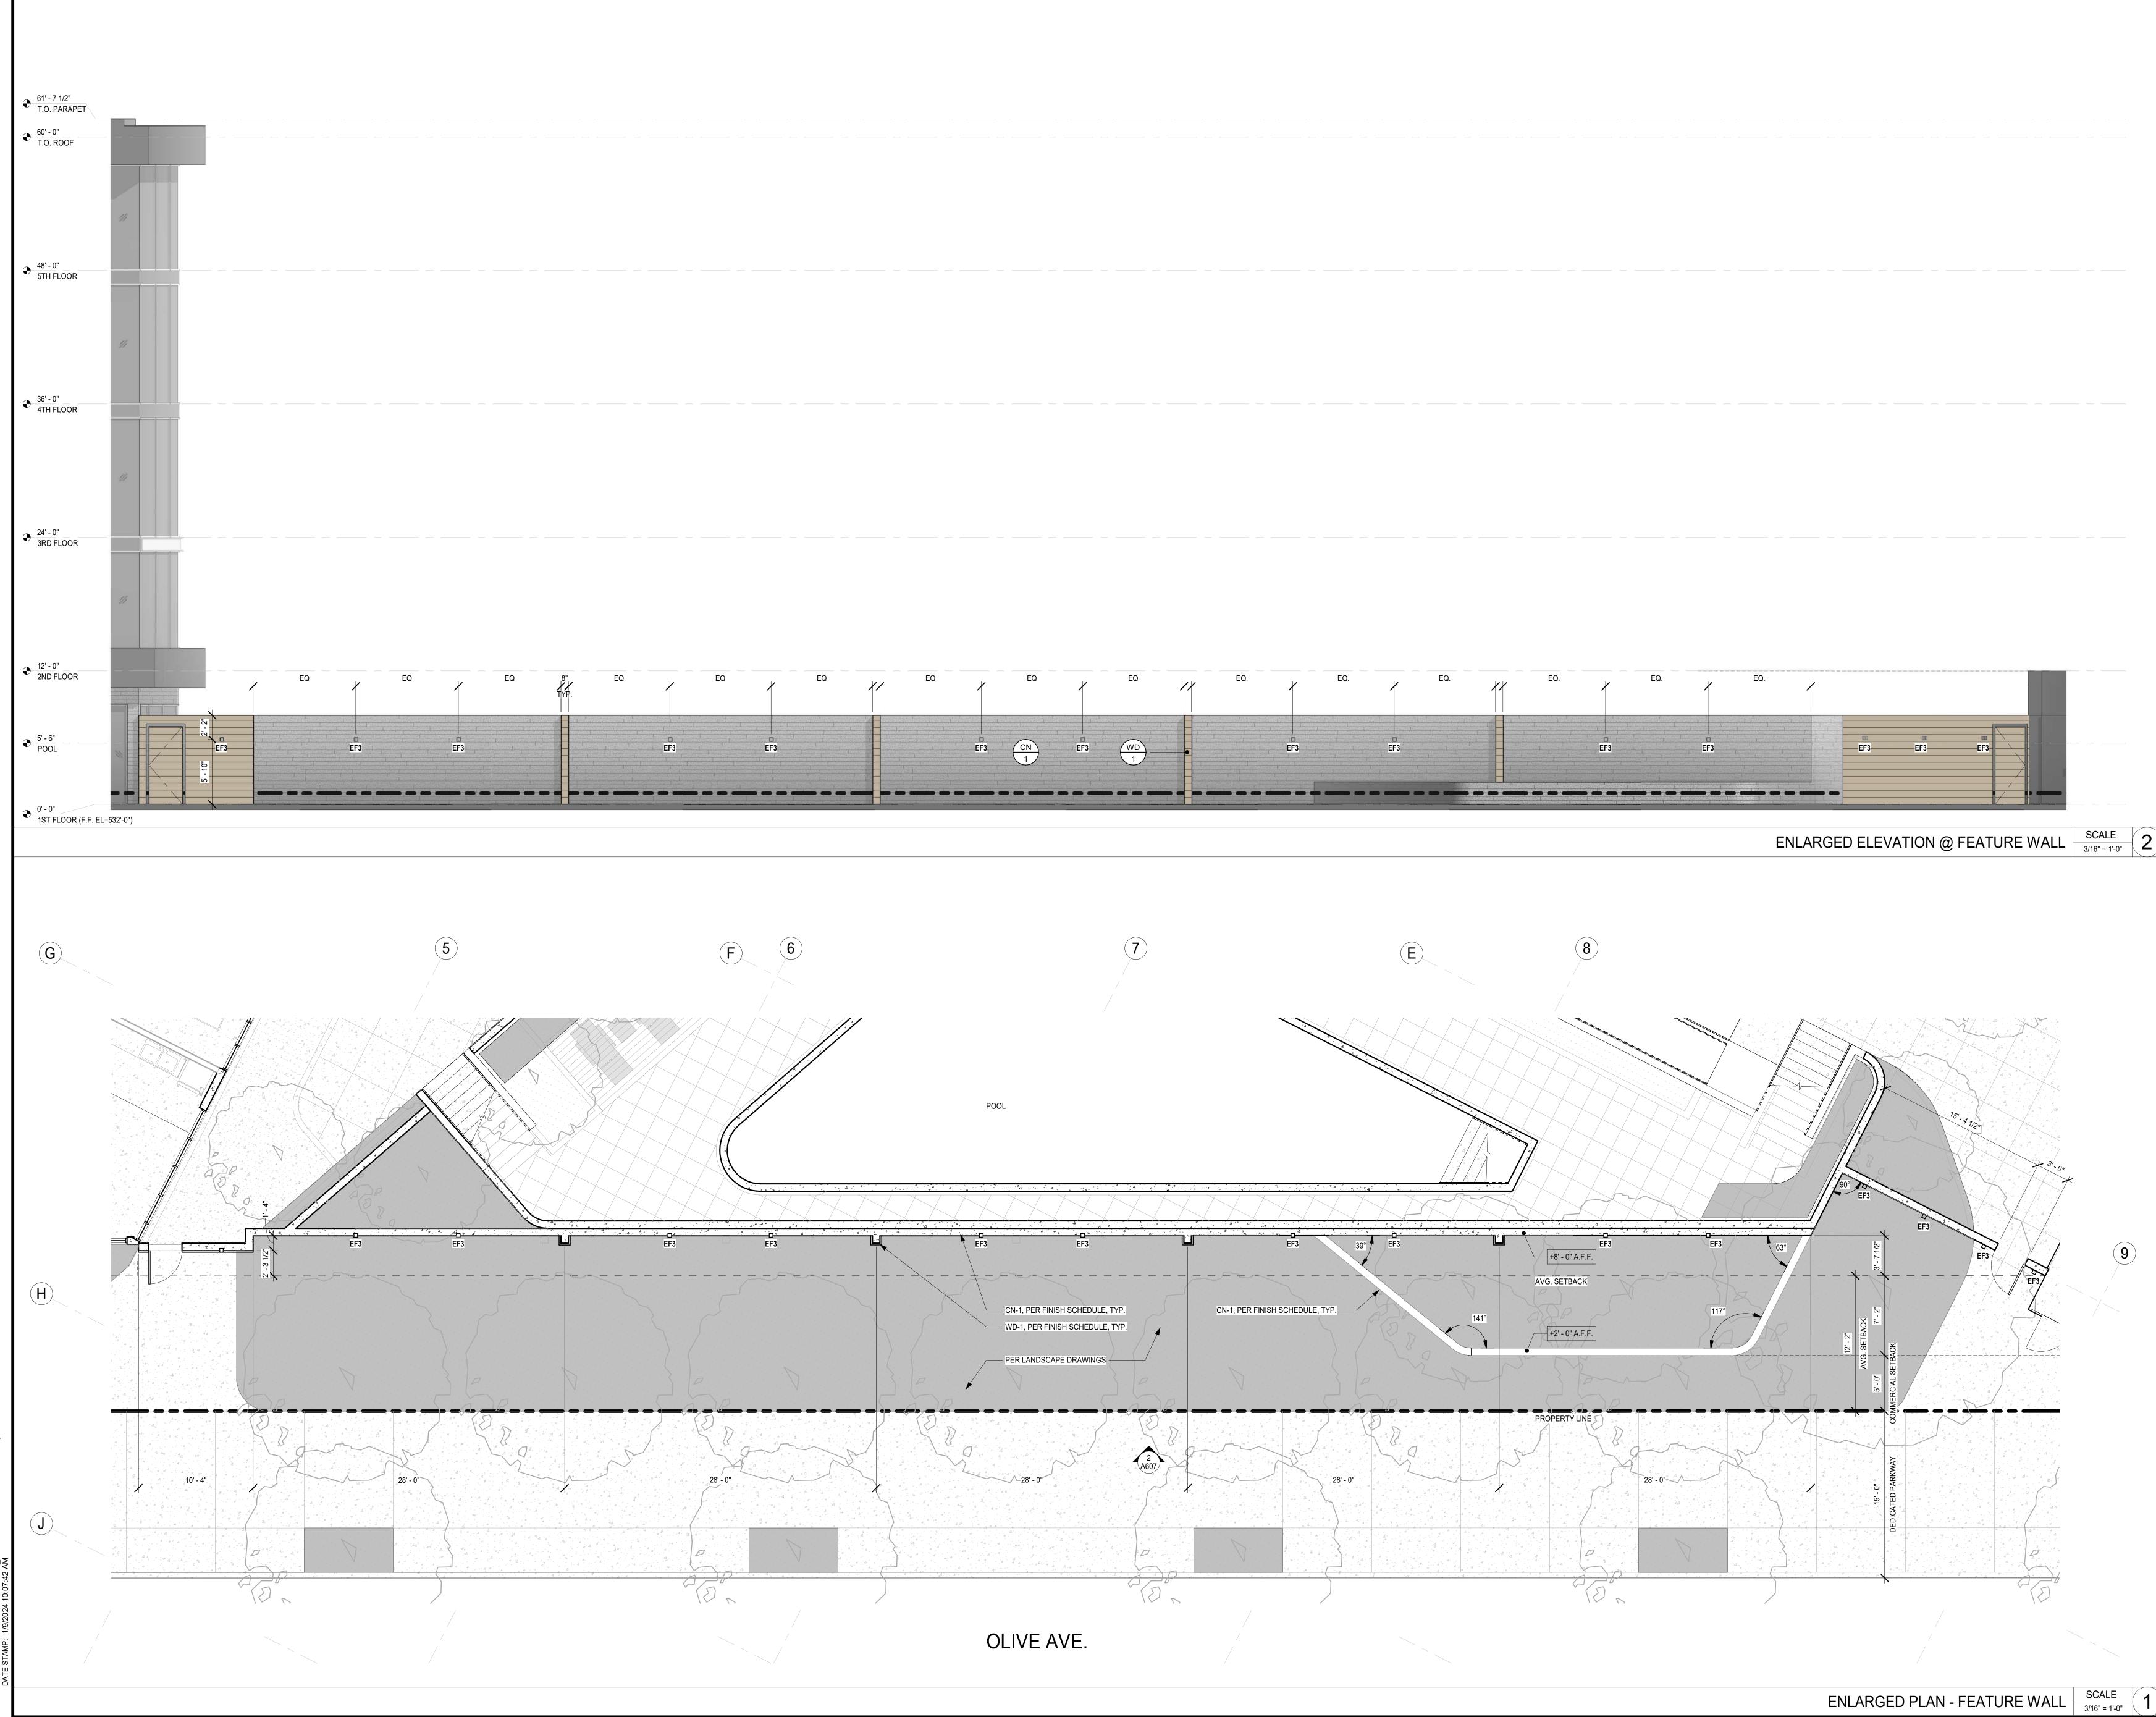
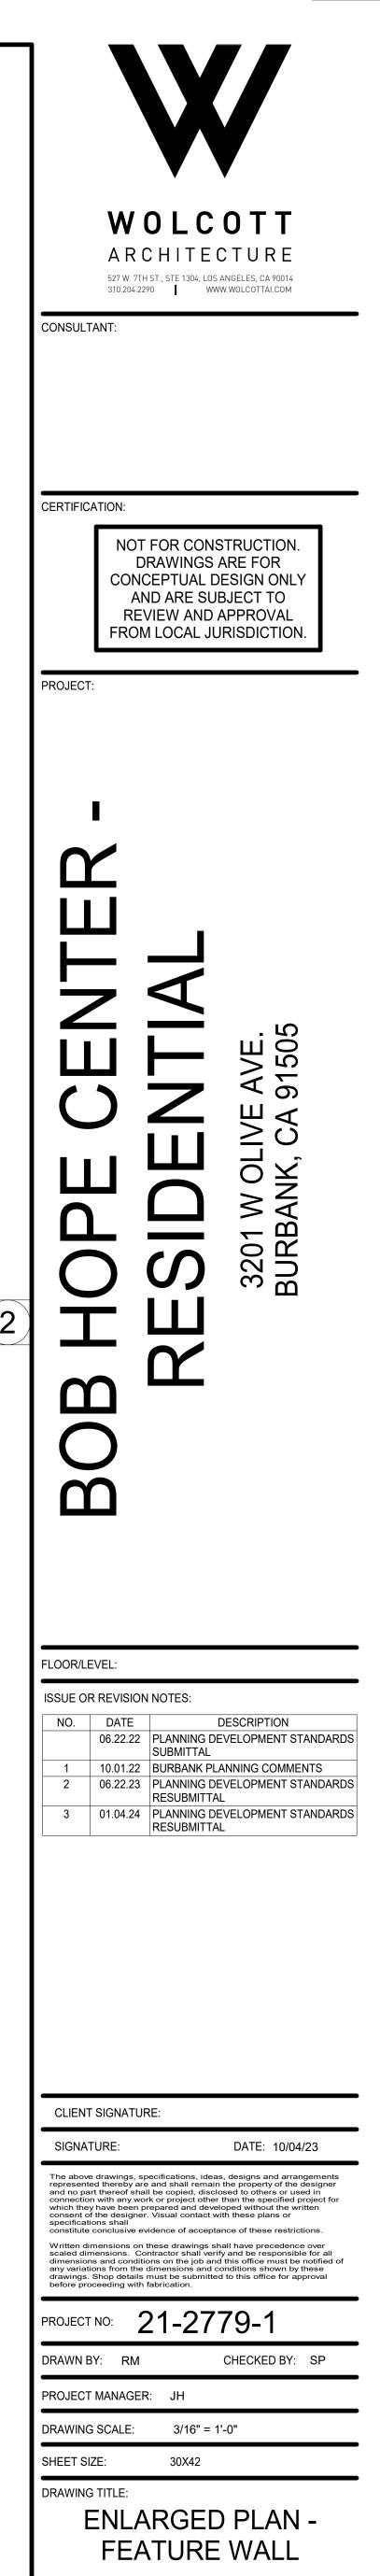
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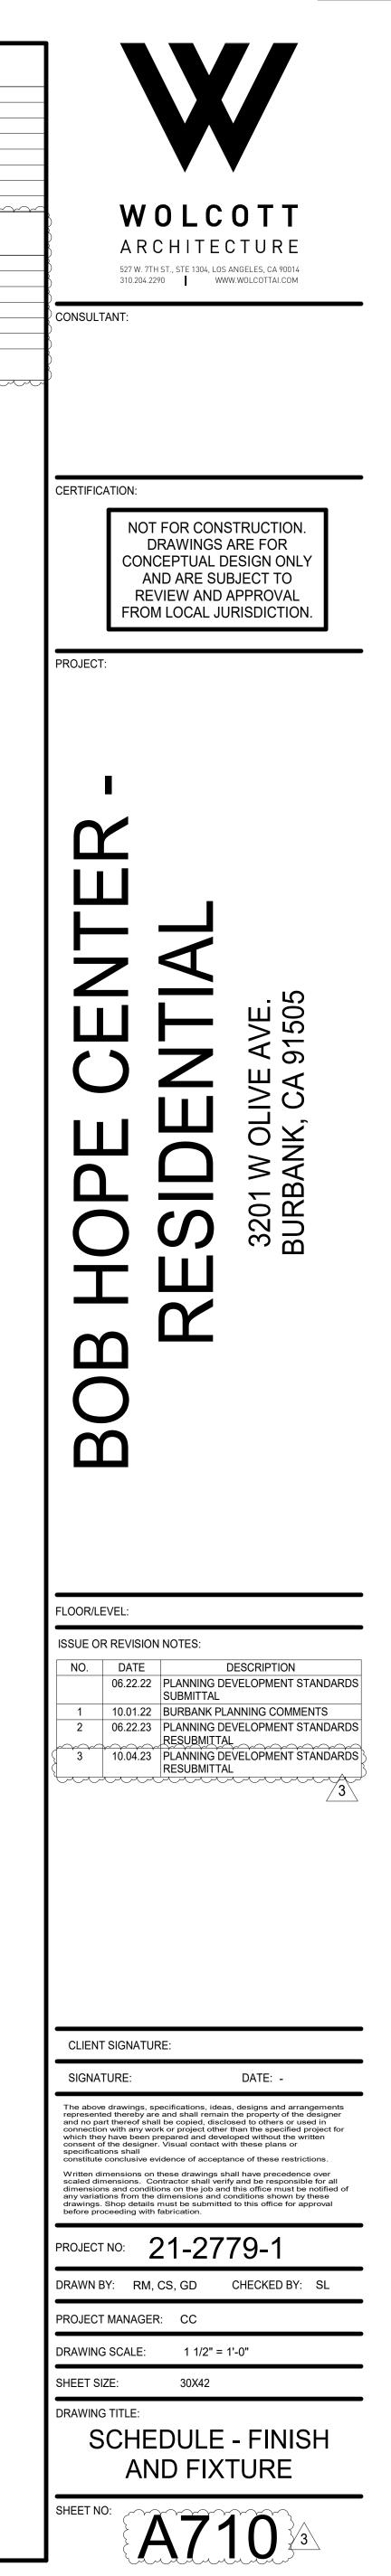
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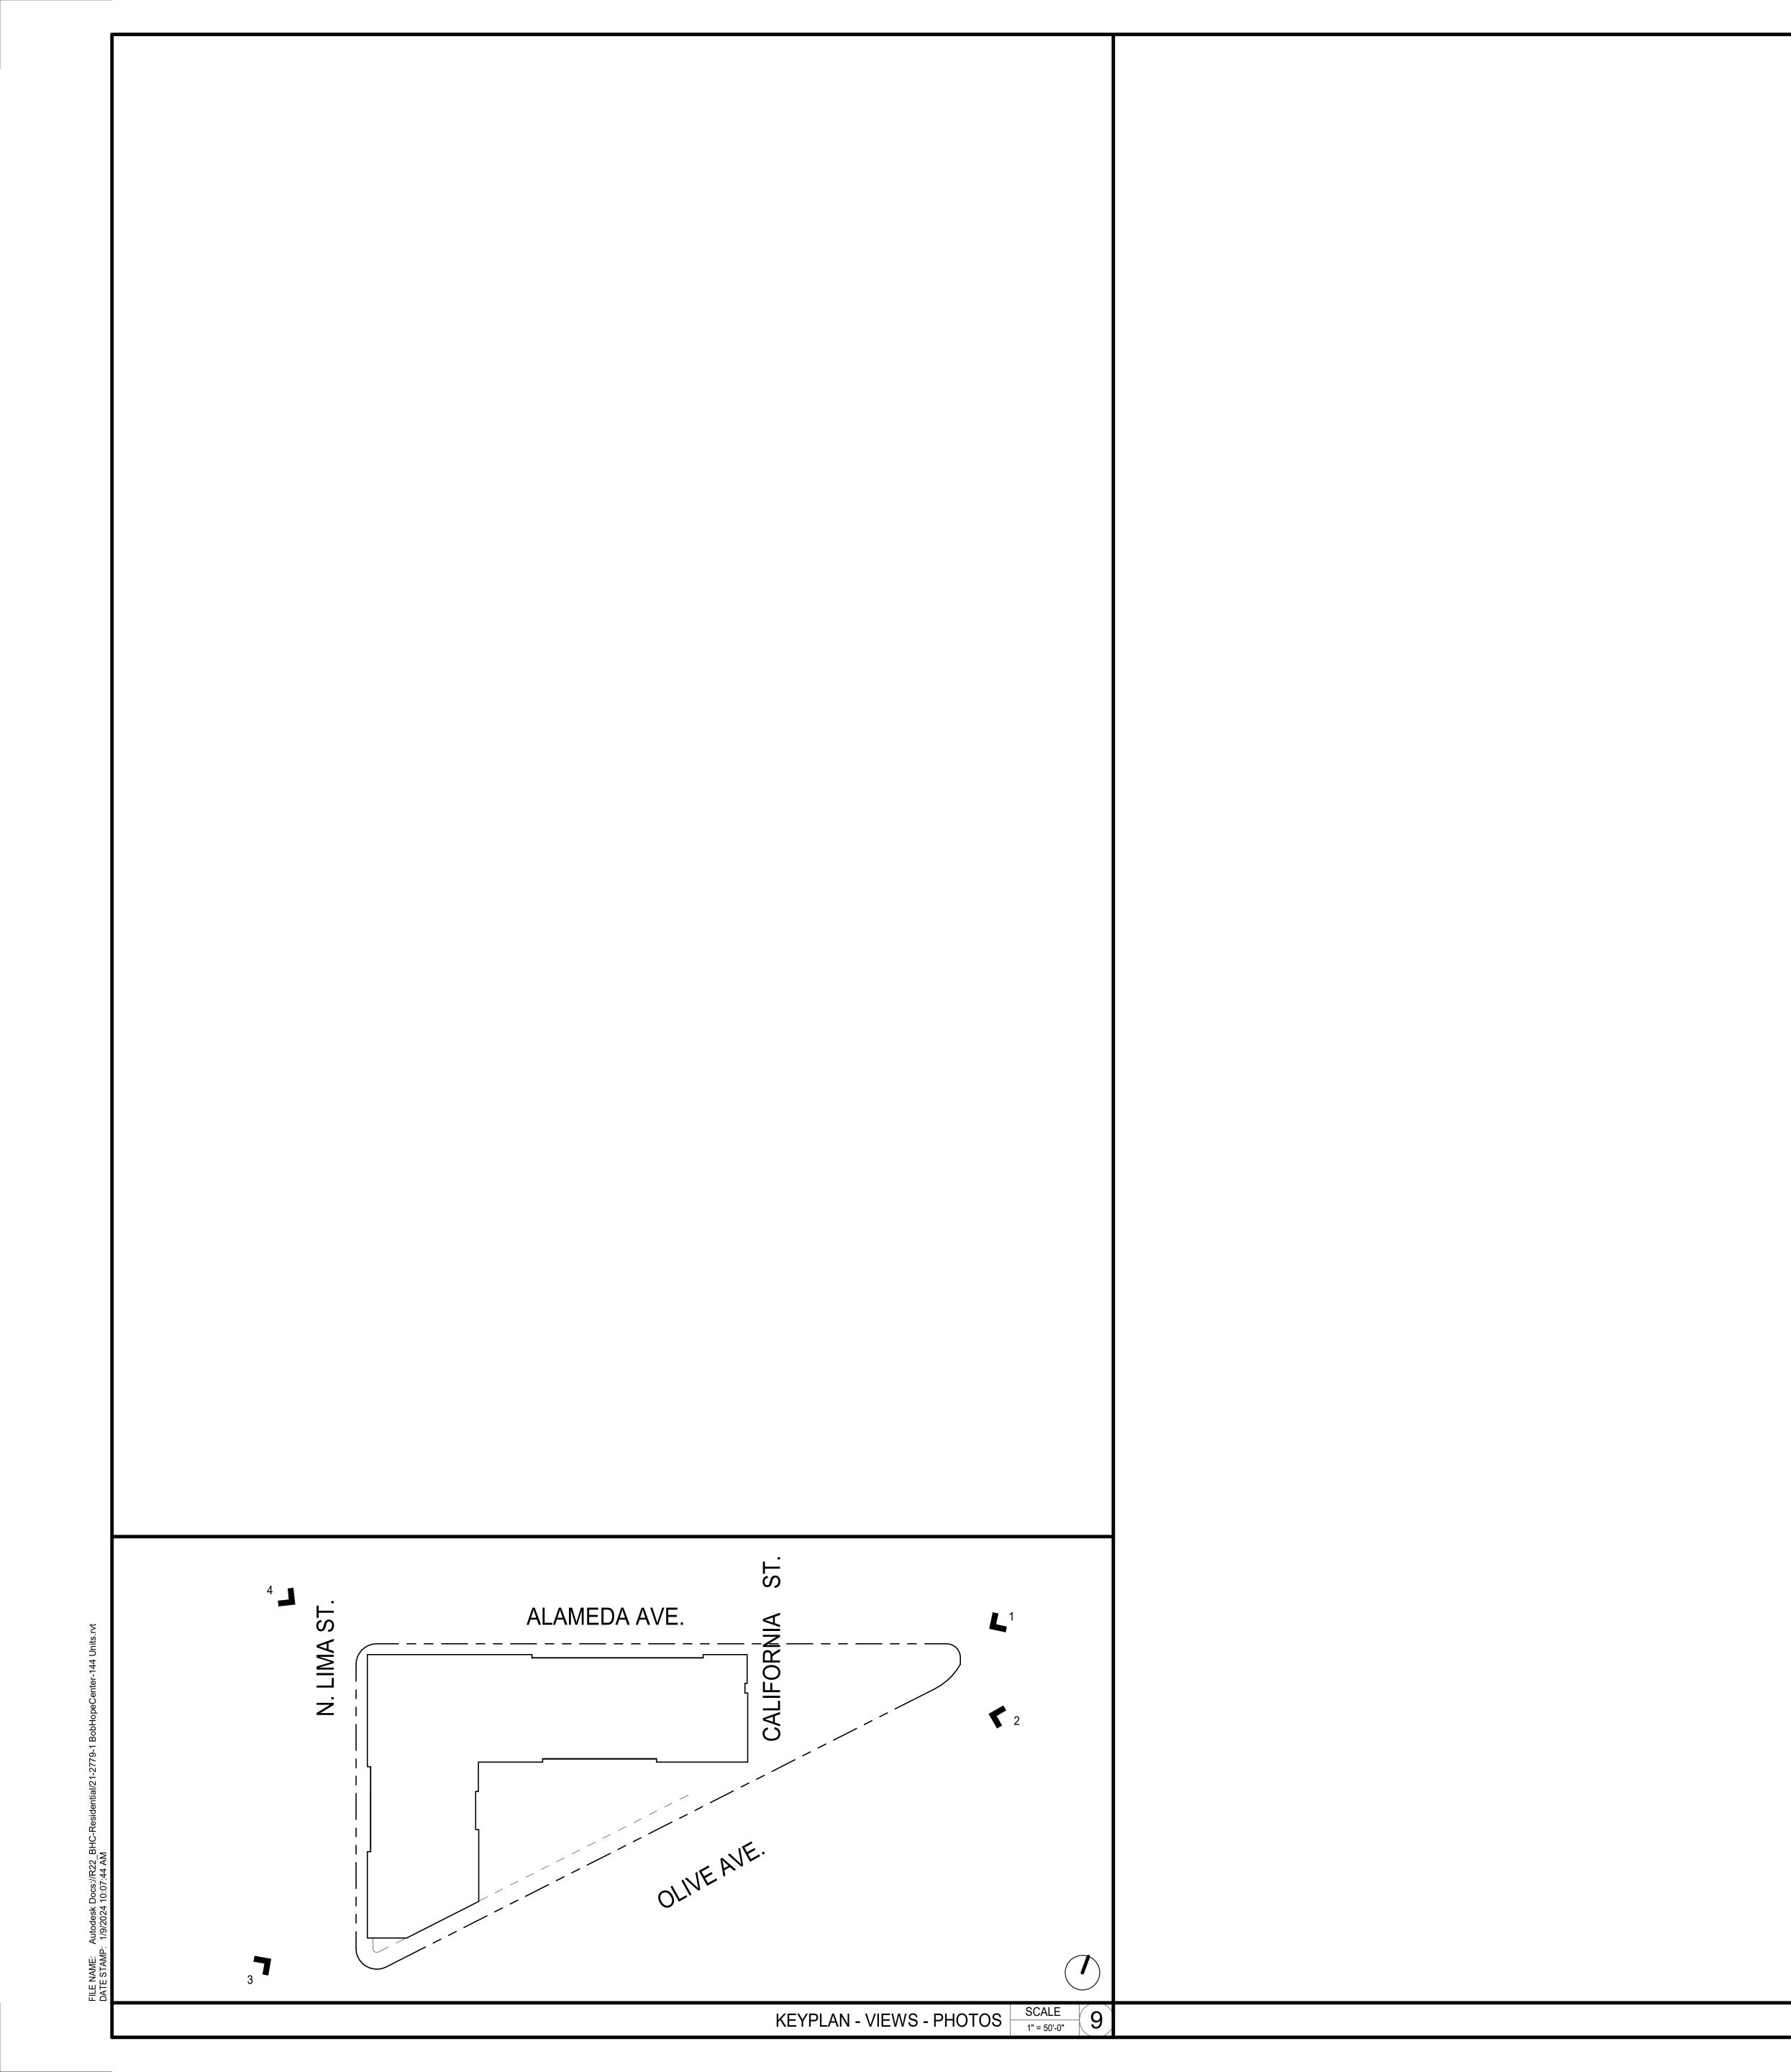
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Residentia		
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FILE NAME: Autodesk Docs://R22_BHC-Residential/21-2779-1 BobHopeCenter-144 Units.rvt DATE STAMP: 10/4/2023 5:15:32 PM		
FILE N. DATE S		
	l F	PT.



	FINISH SCHEDULE		
IANUFACTURER	SPECIFICATION	LOCATION	NOTES
	-	SEE FINISH PLAN	-
	BOARD-FORMED CONCRETE	SEE FINISH ELEVATION	DAVIS COLORS, DARK GREY (CARBON) 8084
LUMABOARD	ALUMABOARD FW-10: CHARCOAL	SEE FINISH ELEVATION	-
ETAL SALES	TLC-1, 22 GA. FLAT SEAM METAL PANEL	SEE FINISH ELEVATION	COLOR TO MATCH PT-1
	STEEL BARSTOCK HANDRAIL	SEE FINISH ELEVATION	COLOR TO MATCH PT-2
RESPA	METEON-LOFT BROWN	SEE FINISH ELEVATION	-
IFS	EIES PAINTED	SEE FINISH ELEVATION	PAINTED PT-1

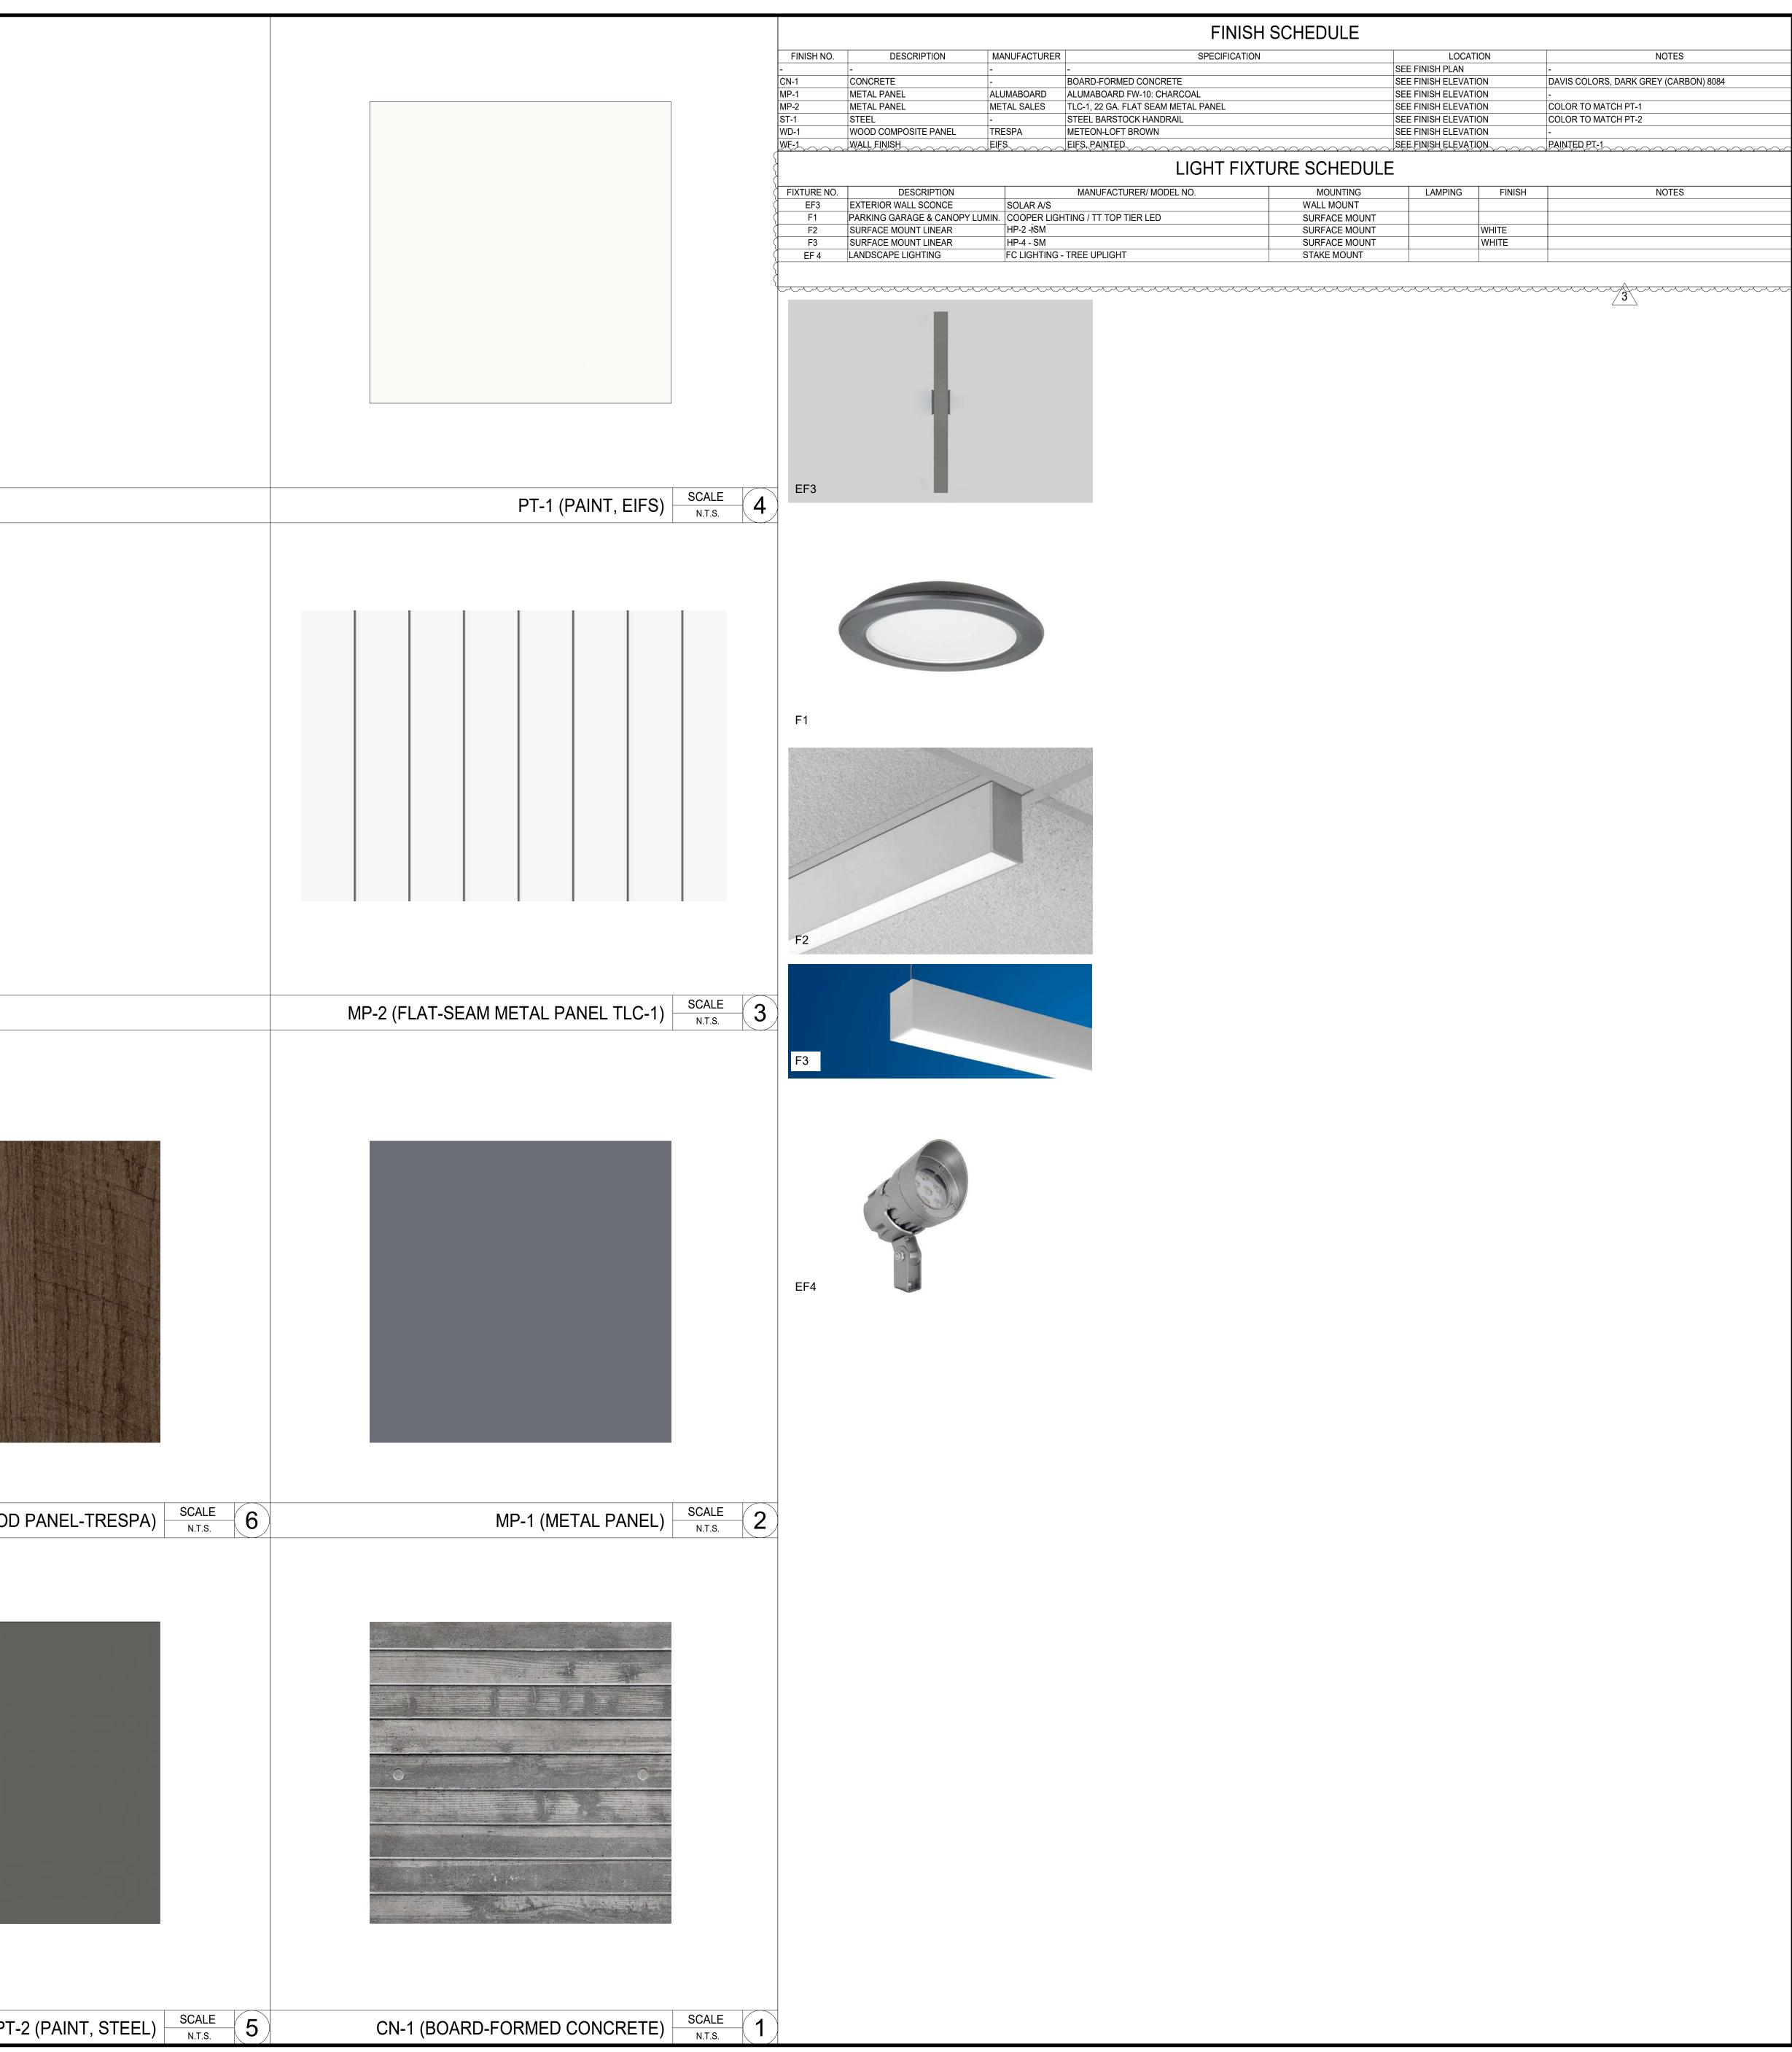
NISH	EIFS, PAINTED		SEE FINISH ELEVATIO	2NN	PAINTED PT-1
	LIGHT FIXTU	IRE SCHEDULE			
DESCRIPTION	MANUFACTURER/ MODEL NO.	MOUNTING	LAMPING	FINISH	NOTES
OR WALL SCONCE	SOLAR A/S	WALL MOUNT			
G GARAGE & CANOPY LUMIN.	COOPER LIGHTING / TT TOP TIER LED	SURFACE MOUNT			
E MOUNT LINEAR	HP-2 -	SURFACE MOUNT		WHITE	
E MOUNT LINEAR	HP-4 - SM	SURFACE MOUNT		WHITE	
APE LIGHTING	FC LIGHTING - TREE UPLIGHT	STAKE MOUNT			
					·










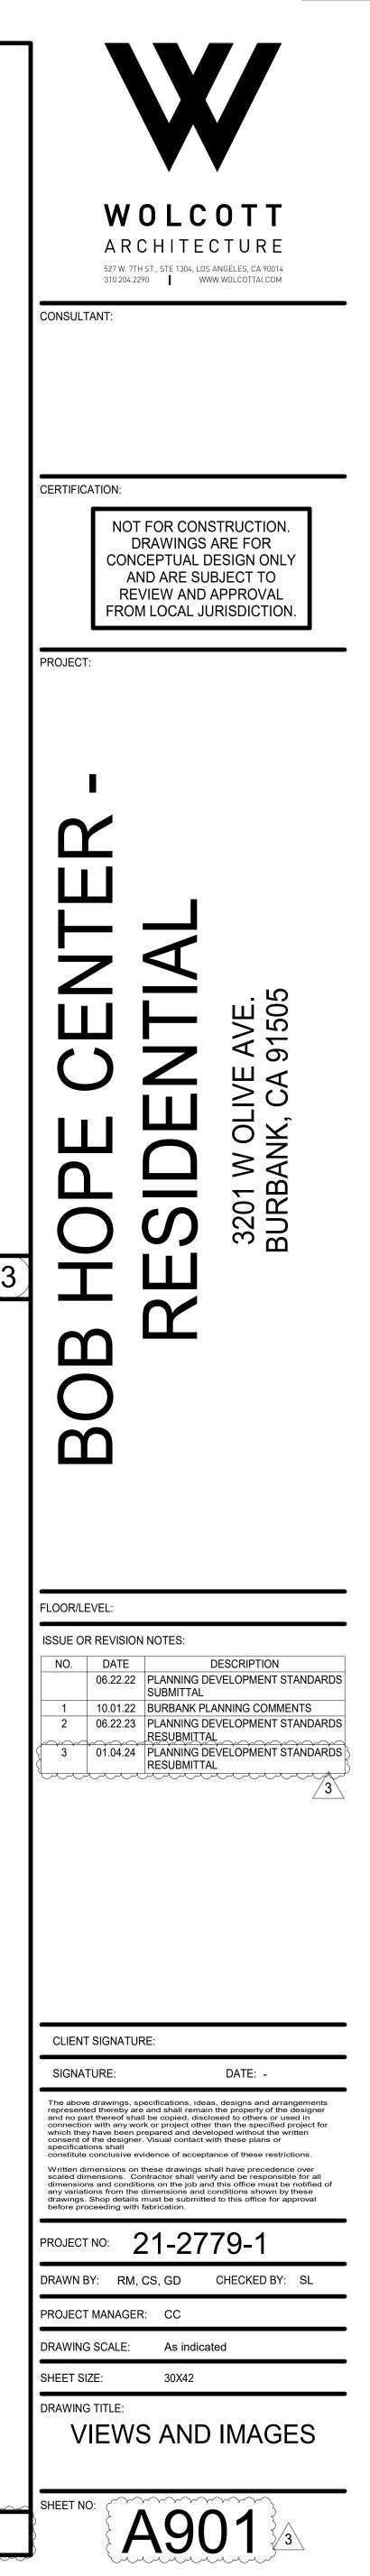



14	
10	
15	
	265' 14 14 200' 10 10 10 290' 15 16

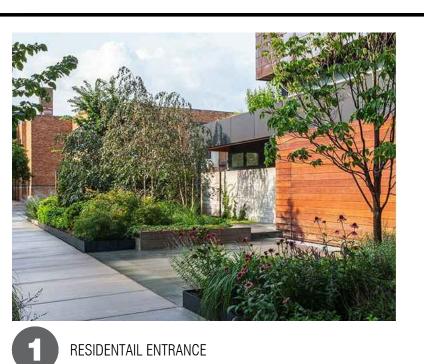





Los Angeles, California

Project Name:




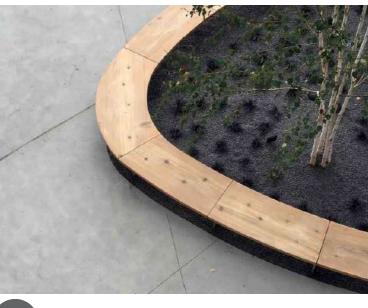

3 BANQUETTE SEATING

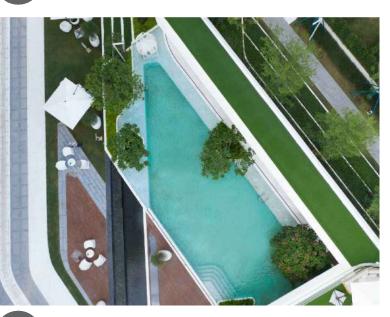




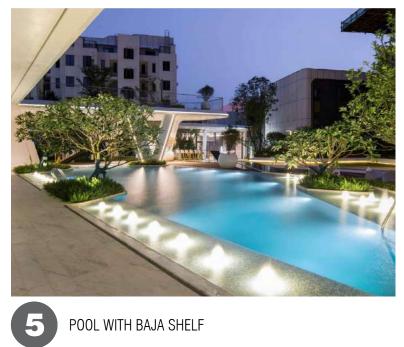



6 POOL ACCENT PLANTERS




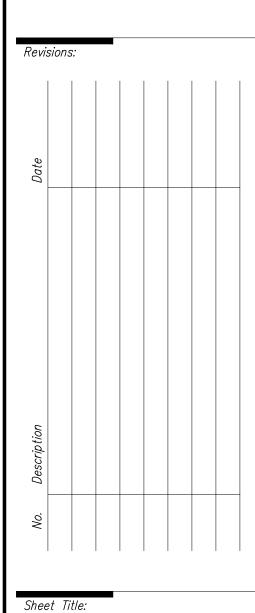


OVERALL	LANDSCAPE
CONCEPT	Plan

Date: 10-04-2023 Scale: AS NOTED Sheet Number:

L1.0

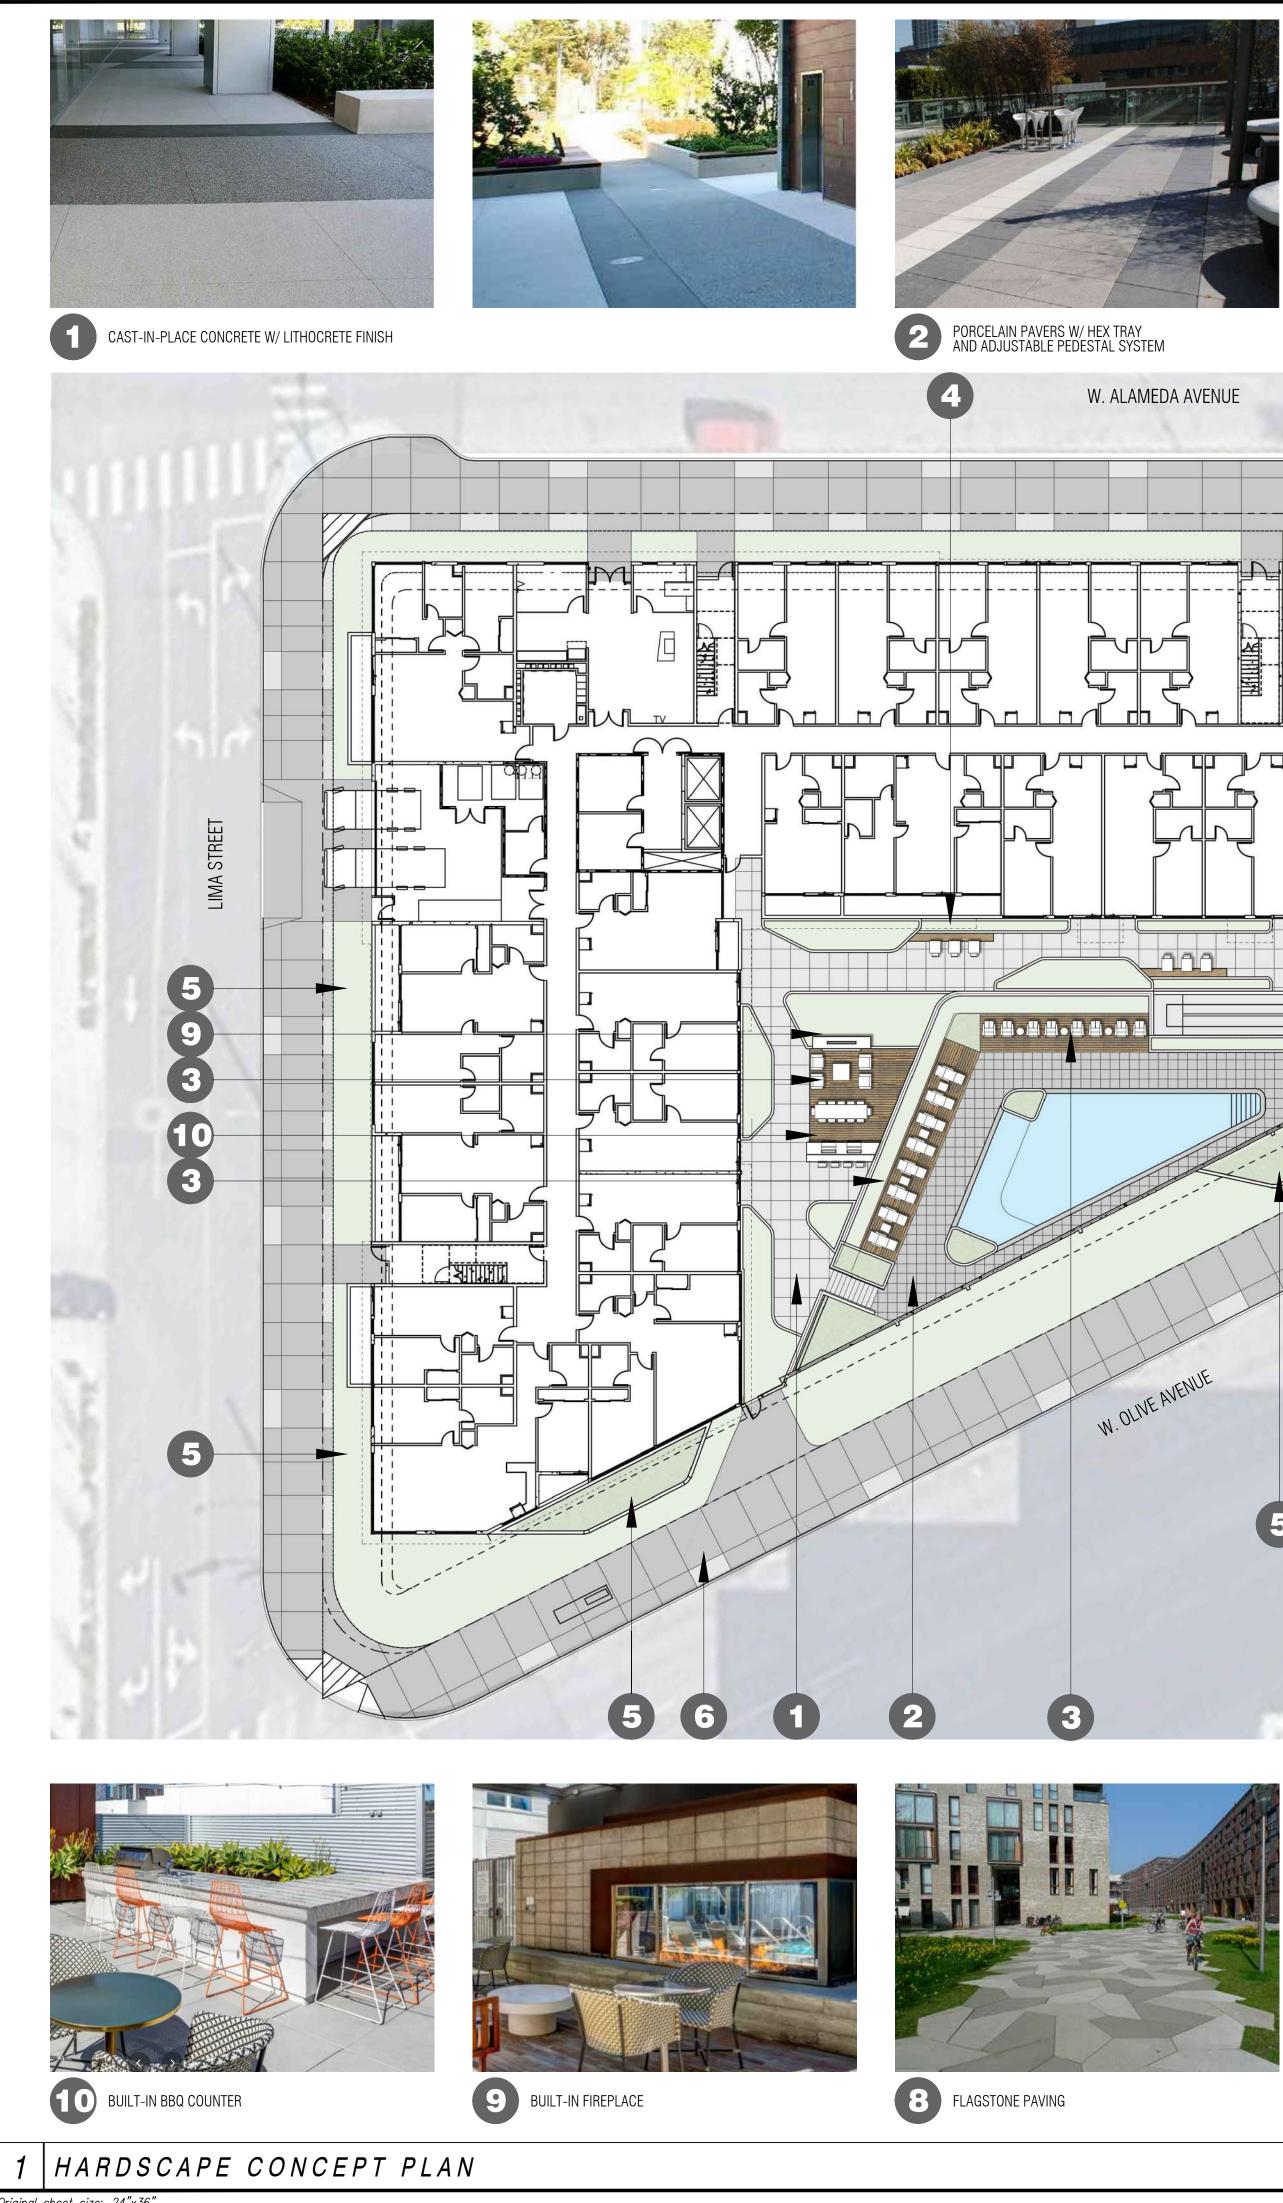

Original sheet size: 24"x36"

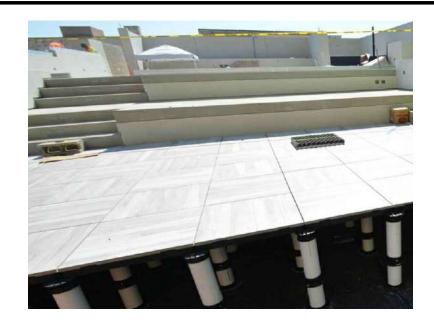




(7 ______ PARKING ENTRY RAMP PARKING EXIT RAMP RESIDENT GYM 200 868 SF LOUNGE RETAIL (7) 1 52 $\left(\mathbf{1}\right)$







CAST-IN-PLACE CONCRETE SEATWALLS W/ LITHOCRETE FINISH

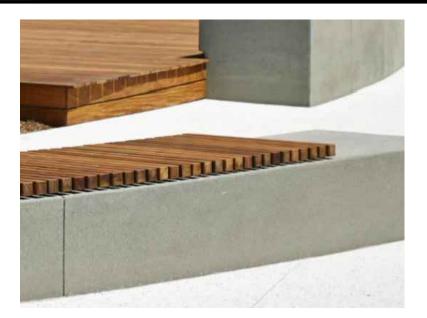

COMPOSITE OR HARDWOOD DECKING BENCH



Los Angeles, California

Project Name:



(4)


5



PROPOSED PLANTER AREA - CAST-IN-PLACE CONCRETE WALLS W/ LITHOCRETE FINISH

6 CAST-IN-PLACE CONCRETE SIDEWALK W/ TOPCAST FINISH

Center roject Hope BURBANK CA sidential Bob **N** The

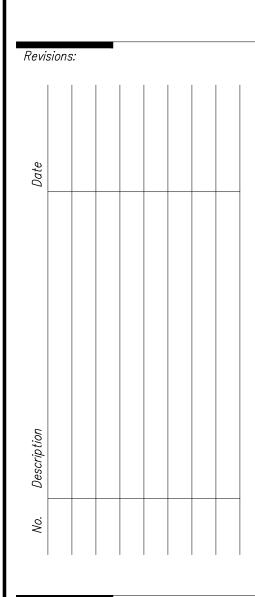

Sheet Title:


HARDSCAPE CONCEPT PLAN

Date: 10-04-2023 Scale: AS NOTED Sheet Number: L1.1

SCALE: 1'' = 20' - 0''



Original sheet size: 24"x36"

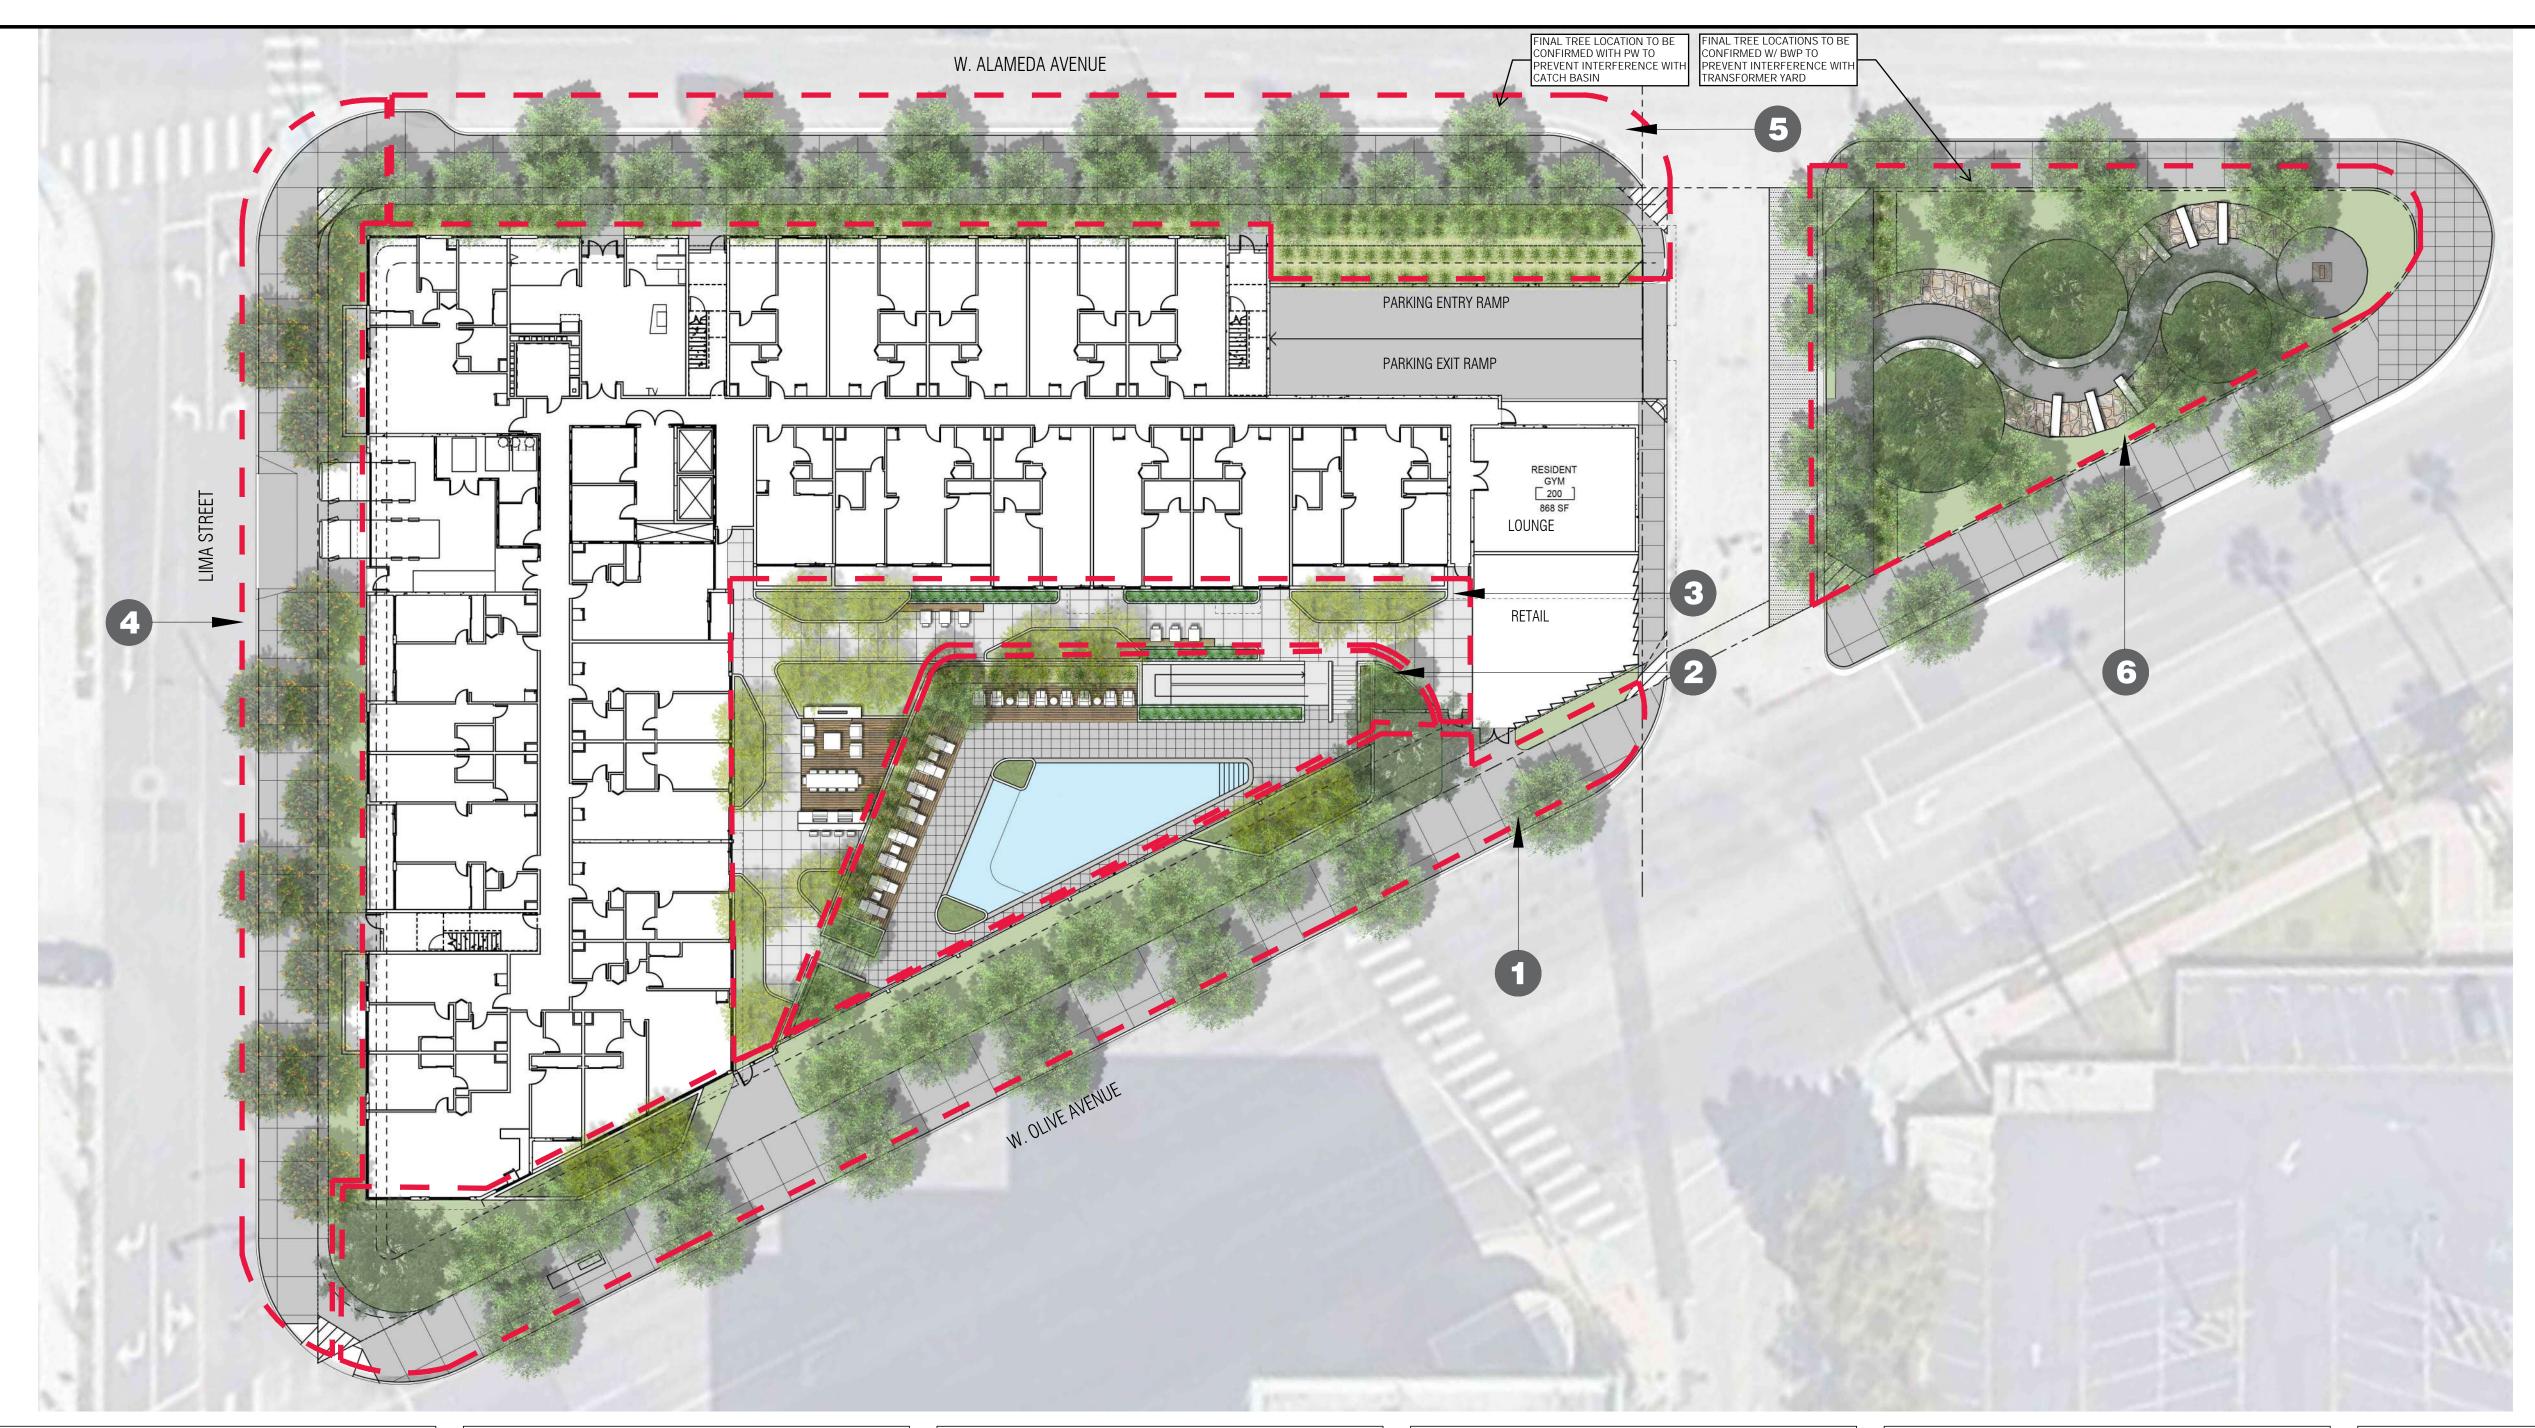

1 OLIVE AVENUE FRONTAGE

TREE S	SCHEDULE		
DESCRIPTION/BOTANICAL NAME	COMMON NAME	QTY	
OLEA EUROPAEA 'WILSONII'	FRUITLESS EUROPEAN OLIVE	8	
CERCIDIUM 'DESERT MUSEUM'	DESERT MUSEUM PALO VERDE	5	
PROSOPIS CHILENSIS	CHILEAN MESQUITE		
SHRUB	SCHEDULE		
DESCRIPTION/BOTANICAL NAME	COMMON NAME	QTY	
ACACIA COGNATA 'COUSIN ITT'	COUSIN ITT ACACIA	47	
AEONIUM 'SUNBURST'	SUNBURST AOENIUM	96	
ANIGOZANTHOS 'HARMONY'	RED-YELLOW KANGAROO PAW	96	
BULBINE FRUTESCENS	STALKED BULBINE	63	
CALANDRINIA SPECTABILIS	ROCK PURSLANE	246	
COPROSMA KIRKII	KIRK'S COPROSMA	37	
DIANELLA REVOLUTA 'LITTLE REV'	LITTLE REV FLAX LILY	246	
FESTUCA GLAUCA 'ELIJAH BLUE'	BLUE FESCUE GRASS	878	
FURCRAEA FEOTIDA 'MEDIOPICTA'	NCN	12	
HESPERALOE PARVIFLORA 'YELLOW'	YELLOW YUCCA	68	
OLEA EUROPAEA 'MONTRA'	LITTLE OLLIE	60	
PORTULICARIA AFRA 'VARIEGATA'	ELEPHANT BUSH	- 24	
ROSMARINUS OFFICINIALIS 'PROSTRATATUS'	CREEPING ROSEMARY	24	
VERBENA LILACINA 'DE LA MINA'	PURPLE CEDROS ISLAND VERBENA	63	

2 POOL DEC	CK		3 RESIDENTI,	AL DECK		
TREE SCHEDULE		TREE SCHEDULE				
DESCRIPTION/BOTANICAL NAME	COMMON NAME	QTY	DESCRIPTION/BOTANICAL NAME	COMMON NAME	QTY	
BAUHINIA X BLAKEANA	HONG KONG ORCHID TREE	3	KOELREUTERIA BIPINNATA	CHINESE FLAME TREE	14	
CASSIA LEPTOPHYLLA	GOLD MEDALLION TREE	6	SHRUB SCHEDULE			
SHRUB SCHEDULE		DESCRIPTION/BOTANICAL NAME	COMMON NAME	QTY		
DESCRIPTION/BOTANICAL NAME	COMMON NAME	QTY	ABELIA GRANDIFLORA 'RADIANCE'	RADIANCE ABELIA	86	
ALOE 'HERCULES'	HERCULES ALOE	2	BOUGAINVILLEA 'LA JOLLA'	NCN	21	
ALPINIA ZERUMBET 'VARIEGATA'	VARIEGATED SHELL GINGER	22	LANTANA CAMARA 'SPREADING SUNSET'	SPREADING SUNSET LANTANA	21	
ASPARAGUS DENSIFLORUS 'MYERSII'	FOXTAIL FERN	14	LOTUS BERTHELOTI	PARROT'S BEAK	85	
LOMANDRA CONFERTIFOLIA 'SHORTY'	DWARF MAT RUSH	136	NANDINA DOMESTICA 'LEMON LIME'	HEAVENLY BAMBOO	53	
LOTUS BERTHELOTI	PARROT'S BEAK	18	PITTOSPORUM CRASSIFOLIUM 'NANA'	DWARF KARO	70	
TRADESCANTIA SPATHACEA	MOSES IN THE CRADLE	37	POLYGALA FRUTICOSA 'PETITE BUTTERFLIES'	SWEET PEA SHRUB		
ZAMIA FURFURACEA	SAGO CYCAS	92				

CONCEPTUAL PLANTING PLAN

Original sheet size: 24"x36"

3 RESIDENTIAL DECK

AND LID	EET FRONTAGE PLANTER			
TREE S	SCHEDULE			
DESCRIPTION/BOTANICAL NAME	COMMON NAME	<i>QTY</i>		
MAYTENUS BOARIA	MAYTEN TREE	g		
PYRUS CALLERYANA 'BRADFORD'	BRADFORD PEAR	9		
SHRUB SCHEDULE				
DESCRIPTION/BOTANICAL NAME	COMMON NAME	οτγ		
ACHILLEA 'MOON SHINE'	YARROW	181		
		101		
ALOGYNE HUEGLII	BLUE HIBISCUS	12		
ALOGYNE HUEGLII BACCHARIS PILULARIS 'PIGEON POINT'	BLUE HIBISCUS DWARF COYOTE BRUSH			
		12		
BACCHARIS PILULARIS 'PIGEON POINT'	DWARF COYOTE BRUSH	12 18		
BACCHARIS PILULARIS 'PIGEON POINT' CHONDROPETALUM TECTORUM	DWARF COYOTE BRUSH SMALL CAPE RUSH	12 18 45		

5 ALAMEDA . NORTH SID	AVENUE DE PLANTING		
TREE SCHEDULE			
DESCRIPTION/BOTANICAL NAME	COMMON NAME	QTY	
ARBUTUS 'MARINA'	STRAWBERRY TREE	6	
RHUS LANCEA	AFRICAN SUMAC	11	
SHRUB SCHEDULE			
DESCRIPTION/BOTANICAL NAME	COMMON NAME	QTY	
CAREX DIVULSA	EUROPEAN GREY SEDGE	1,230	
CARISSA MACROCARPA 'GREEN CARPET'	NATAL PLUM	75	
DIETES VEGETA 'VARIEGATA'	VARIEGATED FORTNIGHT LILY	310	
MUHLENBERGIA LINDHEIMERI	LINDHEIMER'S MUHLY	128	
PENNISETUM SPATHIOLATUM	SLENDER VELDT GRASS	1,230	
WESTRINGIA FRUTICOSA 'MORNING LIGHT'	COAST ROSEMARY	128	

Oft.	10ft.	20ft.
GRA	PHIC SC/	ALE

6	BOB	HOPE	PARK

TREE SCHEDULE			
DESCRIPTION/BOTANICAL NAME	COMMON NAME	QTY	
CINNAMOMUM CAMPHORA	CAMPHOR TREE		
TIPUANA TIPU	TIPU TREE	2	
SPATHODEA CAMPANULATA	AFRICAN TULIP TREE	6	
SHRUB	SCHEDULE		
DESCRIPTION/BOTANICAL NAME	COMMON NAME	QTY	
COREOPSIS LANCEOLATA 'EARLY SUNRISE'	DOUBLE FLOWERED YELLOW TICKSEED	180	
DIETES BICOLOR	FORTNIGHT LILY	- 72	
LOMANDRA 'PLATINUM BEAUTY'	PLATINUM BEAUTY MAT RUSH		
HEBE 'GIBBY'	GIBBY HEBE	45	
OLEA EUROPAEA 'MONTRA'	LITTLE OLLIE		
FESTUCA RUBRA 'MOLATE'	CREEPING RED FESCUE GRASS	1,816 S.F. FLATS	



Project Name:


Center Project Hope BURBANK CA Residential Bob The Revisions: Sheet Title:

CONCEPTUAL PLANTING PLAN

Date: 10–04–2023

Scale: AS NOTED


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OLIVE AVENUE FRONTAGE

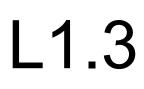

CERCIDIUM 'DESERT MUSEUM' DESERT MUSEUM PALO VERDE



OLEA EUROPAEA 'WILSONII' FRUITLESS EUROPEAN OLIVE

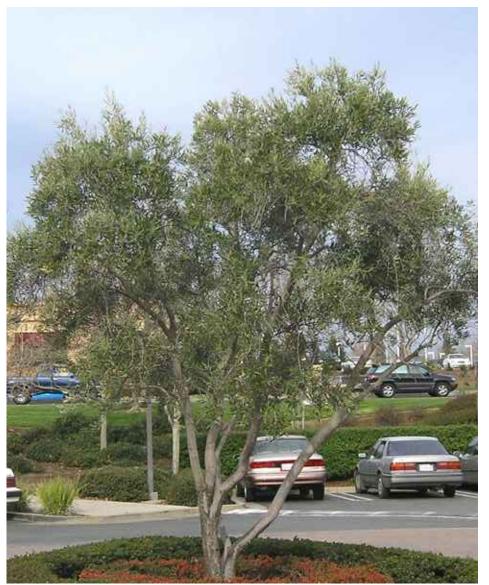OLIVE AVE CONTINUED



FURCRAEA FOETIDA 'MEDIOPICTA' NCN



HESPERALOE PARVIFLORA 'YELLOW' YELLOW YUCCA





PORTULICARIA AFRA 'VARIEGATA' ELEPHANT BUSH



ROSMARINUS OFFICINALIS 'PROSTRATUS' CREEPING ROSEMARY



VERBENA LILACINA 'DE LA MINA' PURPLE CEDROS ISLAND VERBENA



BAUHINIA X BLAKEANA HONG KONG ORCHID TREE

3 RESIDENTIAL DECK



KOELREUTERIA BIPINNATA CHINESE FLAME TREE







ABELIA GRANDIFLORA 'RADIANCE' RADIANCE ABELIA



NANDINA DOMESTICA 'LEMON LIME' HEAVENLY BAMBOO



BOUGAINVILLEA 'LA JOLLA' NCN



PITTOSPORUM CRASSIFOLIUM 'NANA' DWARF KARO





ACACIA COGNATA 'COUSIN ITT' COUSIN ITT ACACIA



CALANDRINIA SPECTABILIS ROCK PURSLANE



AEONIUM 'SUNBURST' SUNBURST AOENIUM



COPROSMA KIRKII KIRK'S COPROSMA

2 POOL DECK



CASSIA LEPTOPHYLLA GOLD MEDALLION TREE



ALOE 'HERCULES' HERCULES ALOE




ALPINIA ZERUMBET 'VARIEGATA' VARIEGATED SHELL GINGER



LOTUS BERTHELOTII PARROT'S BEAK



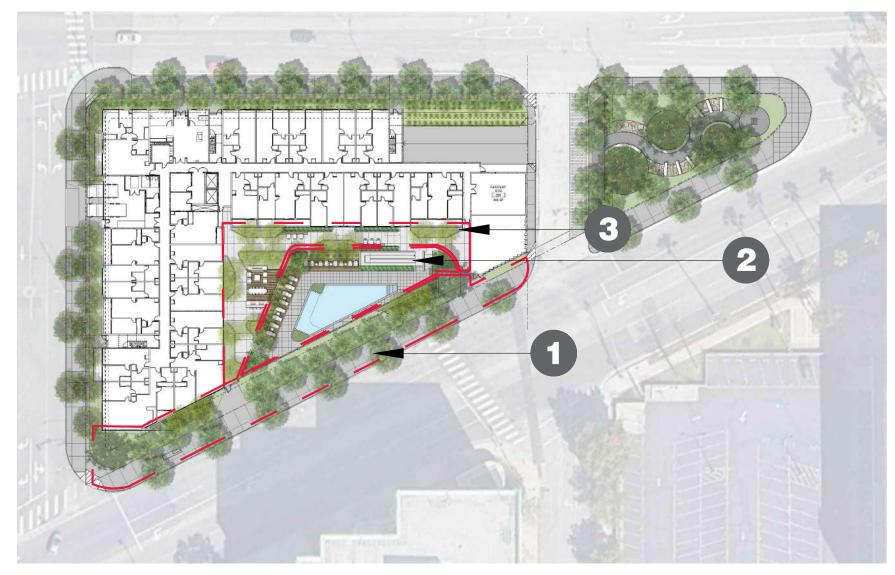



LANTANA CAMARA 'SPREADING SUNSET SPREADING SUNSET LANTANA



POLYGALA FRUTICOSA 'PETITE BUTTERFLIES' SWEET PEA SHRUB



LOTUS BERTHELOTII PARROT'S BEAK



RHAPHIOLEPIS UMBELLATA 'MINOR' DWARF YEDDO HAWTHORN



ANIGOZANTHOS 'HARMONY' RED-YELLOW KANGAROO PAW



DIANELLA REVOLUTA 'LITTLE REV' LITTLE REV FLAX LILY



BULBINE FRUTESCENS STALKED BULBINE



FESTUCA GLAUCA 'ELIJAH BLUE' BLUE FESCUE GRASS





ASPARAGUS DENSIFLORUS 'MYERSII' FOXTAIL FERN



LOMANDRA CONFERTIFOLIA 'SHORTY' DWARF MAT RUSH



TRADESCANTIA SPATHACEA MOSES IN THE CRADLE



ZAMIA FURFURACEA SAGO CYCAS



Los Angeles, California

Project Name:



Revisions:


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PLANT IMAGES

Date: 10-04-2023 AS NOTED Sheet Number:

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IIMA STREET FRONTAGE AND LID PLANTERS



MAYTENUS BOARIA MAYTEN TREE

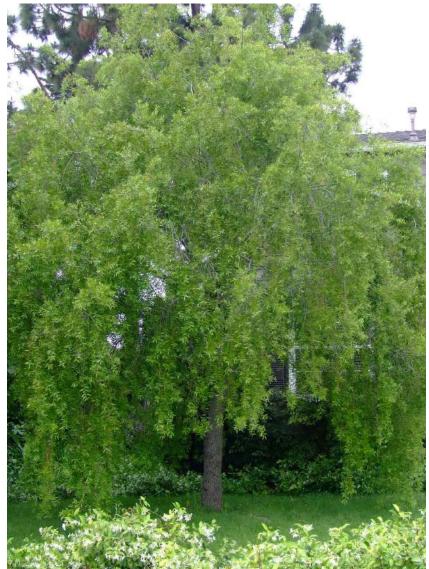PYRUS CALLERYANA 'BRADFORD' BRADFORD PEAR



ACHILLEA 'MOON SHINE' YARROW



CHONDROPETALUM TECTORUM SMALL CAPE RUSH

SALAMEDA AVENUE CONTINUED



CAREX DIVULSA EUROPEAN GREY SEDGE



CARISSA MACROCARPA 'GREEN CARPET' NATAL PLUM



DIETES VEGETA 'VARIEGATA' VARIEGATED FORTNIGHT LILY





PENNISETUM SPATHIOLATUM SLENDER VELDT GRASS



WESTRINGIA FRUTICOSA 'MORNING LIGHT' COAST ROSEMARY



6 BOB HOPE PARK, CONTINUED



COREOPSIS LANCEOLATA 'EARLY SUNRISE' DOUBLE FLOWERED YELLOW TICKSEED



HEBE 'GIBBY' GIBBY HEBE PLANT IMAGES



DIETES BICOLOR FORTNIGHT LILY



OLEA EUROPAEA 'MONTRA' LITTLE OLLIE



FESTUCA RUBRA 'MOLATE' CREEPING RED FESCUE GRASS



LOMANDRA 'PLATINUM BEAUTY' PLATINUM BEAUTY MAT RUSH

ALOGYNE HUEGLII BLUE HIBISCUS

BACCHARIS PILULARIS 'PIGEON POINT' DWARF COYOTE BRUSH



ZEPHRANTHUS CANDIDA RAIN LILY




ARBUTUS 'MARINA' STRAWBERRY TREE

LEYMUS CONDENSATUS 'CANYON PRINCE' CANYON PRINCE WILD RYE

6 BOB HOPE PARK

LOMANDRA HYSTRIX 'TROPIC BELLE'

TOPIC BELLE MAT RUSH

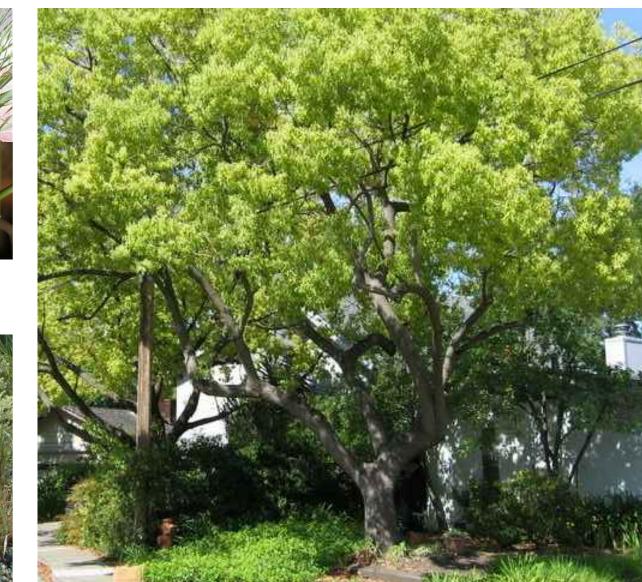


CINNAMOMUM CAMPHORA CAMPHOR TREE



SPATHODEA CAMPANULATA AFRICAN TULIP TREE

KEY MAP

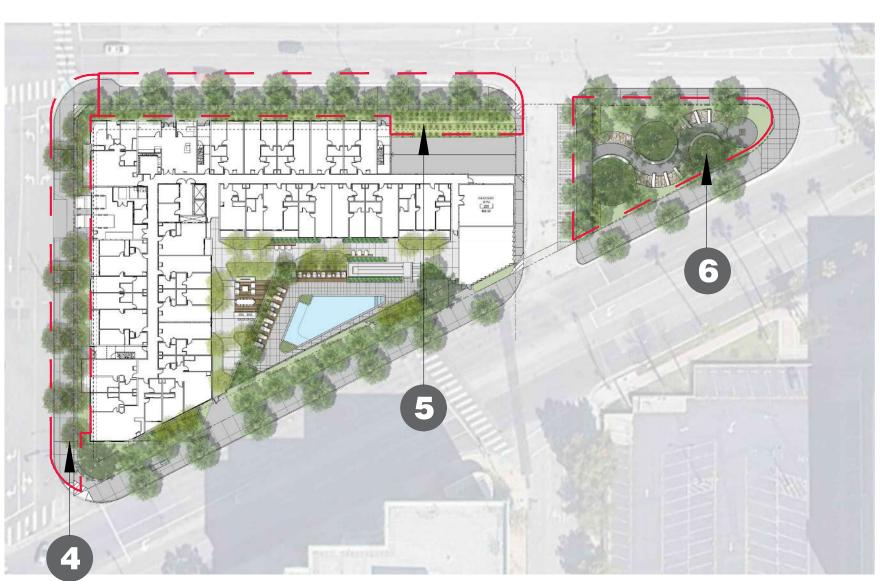

SALAMEDA AVE NORTH SIDE

RHUS LANCEA AFRICAN SUMAC







TIPUANA TIPU TIPU TREE



Los Angeles, California

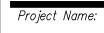

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PLANT IMAGES
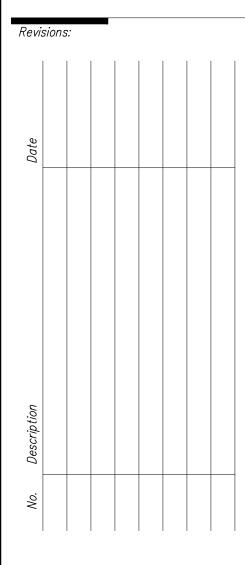
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